



COMMONWEALTH OF MASSACHUSETTS DEPARTMENT OF CONSERVATION AND RECREATION DIVISION OF PLANNING AND ENGINEERING

MASS CENTRAL RAIL TRAIL IN THE TOWNS OF HUDSON, STOW, MARLBOROUGH & SUDBURY MASSACHUSETTS MIDDLESEX COUNTY

DCR CONTRACT NO. P19-3295-D1A

INDEX

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(SHEETS GW-01 & GW-02 NOT INCLUDED)

(NOT INCLUDED)

GATEWAY DETAILS

CROSS SECTIONS

GW-01 - GW-05


XS-01 - XS-02

STA. 10+15.00 MAYNARD N 2969431.0001 646355.2282 SUDBURY HUDSON MARLBOROUGH PROJECT END **PROJECT** STA. 767+20.85 LOCATION N 2956449.4220 E 683648.1792 FRAMINGHAM

CHARLES D. BAKER, GOVERNOR KARYN E. POLITO, LT. GOVERNOR

KATHLEEN A. THEOHARIDES, SECRETARY **EXECUTIVE OFFICE OF ENERGY & ENVIRONMENTAL AFFAIRS**

JIM MONTGOMERY, INTERIM COMMISSIONER DEPARTMENT OF CONSERVATION & RECREATION

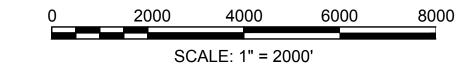

LENGTH OF PROJECT = 40,410.06 FEET = 7.653 MILES

SUDBURY STORMWATER PERMIT PLANS NOT APPROVED FOR CONSTRUCTION

ORIGINALLY SUBMITTED JULY 13, 2020 REVISED JOCTOBER 21, 2020 **REVISED DECEMBER 2. 2020**



COMMONWEALTH OF MASSACHUSETTS DEPARTMENT OF CONSERVATION AND RECREATION **DIVISION OF PLANNING AND ENGINEERING**

	MASS CENTRAL RAIL TRAIL - WAYSIDE				
MASS CENTRAL RAIL TRAIL HUDSON, STOW, MARLBOROUGH & SUDBURY, MA					
DESIGNER:JCR CHECKED: SHK	TITLE SHEET & INDEX	SHEET NO.			
		\sim 04			

SCALE: AS NOTED CONT. P19-3295-D1A CHECKED: TAL ACC. XXXXXXX DATE: **JAN 2021**

1 OF 1

REVISED JANUARY 13, 2021

GENERAL S	SVMBOLS			
		DECODIDITION	— ABBREV	IATIONS
EXISTING	PROPOSED	<u>DESCRIPTION</u>	GENERAL	
☐ JB Ⅲ ♠ ♠ ○□	JB	JERSEY BARRIER	AADT	ANNUAL AVERAGE DAILY TRAFFIC
⊞⊕⊞ СВ	■ CB	CATCH BASIN CATCH BASIN CURB INLET	ABAN	ABANDON
<u>- </u>		FLAG POLE	ADJ	ADJUST
G GP	G GP	GAS PUMP	APPROX.	APPROXIMATE ACRUAL T. CONCRETE
□ MB	□ MB	MAIL BOX	A.C. ACCM PIPE	ASPHALT CONCRETE ASPHALT COATED CORRUGATED METAL PIPE
		POST SQUARE	BIT.	BITUMINOUS
\circ	0	POST CIRCULAR	BC	BOTTOM OF CURB
⊕ WELL	⊕ WELL	WELL	BD.	BOUND
□ EHH	□ EHH	ELECTRIC HANDHOLE	BL	BASELINE
O O GG	O O GG	FENCE GATE POST GAS GATE	BLDG	BUILDING
○ GG ⊕ BHL #	O GG ❸ BHL#	BORING HOLE	BM	BENCHMARK
→ MW #	◆ MW#	MONITORING WELL	BO BOS	BY OTHERS BOTTOM OF SLOPE
■ TP #	TP#	TEST PIT	BR.	BRIDGE
P	Participation	HYDRANT	CB	CATCH BASIN
*	*	LIGHT POLE	CBCI	CATCH BASIN WITH CURB INLET
■CB ■CB/DH		CONCRETE BOUND/DRILL HOLE	CC	CEMENT CONCRETE
		GPS POINT	CCM	CEMENT CONCRETE MASONRY
©	© (*)	CABLE MANHOLE	CEM	CEMENT
(D)	(b)	DRAINAGE MANHOLE ELECTRIC MANHOLE	CI	CURB INLET
(E)	© ©	GAS MANHOLE	CIP CLF	CAST IRON PIPE CHAIN LINK FENCE
(M)	<u> </u>	MISC MANHOLE	CL	CENTERLINE
(S)	<u>s</u>	SEWER MANHOLE	CMP	CORRUGATED METAL PIPE
T	T	TELEPHONE MANHOLE	CSP	CORRUGATED STEEL PIPE
W	W	WATER MANHOLE	CO.	COUNTY
■ MHB	■ MHB	MASSACHUSETTS HIGHWAY BOUND	CONC	CONCRETE
- MON		MONUMENT STONE BOUND	CONT	CONSTRUCTION
□ SB ■ TB		STONE BOUND TOWN OR CITY BOUND	CONST CR GR	CONSTRUCTION CROWN GRADE
Δ		TRAVERSE OR TRIANGULATION STATION	DHV	DESIGN HOURLY VOLUME
→ TPL or GUY	→ TPL or GUY	TROLLEY POLE OR GUY POLE	DI	DROP INLET
o HTP		TRANSMISSION POLE	DIA	DIAMETER
-6- UFB	- 占 - UFB	UTILITY POLE W/ FIREBOX	DIP	DUCTILE IRON PIPE
-∳- UPDL	-∳- UPDL	UTILITY POLE WITH DOUBLE LIGHT	DW	STEADY DON'T WALK - PORTLAND ORANGE
-6- ULT	-&- ULT	UTILITY POLE W / 1 LIGHT	DWY	DRIVEWAY
-O- UPL	-≎- UPL	UTILITY POLE	ELEV (or EL.) EMB	ELEVATION
© SIZE % TVDE		BUSH TREE	EOP	EMBANKMENT EDGE OF PAVEMENT
•SIZE & TYPE		STUMP	EXIST (or EX)	
<u> </u>		SWAMP / MARSH	EXC	EXCAVATION
		WETLAND FLAG	F&C	FRAME AND COVER
• WG	• WG		F&G	FRAME AND GRATE
• PM	• PM	PARKING METER	FDN.	FOUNDATION
		- OVERHEAD CABLE/WIRE	FLDSTN GAR	FIELDSTONE GARAGE
		- CURBING - CONTOURS (ON-THE-GROUND SURVEY DATA)	GD	GROUND
		- CONTOURS (PHOTOGRAMMETRIC DATA)	GG	GAS GATE
12" RCP D		- UNDERGROUND DRAIN PIPE (DOUBLE LINE 24 INCH AND OVER)	GI	GUTTER INLET
		- UNDERGROUND ELECTRIC DUCT (DOUBLE LINE 24 INCH AND OVER)	GIP	GALVANIZED IRON PIPE
_		- UNDERGROUND GAS MAIN (DOUBLE LINE 24 INCH AND OVER)	GRAN	GRANITE GRANITE
<u>8" VCP</u> S ———		- UNDERGROUND SEWER MAIN (DOUBLE LINE 24 INCH AND OVER)	GRAV	GRAVEL
8" C.I. W		- UNDERGROUND TELEPHONE DUCT (DOUBLE LINE 24 INCH AND OVER)	GRD HDW	GUARD HEADWALL
0 C.I. W		- UNDERGROUND WATER MAIN (DOUBLE LINE 24 INCH AND OVER) BALANCED STONE WALL	HMA	HOT MIX ASPHALT
	1 1 1	GUARD RAIL - STEEL POSTS	HOR	HORIZONTAL
		- WOOD GUARD RAIL	HYD	HYDRANT
x	x	CHAIN LINK OR METAL FENCE	INV	INVERT
		- WOOD FENCE	JCT	JUNCTION LENGTH OF CHENTS
			L LB	LENGTH OF CURVE LEACH BASIN
		- SAWCUT LINE	LP	LIGHT POLE
		 TOP OR BOTTOM OF SLOPE LIMIT OF EDGE OF PAVEMENT OR COLD PLANE AND OVERLAY 	LST	LANDSCAPE TIMBER
		BANK OF RIVER OR STREAM	LT	LEFT
		BORDER OF WETLAND	MAX	MAXIMUM
100′BZ	-	100 FT WETLAND BUFFER	MB	MAILBOX
200'RA	-	200 FT RIVERFRONT AREA BUFFER	MH MHB	MANHOLE MASSACHUSETTS HIGHWAY BOUND
APX 200'RA		APPROX 200 FT RIVERFRONT BUFFER	MHB MIN	MASSACHUSETTS HIGHWAY BOUND MINIMUM
100'RA	-	100 FT RIVERFRONT AREA BUFFER	NIC	NOT IN CONTRACT
APX 100'RA	_	APPROX 100 FT RIVERFRONT AREA BUFFER	NO.	NUMBER
		AURA BUFFER 100 FT AURA BUFFER	PC	POINT OF CURVATURE
100VPBZ		100 FT AURA BUFFER 100 FT VERNAL POOL AREA BUFFER	PCC	POINT OF COMPOUND CURVATURE
		STATE HIGHWAY LAYOUT/STATE OWNED LAND	P.G.L.	PROFILE GRADE LINE
 		TOWN OR CITY LAYOUT	PI POC	POINT OF INTERSECTION POINT ON CURVE
		- COUNTY LAYOUT	POC	POINT ON CORVE POINT ON TANGENT
		- RAILROAD SIDELINE	PRC	POINT OF REVERSE CURVATURE
P		- TOWN OR CITY BOUNDARY LINE PROPERTY LINE OR APPROXIMATE PROPERTY LINE	PROJ	PROJECT

PROPERTY LINE OR APPROXIMATE PROPERTY LINE

TRAVERSE OR TRIANGULATION STATION

SE BENCH W/ CONCRETE PAD

— — — — — EASEMENT

· EROSION CONTROL BARRIER

CHECK DAM

PROPOSED

PAVEMENT

PROP

PT

PVI

PVT

PVMT

PLANTABLE SOIL BORROW

POINT OF TANGENCY

POINT OF VERTICAL CURVATURE

POINT OF VERTICAL TANGENCY

POINT OF VERTICAL INTERSECTION

GENERAL	<u>.</u>
PWW	PAVED WATER WAY
R	RADIUS OF CURVATURE
R&D	REMOVE AND DISPOSE
RCP	REINFORCED CONCRETE PIPE
RD	ROAD
RDWY	ROADWAY
REM	REMOVE
RET	RETAIN
RET WALL	RETAINING WALL
ROW	RIGHT OF WAY
RR	RAILROAD
R&R	REMOVE AND RESET
R&S	REMOVE AND STACK
RT	RIGHT
SB	STONE BOUND
SHLD	SHOULDER
SMH	SEWER MANHOLE
ST	STREET
STA	STATION
SSD	STOPPING SIGHT DISTANCE
SHLO	STATE HIGHWAY LAYOUT LINE
SW	SIDEWALK
Т	TANGENT DISTANCE OF CURVE/TRUCK %
TAN	TANGENT
TEMP	TEMPORARY
TC	TOP OF CURB
TMA	TELEPHONE MAST ARM
TOS	TOP OF SLOPE
TYP	TYPICAL
UP	UTILITY POLE
VAR	VARIES
VERT	VERTICAL
VC	VERTICAL CURVE
WCR	WHEEL CHAIR RAMP
WG	WATER GATE
WIP	WROUGHT IRON PIPE
WM	WATER METER/WATER MAIN
X-SECT	CROSS SECTION

PAVEMENT MARKINGS SYMBOLS

EXISTING	PROPOSED	DESCRIPTION
	SL	STOP LINE
	cw	CROSSWALK
	SWL	SOLID WHITE LINE
	SYL	SOLID YELLOW LINE
	BWL	BROKEN WHITE LINE
	BYL	BROKEN YELLOW LINE
	<u>DWL</u>	DOTTED WHITE LINE
	<u>DYL</u>	DOTTED YELLOW LINE
	<u>DWLEx</u>	DOTTED WHITE LINE EXTENSION
	DYLEx	DOTTED YELLOW LINE EXTENSION
	DBWL	DOUBLE WHITE LINE
	DBYL	DOUBLE YELLOW LINE

GENERAL NOTES:

- 1. THE PROPERTY LINES SHOWN ON THIS PLAN OF THE PARCELS AT 44 FOREST AVENUE IN HUDSON, 163 BOSTON POST ROAD IN SUDBURY AND THE FORMER RAILROAD RIGHT-OF-WAY ARE BASED UPON AN ACTUAL FIELD SURVEY CONDUCTED BY VHB, INC. IN 2015 AND FROM DEEDS AND PLANS OF RECORD.
- 2. THE EXISTING CONDITIONS SHOWN ON THIS PLAN WERE DEVELOPED FROM A COMBINED EFFORT OF AERIAL PHOTOGRAMMETRIC MAPPING BY EASTERN TOPOGRAPHICS, INC., BASED ON AERIAL PHOTOGRAPHS TAKEN ON FEBRUARY 22, 2013, AND AUGMENTED BY AN ON-THE-GROUND SURVEY PERFORMED BY VHB DURING 2015 AND 2017.
- 3. THE HORIZONTAL CONTROL IS BASED ON THE MASSACHUSETTS MAINLAND STATE PLANE COORDINATE SYSTEM AND THE NATIONAL GEODETIC SURVEY (NAD83). ALL ELEVATION IS US FEET, REFERENCED TO THE NORTH AMERICA VERTICAL DATUM OF 1988 (NAVD88).
- 4. THE CONTRACTOR SHALL VERIFY ALL EXISTING DIMENSIONS AND GRADES IN THE FIELD BEFORE COMMENCING WORK AND PROMPTLY NOTIFY THE ENGINEER OF ANY DISCREPANCIES.
- 3. THE LOCATIONS OF EXISTING UNDERGROUND UTILITIES SHOWN ON THIS PLAN ARE BASED ON FIELD OBSERVATIONS AND INFORMATION OF RECORD. THEY HAVE NOT BEEN INDEPENDENTLY VERIFIED BY THE OWNER OR ITS REPRESENTATIVE. THE CONTRACTOR SHALL DETERMINE THE EXACT LOCATION OF ALL EXISTING UTILITIES BEFORE COMMENCING WORK, AND SHALL BE FULLY RESPONSIBLE FOR ANY AND ALL DAMAGES WHICH MIGHT BE OCCASIONED BY THE CONTRACTOR'S FAILURE TO EXACTLY LOCATE AND PRESERVE ANY AND ALL UNDERGROUND UTILITIES.
- 4. THE DELINEATED WETLANDS SHOWN ON THIS PLAN WERE FLAGGED BY THE VHB ENVIRONMENTAL DEPARTMENT AND FIELD SURVEYED BY THE VHB SURVEY DEPARTMENT IN SEPTEMBER AND OCTOBER 2017 AND WERE UPDATED IN MAY 2018 (SUDBURY ONLY). IN HUDSON, ADDITIONAL WETLANDS WERE DELINEATED AND SURVEYED BY VHB IN JANUARY 2019.
- 5. THE APPROXIMATE WETLANDS AND STREAMS, AND THEIR ASSOCIATED BUFFERS AND RIVERFRONT AREAS, WHERE APPLICABLE, WERE TAKEN FROM AVAILABLE MASSGIS DATA. THESE WERE NOT FIELD DELINEATED OR FIELD VERIFIED.
- 6. WHERE AN EXISTING UTILITY IS FOUND TO CONFLICT WITH THE PROPOSED WORK, THE LOCATION, ELEVATION AND SIZE OF THE UTILITY SHALL BE ACCURATELY DETERMINED WITHOUT DELAY BY THE CONTRACTOR, AND THE INFORMATION FURNISHED TO THE ENGINEER FOR RESOLUTION OF THE CONFLICT.
- 7. THE CONTRACTOR SHALL ALTER THE MASONRY OF THE TOP SECTION OF ALL EXISTING DRAINAGE AND SEWER STRUCTURES AS NECESSARY FOR CHANGES IN GRADE, AND RESET ALL WATER AND DRAINAGE FRAMES, GRATES AND BOXES TO THE PROPOSED FINISH SURFACE GRADE. REQUIRED NEW MASONRY SHALL BE CLAY BRICK.
- 8. THE CONTRACTOR SHALL MAKE ALL ARRANGEMENTS FOR THE ALTERATION AND ADJUSTMENT OF GAS, ELECTRIC, TELEPHONE AND ANY OTHER PRIVATE UTILITIES BY THE UTILITY COMPANIES.
- 9. EXISTING UTILITY POLES WILL BE RELOCATED BY OTHERS IF REQUIRED.
- 10. TREES AND SHRUBS WITHIN THE LIMITS OF GRADING SHALL BE REMOVED ONLY UPON APPROVAL OF THE ENGINEER.
- 11. AREAS OUTSIDE THE LIMITS OF PROPOSED WORK DISTURBED BY THE CONTRACTOR'S OPERATIONS SHALL BE RESTORED BY THE CONTRACTOR TO THEIR ORIGINAL CONDITION AT NO EXPENSE TO THE OWNER.
- 12. THE TERM "PROPOSED" (PROP) MEANS WORK TO BE CONSTRUCTED USING NEW MATERIALS OR, WHERE APPLICABLE, RE-USING EXISTING MATERIALS IDENTIFIED AS "REMOVE AND RESET" (R&R).
- 13. JOINTS BETWEEN NEW ASPHALT CONCRETE ROADWAY PAVEMENT AND SAWCUT EXISTING PAVEMENT SHALL BE SEALED WITH BITUMEN AND BACKSANDED.
- 14. EXISTING SIGNS WITHIN THE PROJECT LIMITS SHALL BE RETAINED UNLESS INDICATED OTHERWISE ON THE DRAWINGS.
- 15. IF SUITABLE, ALL EXISTING GRANITE CURB & EDGING SHALL BE RE-USED IN THE PROPOSED WORK, EXCEPT CURVED STONES OF A DIFFERENT RADIUS THAN PROPOSED
- 16. ALL PROPOSED HOT MIX ASPHALT CURB SHALL BE MASSDOT TYPE 3 UNLESS STATED OTHERWISE ON THE PLANS.
- 17. ALL EXISTING STATE, COUNTY, CITY, AND TOWN LOCATION LINES AND PRIVATE PROPERTY LINES HAVE BEEN ESTABLISHED FROM AVAILABLE INFORMATION AND THEIR EXACT LOCATIONS ARE NOT GUARANTEED.
- 18. DISPOSAL OF ALL SURPLUS MATERIAL SHALL BE AS APPROVED BY THE ENGINEER AND
- 19. ALL EXISTING EROSION CONTROL BARRIER, CONSTRUCTION FENCING AND SILT SACKS SHALL BE MAINTAINED THROUGHOUT CONSTRUCTION ACTIVITIES AND REMOVED AFTER CONSTRUCTION ACTIVITIES ARE COMPLETE.

DRAWN: JCR



COMMONWEALTH OF MASSACHUSETTS DEPARTMENT OF CONSERVATION AND RECREATION **DIVISION OF PLANNING AND ENGINEERING**

MASS CENTRAL RAIL TRAIL - WAYSIDE MASS CENTRAL RAIL TRAIL HUDSON, STOW, MARLBOROUGH & SUDBURY, MA DESIGNER:JCR LEGEND ABBREVIATIONS & GENERAL NOTES CHECKED: SHK

CONT. P19-3295-D1A

ACC. XXXXXXX


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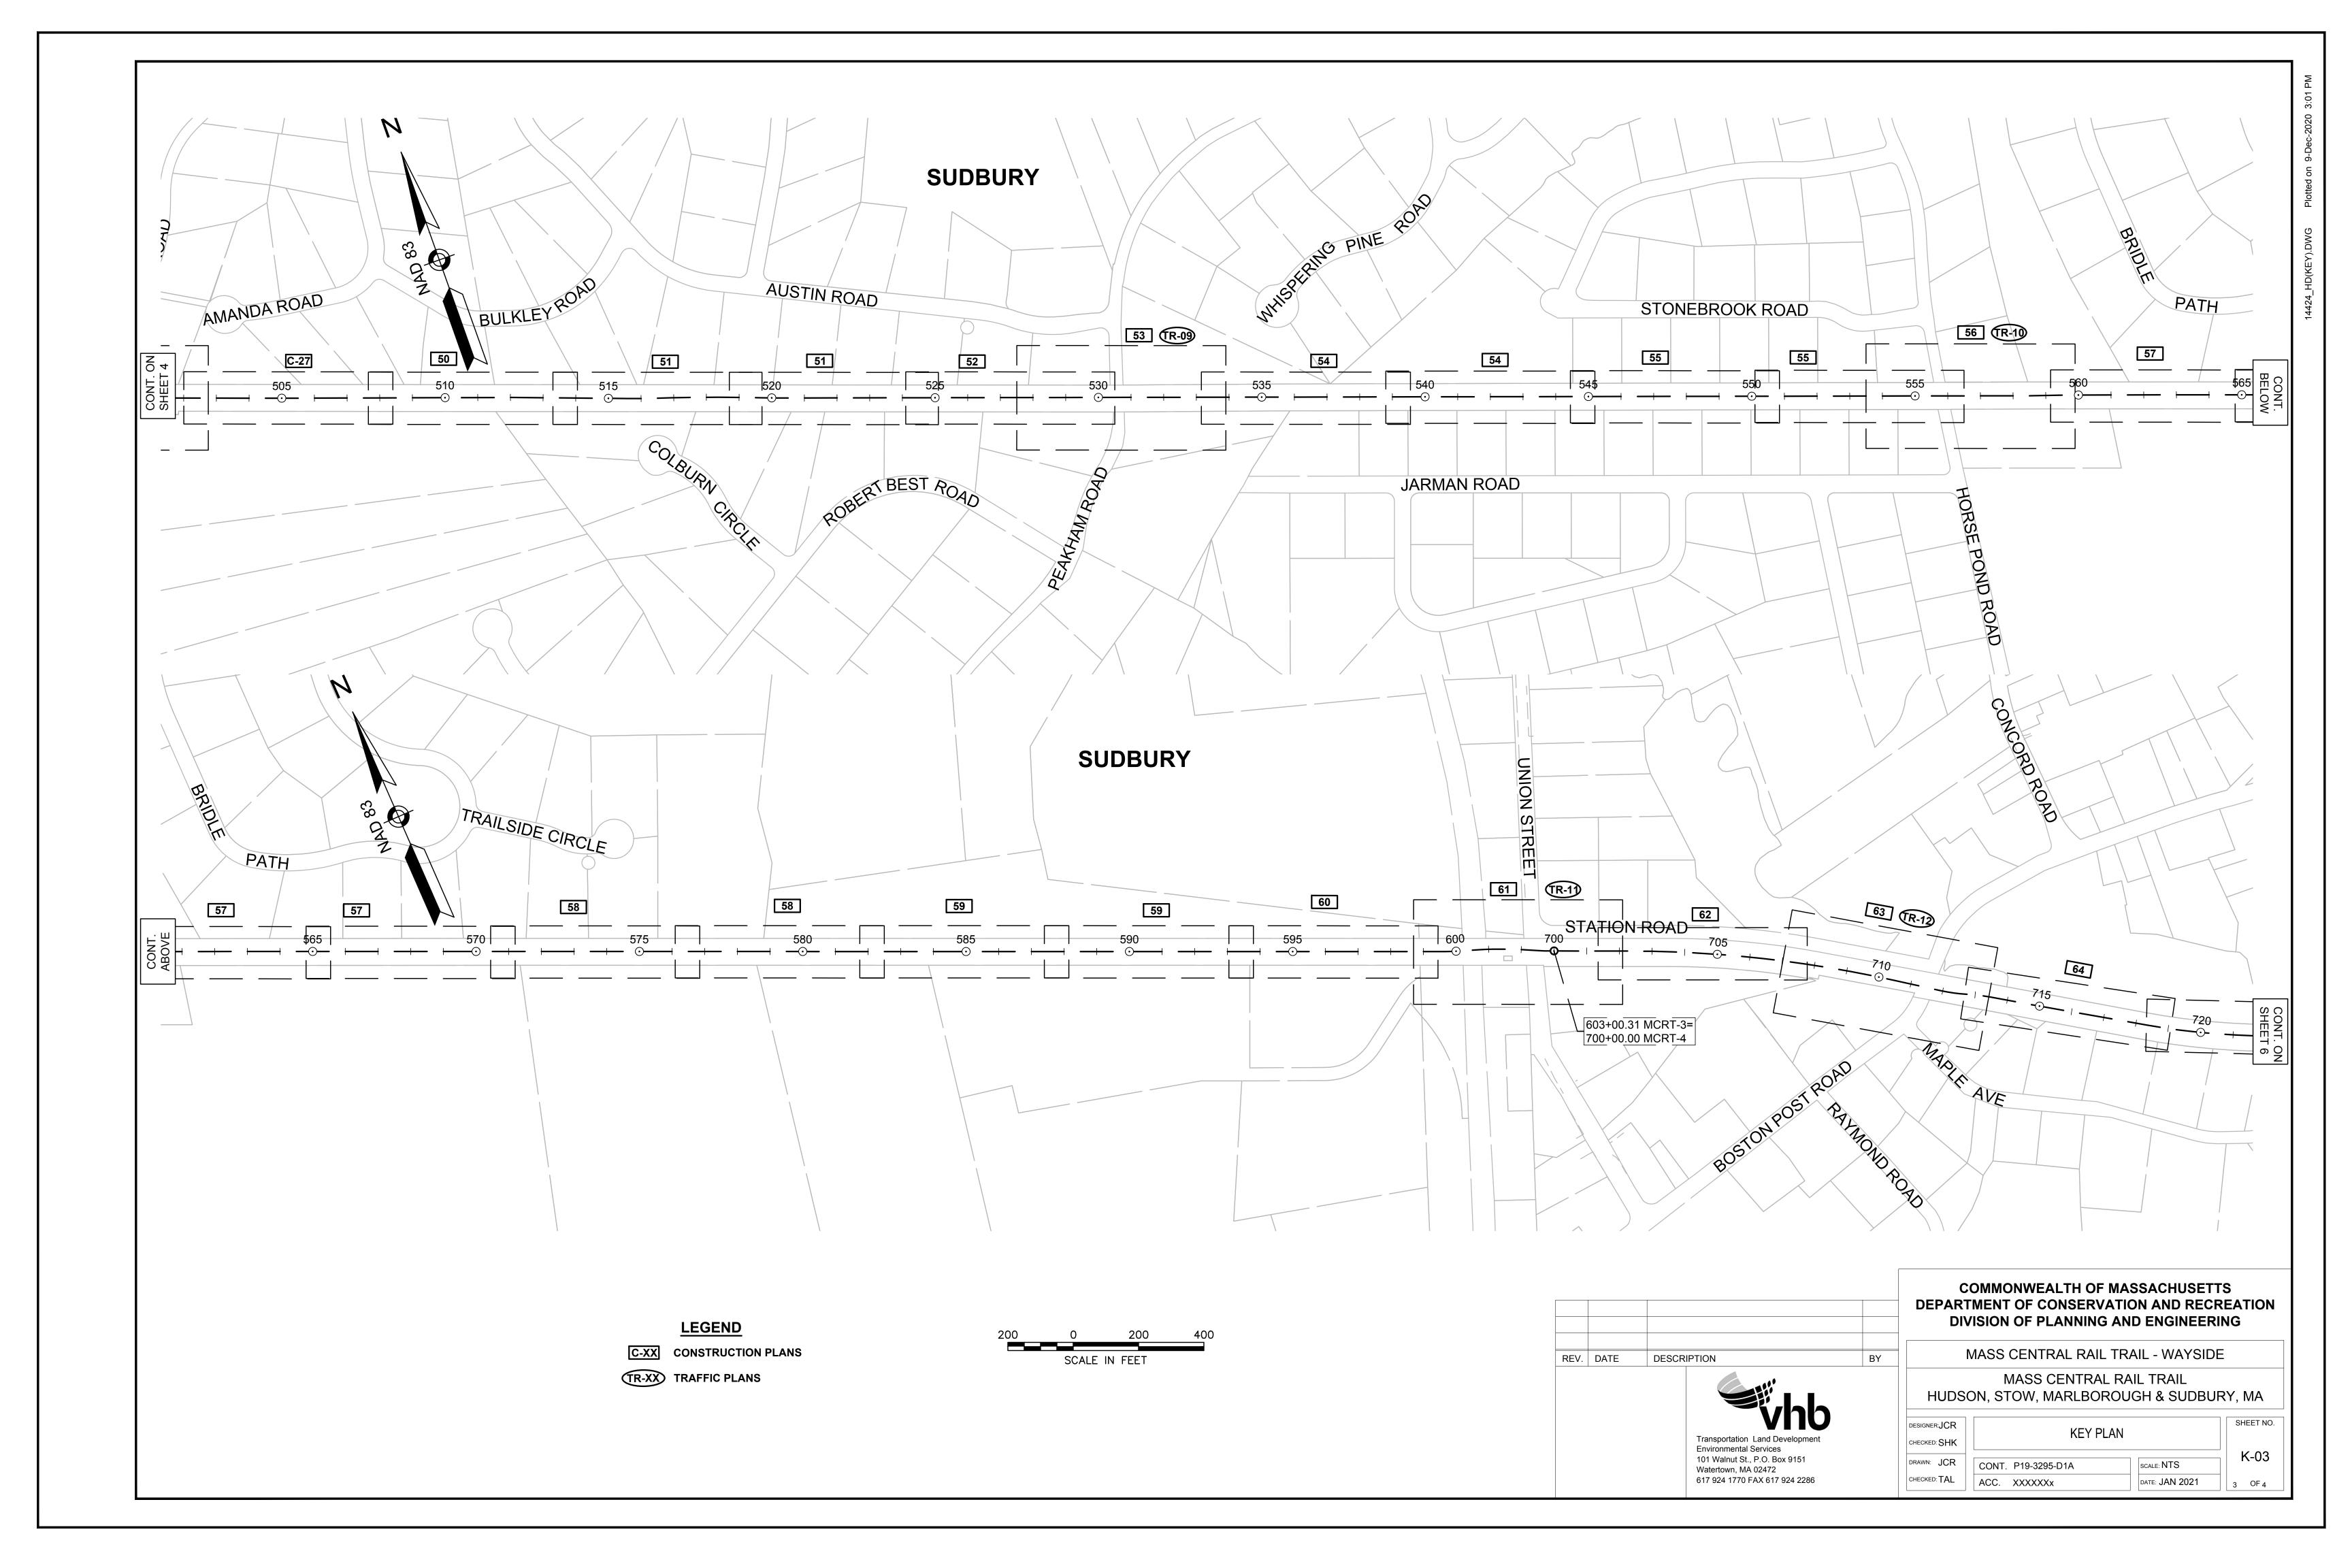
DATE: **JAN 2021**


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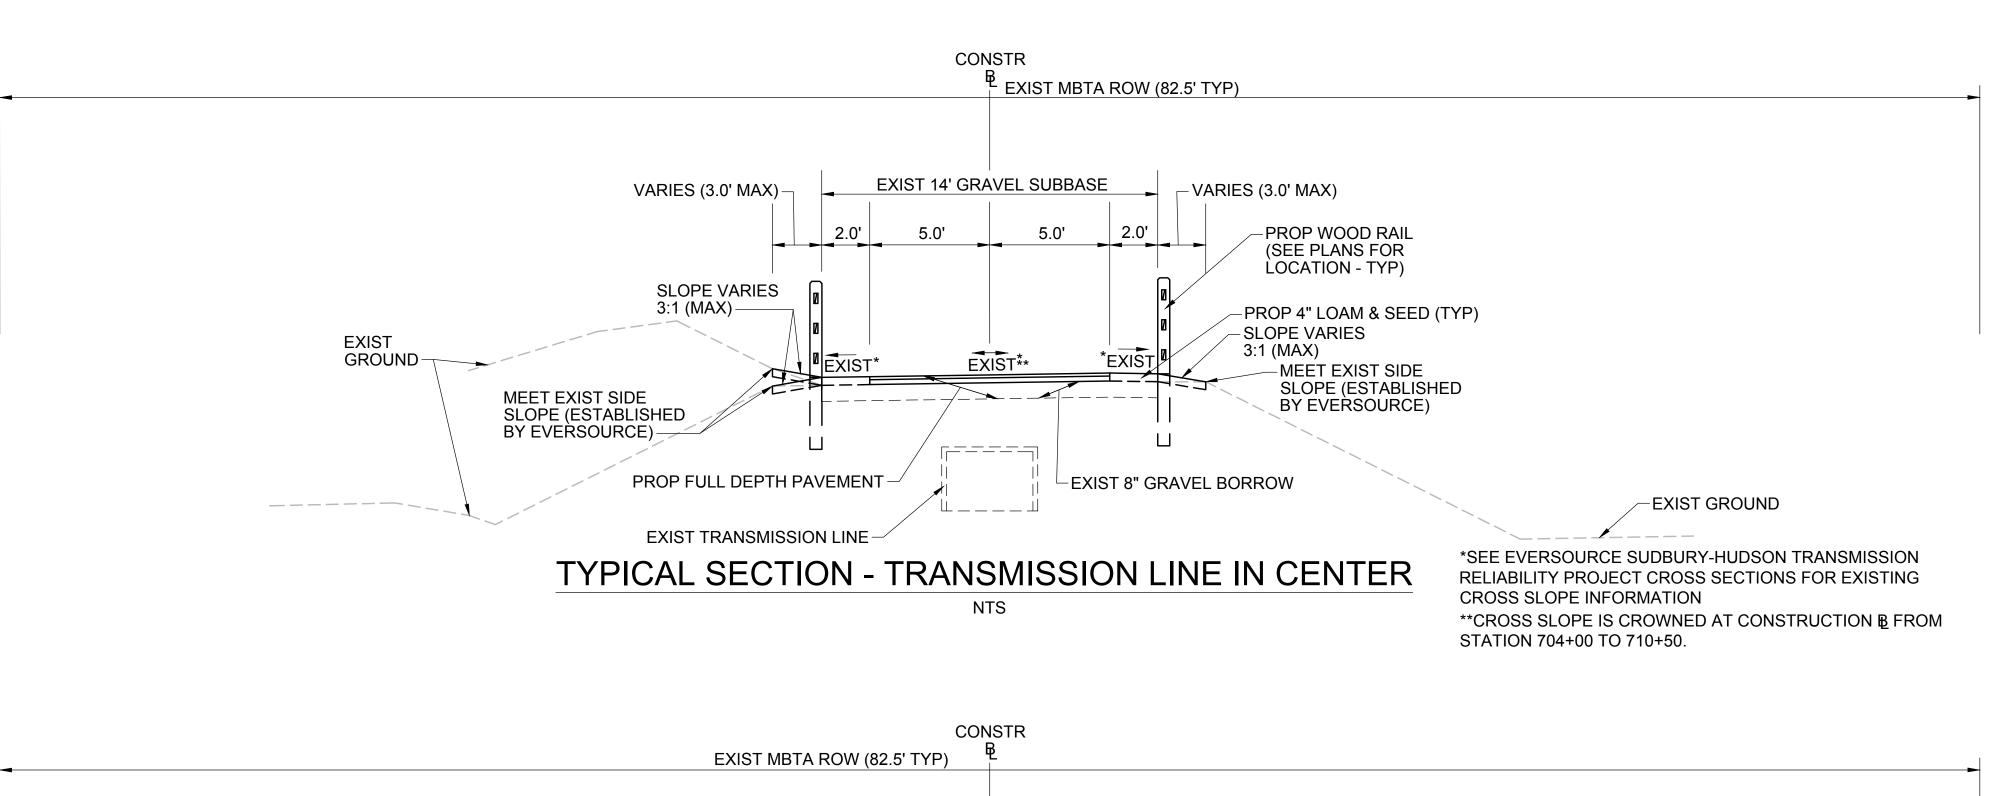
Transportation Land Development **Environmental Services** 101 Walnut St., P.O. Box 9151 Watertown, MA 02472

617 924 1770 FAX 617 924 2286






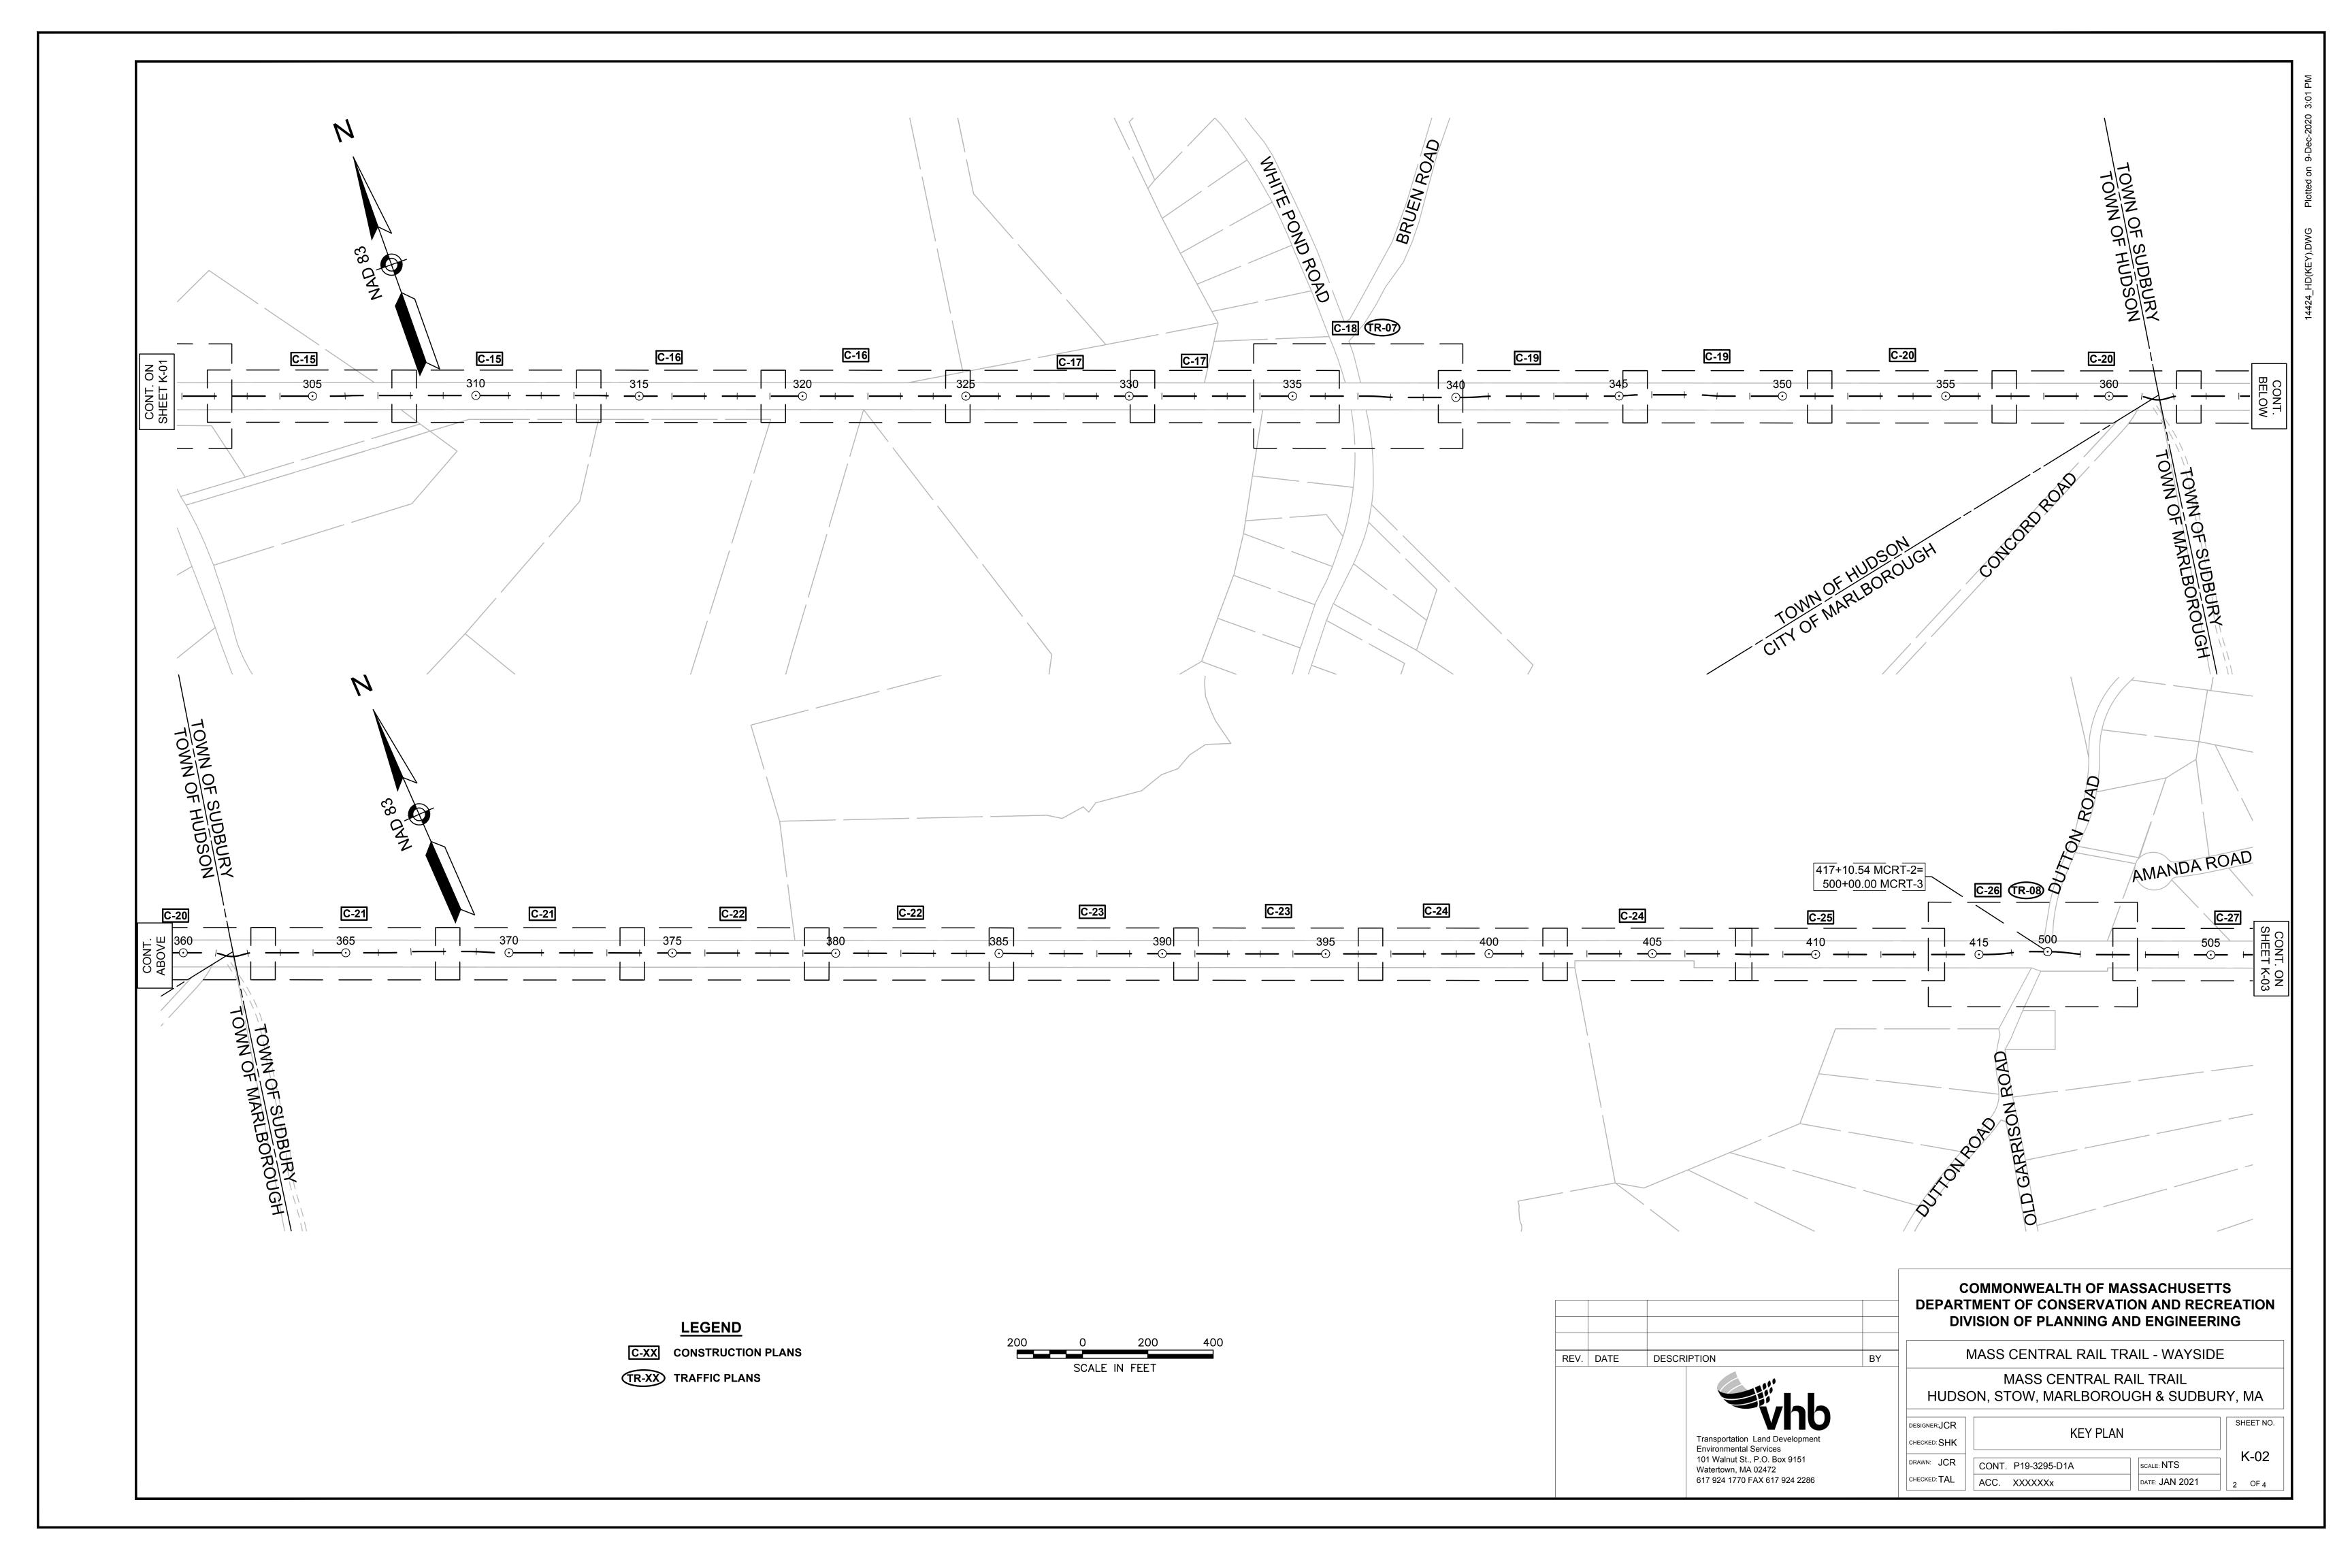

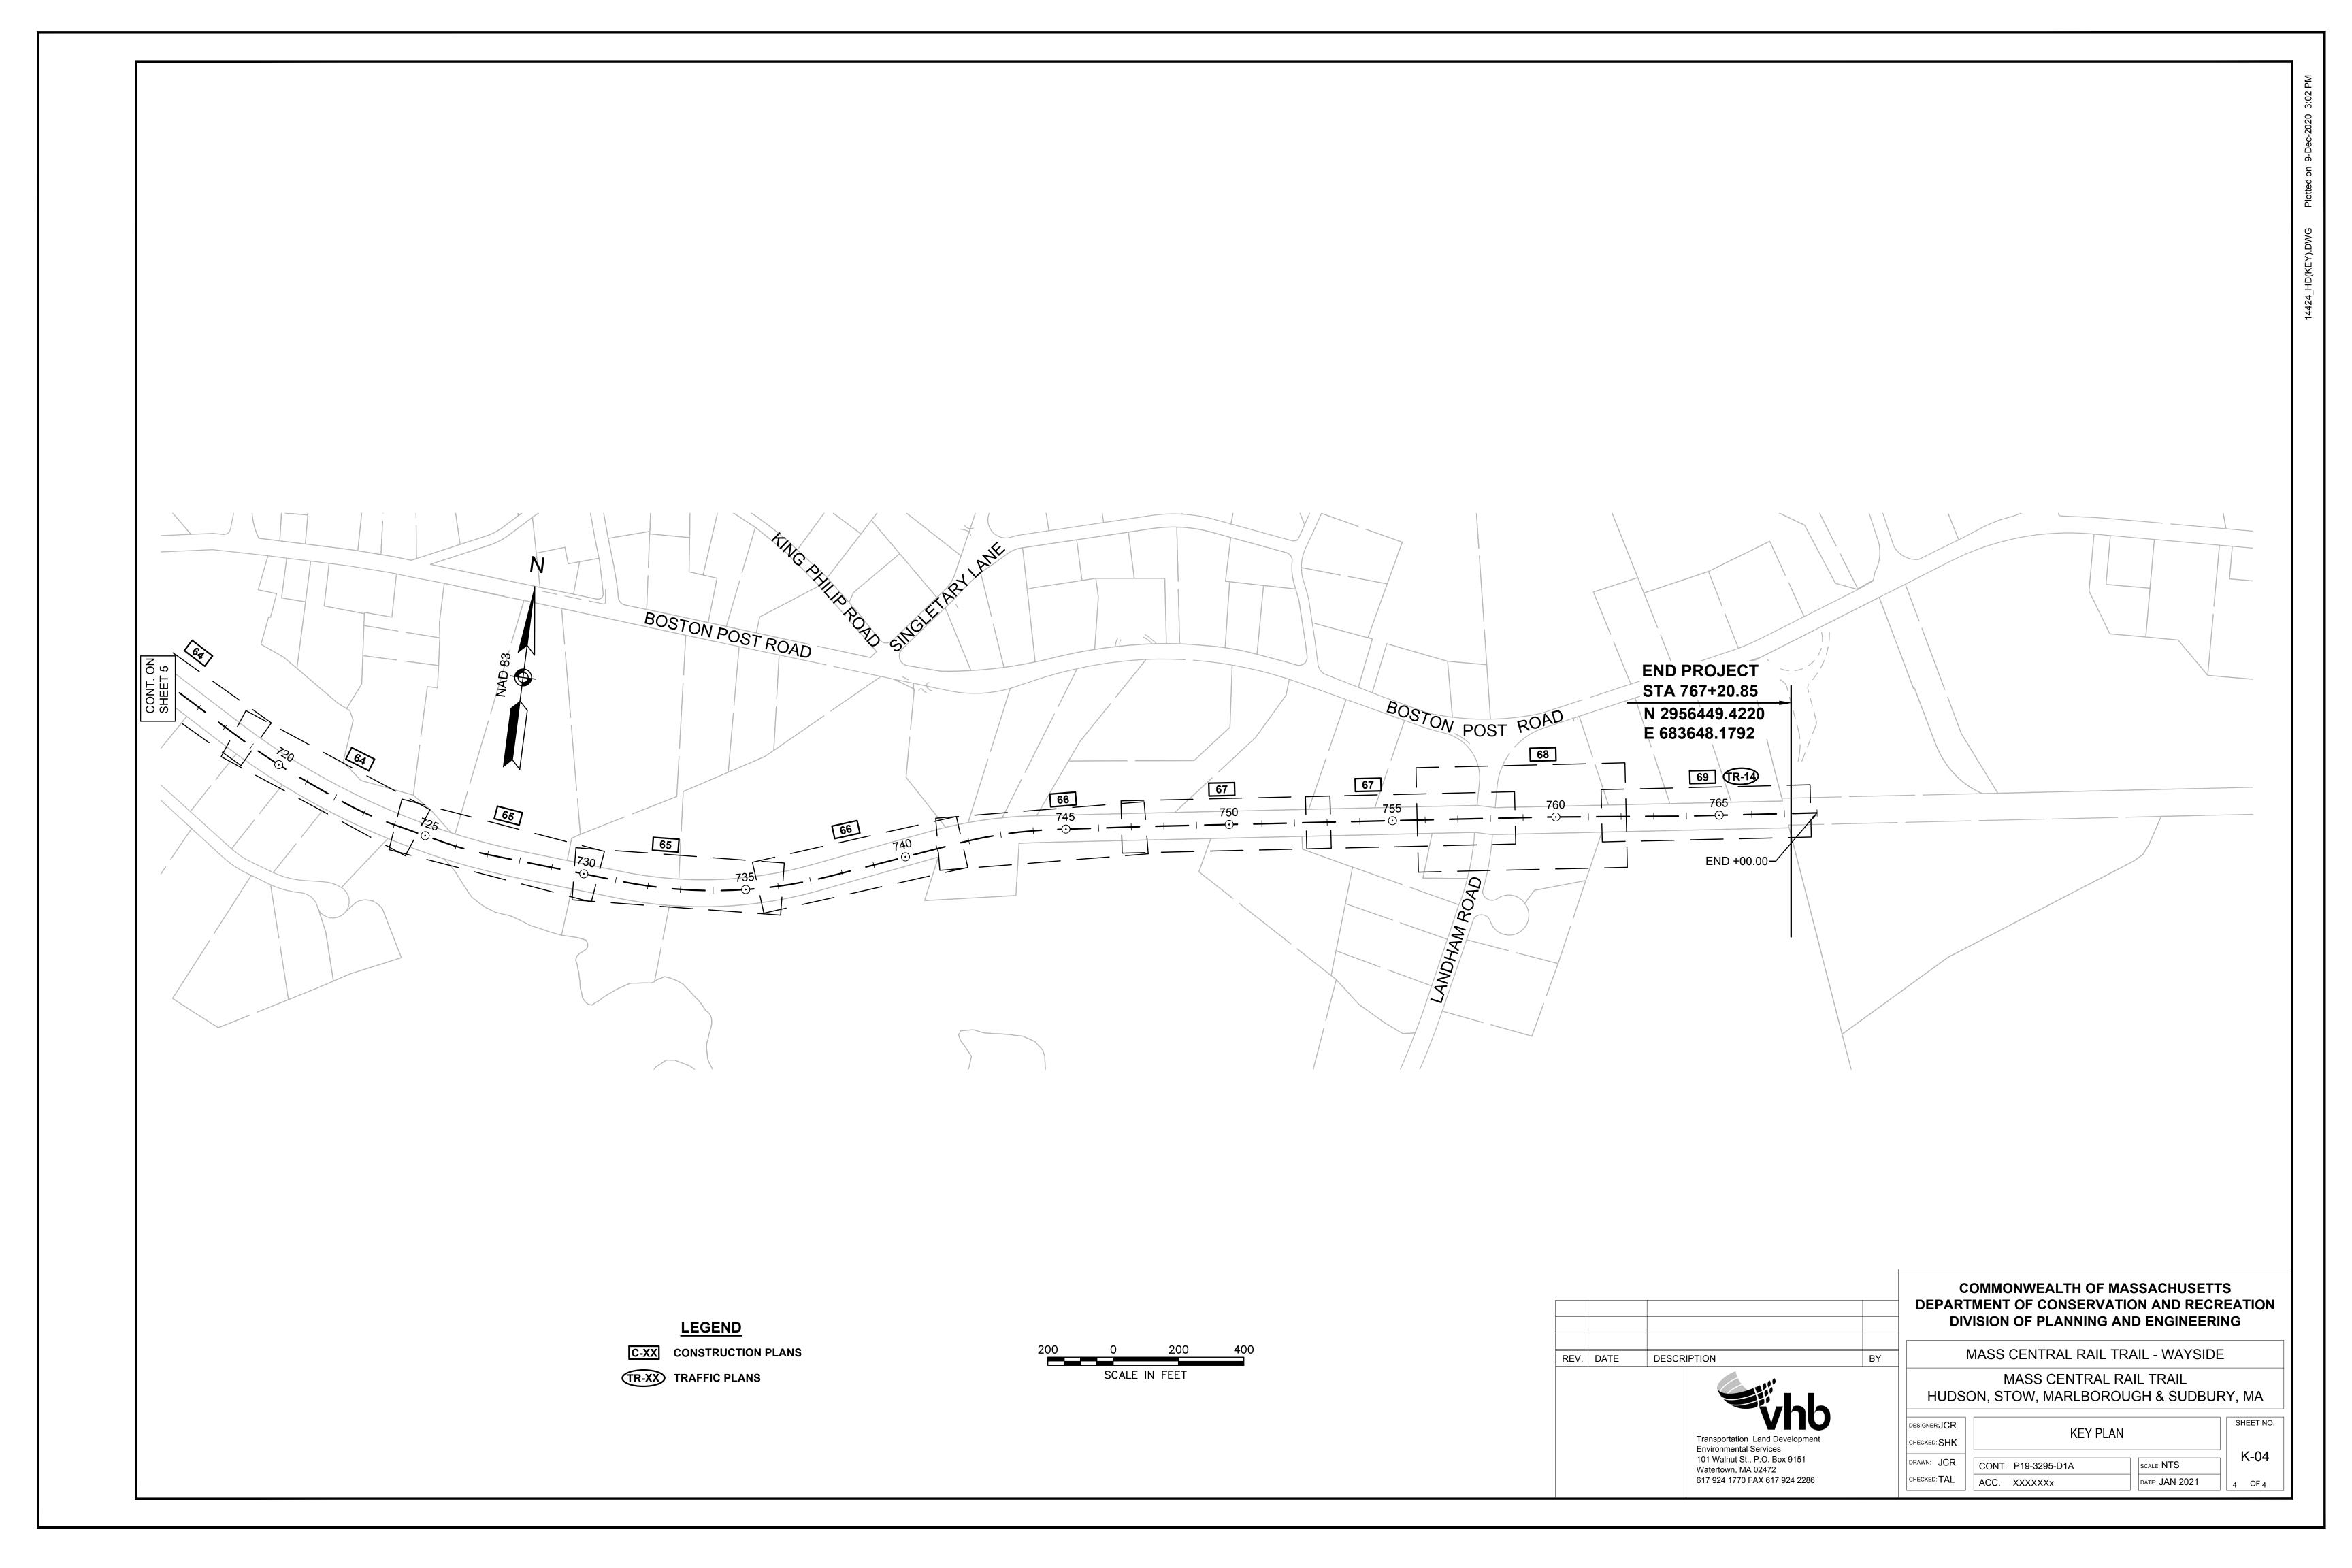

EXIST 14' GRAVEL SUBBASE - VARIES (3.0' MAX) VARIES | 2.0' | 2.5' 7.5' ∠PROP WOOD RAIL (SEE PLANS FOR LOCATION) PROP 4" LOAM & SEED (TYP) -MAX) SLOPE VARIES SLOPE VARIES 3:1 (MAX) 3:1 (MAX) -EXIST GROUND--MEET EXIST SIDE SLOPE (ESTABLISHED MEET EXIST SIDE EXIST* EXIST* *EXIST SLOPE (ESTABLISHED BY EVERSOURCE) BY EVERSOURCE)-F==== -EXIST GROUND -EXIST 8" GRAVEL BORROW -PROP FULL DEPTH PAVEMENT TRANSMISSION LINE *SEE EVERSOURCE SUDBURY-HUDSON TRANSMISSION

TYPICAL SECTION - TRANSMISSION LINE ON LEFT

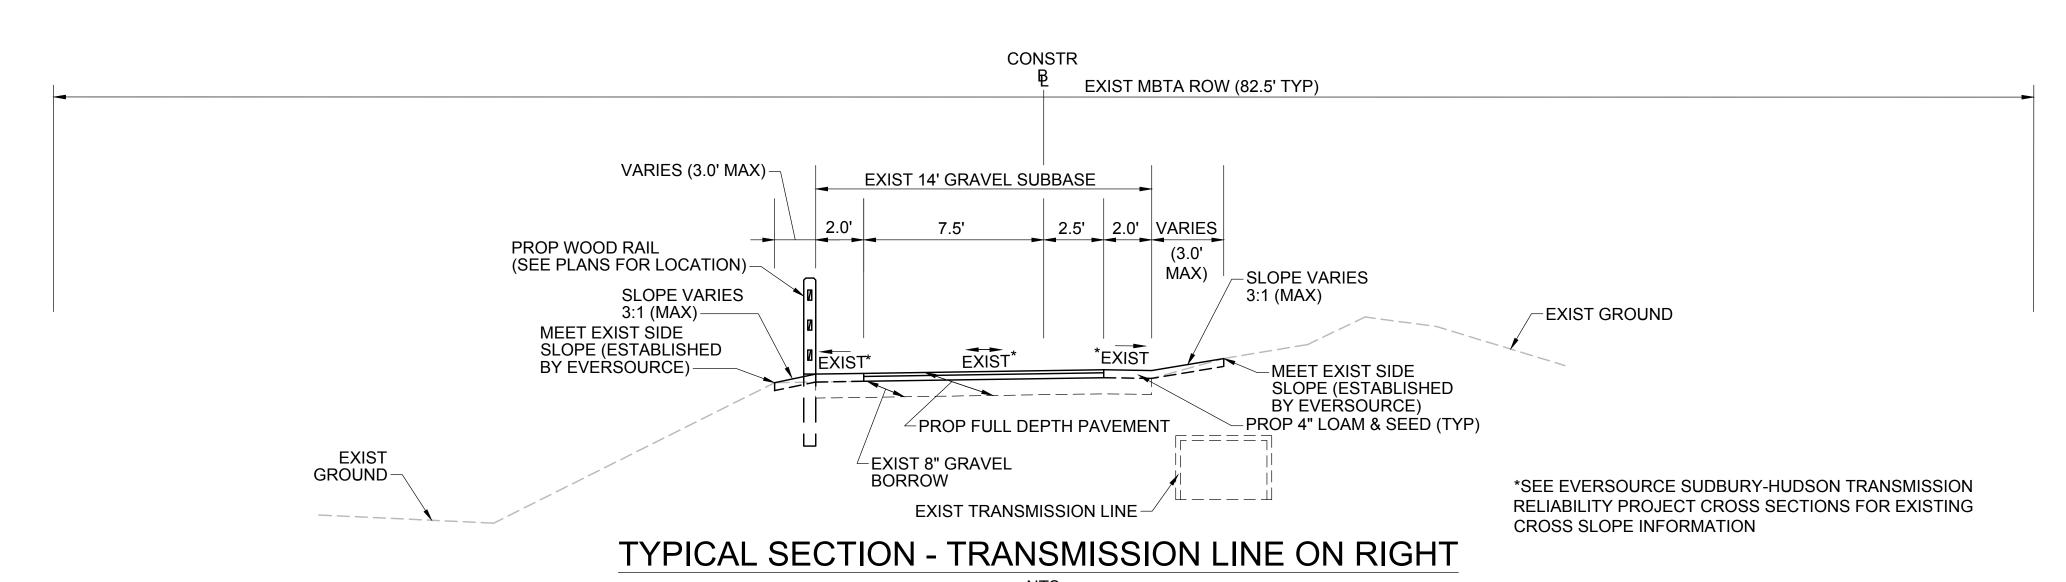

PAVEMENT NOTES

PROPOSED PATH PAVEMENT

SURFACE: 1.5" SUPERPAVE SURFACE COURSE - 9.5 (SSC - 9.5)

INTERMEDIATE: 2.5" SUPERPAVE INTERMEDIATE COURSE - 19.0 (SIC - 19.0)

SUBBASE: 8" GRAVEL BORROW, TYPE b

NOTE:

FROM STA 100+00± TO STA 767+20± EXIST GRAVEL FROM EVERSOURCE ACCESS ROAD SHALL BE USED FOR SUBBASE MATERIAL.

PROPOSED CATTLE CROSSING PAVEMENT

SURFACE: 1.5" SUPERPAVE SURFACE COURSE - 9.5 (SSC - 9.5)

INTERMEDIATE:* 2.5" SUPERPAVE INTERMEDIATE COURSE - 19.0 (SIC - 19.0)

NOTE:

2.5" SUPERPAVE INTERMEDIATE COURSE TO BE
INSTALLED AS PART OF EVERSOURCE SUDBURY-HUDSON

TRANSMISSION LINE RELIABILITY PROJECT.

PROPOSED CEMENT CONCRETE WHEELCHAIR RAMP

SURFACE: 6" CEMENT CONCRETE
AIR ENTRAINED 4000 PSI, 3/4", 610

SUBBASE: 8" GRAVEL BORROW, TYPE b

*NOTE:

EXIST GRAVEL FROM EVERSOURCE ACCESS ROAD SHALL

BE USED FOR SUBBASE MATERIAL.

PROPOSED CEMENT CONCRETE PULL OFF/TURN AROUND

SURFACE: 4" CEMENT CONCRETE

AIR ENTRAINED 4000 PSI, 3/4", 610

SUBBASE: 8" GRAVEL BORROW, TYPE b

*NOTE:

EXIST GRAVEL FROM EVERSOURCE ACCESS ROAD SHALL BE USED FOR SUBBASE MATERIAL.

PROPOSED HOT MIX ASPHALT WALK

1" SUPERPAVE SURFACE COURSE - 9.5 (SSC-9.5)

1.5" SUPERPAVE INTERMEDIATE COURSE 12.5 (SIC-12.5)

SUBBASE: 8" GRAVEL BORROW, TYPE b

NOTES:


RELIABILITY PROJECT CROSS SECTIONS FOR EXISTING

CROSS SLOPE INFORMATION

1. ALL HOT MIX ASPHALT SHALL BE PRODUCED WITH A WARM-MIX ASPHALT ADDITIVE.

SURFACE:

- 2. ALL HOT MIX ASPHALT PAVEMENTS SHALL BE CONSTRUCTED AND PRODUCED IN ACCORDANCE WITH SECTION 450 HOT MIX ASPHALT PAVEMENT.
- 3. ASPHALT EMULSION FOR TACK COAT (RS-1H) SHALL BE SPRAY APPLIED FOR DOUBLE OVERLAP COVERAGE AT 0.05 GALLONS PER SQUARE YARD OVER SMOOTH SURFACES.
- 4. HMA JOINT SEALANT (ASPHALT RUBBER) SHALL BE APPLIED IN SURFACE COURSE AT ALL VERTICAL COLD JOINTS PRIOR TO PAVING.
- 5. ALL HOT MIX ASPHALT WALKS SHALL BE MEASURED AND PAID FOR UNDER ITEM 702 OF STANDARD SPECIFICATIONS FOR HIGHWAYS AND BRIDGES.

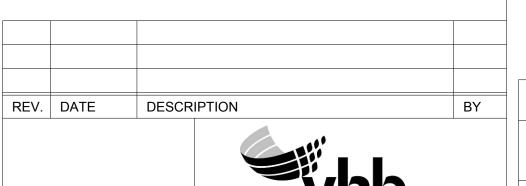

Transportation Land Development

617 924 1770 FAX 617 924 2286


Environmental Services 101 Walnut St., P.O. Box 9151 Watertown, MA 02472 COMMONWEALTH OF MASSACHUSETTS
DEPARTMENT OF CONSERVATION AND RECREATION
DIVISION OF PLANNING AND ENGINEERING

MASS CENTRAL RAIL TRAIL - WAYSIDE


MASS CENTRAL RAIL TRAIL
HUDSON, STOW, MARLBOROUGH & SUDBURY, MA

DESIGNER: JCR
TYPICAL SECTIONS & DVMT NOTES
SHEET NO.

HUDS	Y, MA			
DESIGNER:JCR	TYPICAL SECTIONS & PVMT NOTES			
CHECKED: SHK				
DRAWN: JCR	CONT. P19-3295-D1A	SCALE: 1" = 20'-0"	TS-01	
CHECKED: TAL	ACC. XXXXXXX	DATE: JAN 2021	1 OF 2	

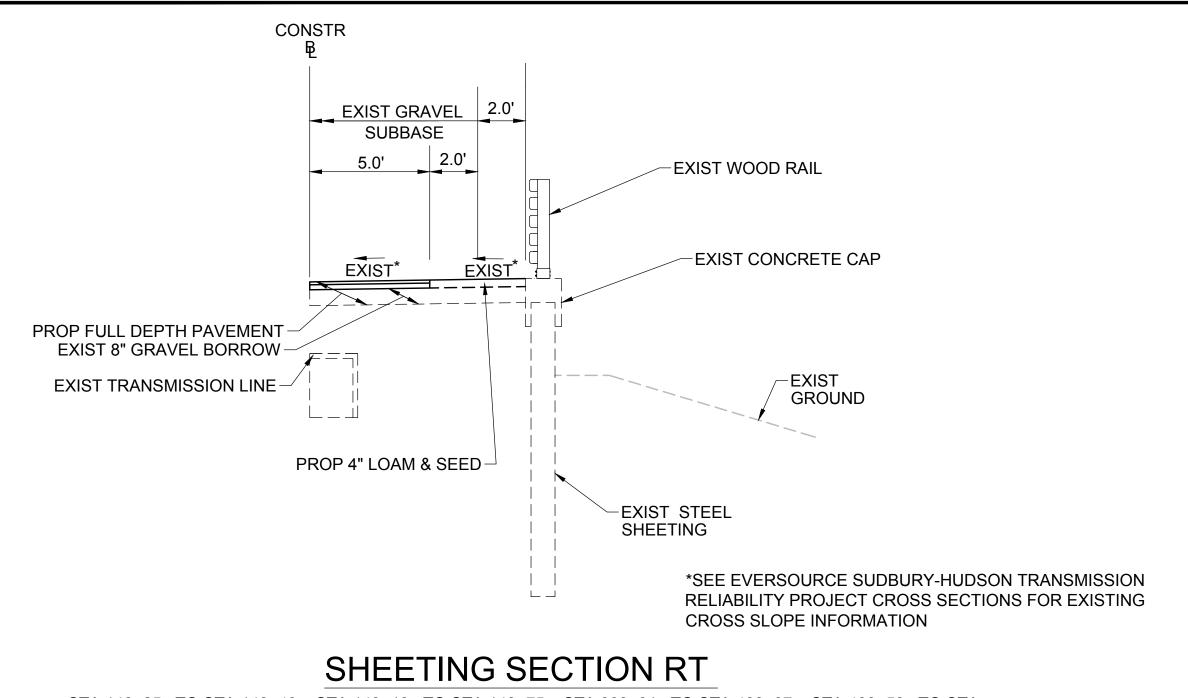


STA 148+25± TO STA 148+49±, STA 149+13± TO STA 149+75±, STA 399+91± TO STA 400+07±, STA 400+58± TO STA 401+25±, STA 724+73± TO STA 725+03±, STA 725+59± TO STA 725+96±, STA 731+00± TO STA 734+25±

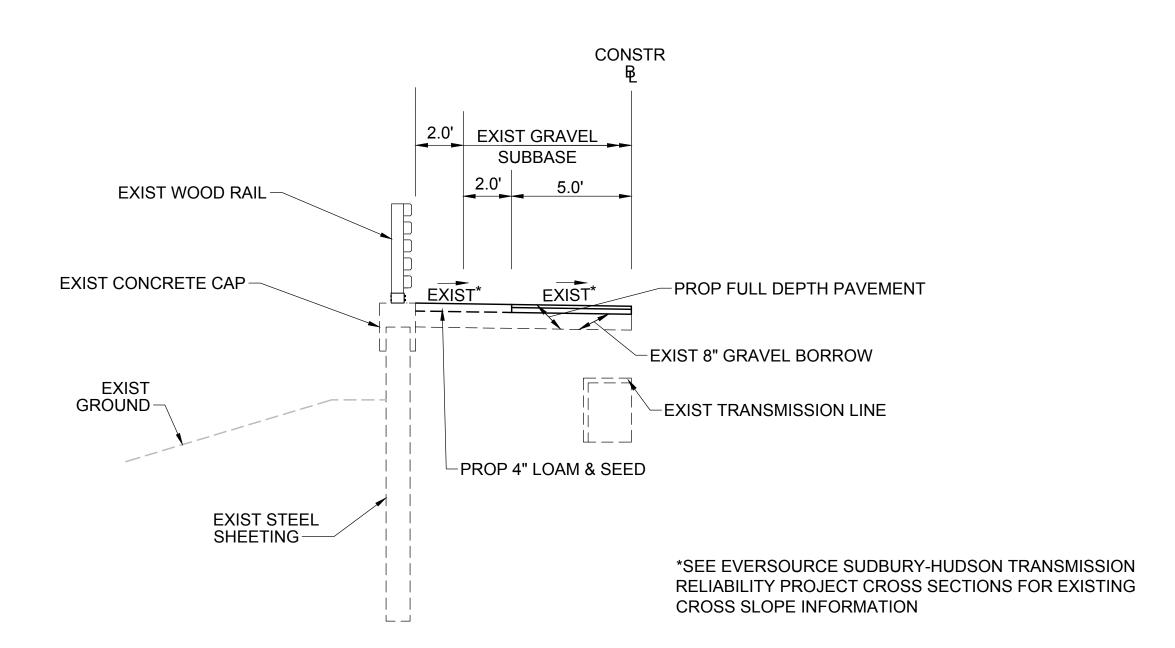


SHEETING SECTION LT

STA 119+00± TO STA 119+38±, STA 119+52± TO STA 125+00±, STA 148+25± TO STA 148+49±, STA 149+13± TO STA 149+75±, STA 300+50± TO STA 400+07±, STA 400+58± TO STA 401+25±, STA 724+73± TO STA 725+03±, STA 725+59± TO STA 725+96±

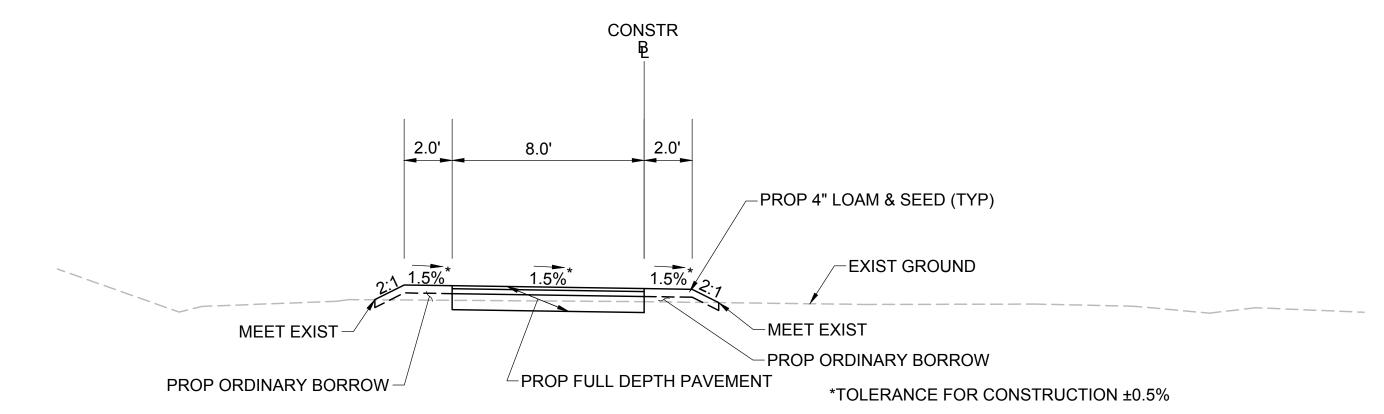

TYPICAL SECTION - MCRT CONNECTION

STA 10+15± TO STA 12+40±

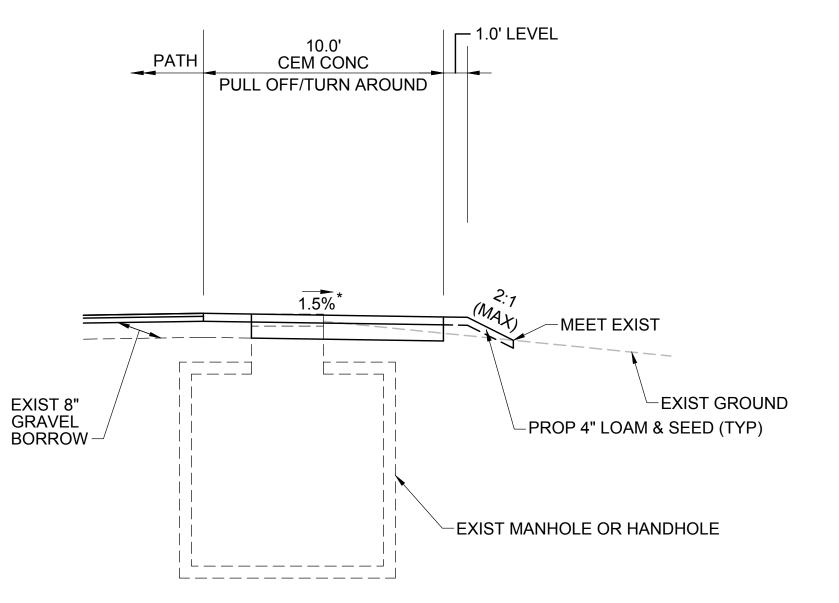


PAVEMENT NOTES

*SEE SHEET TS-01

*TOLERANCE FOR CONSTRUCTION ±0.5%

TYPICAL SECTION - PULL OFF/TURN AROUND

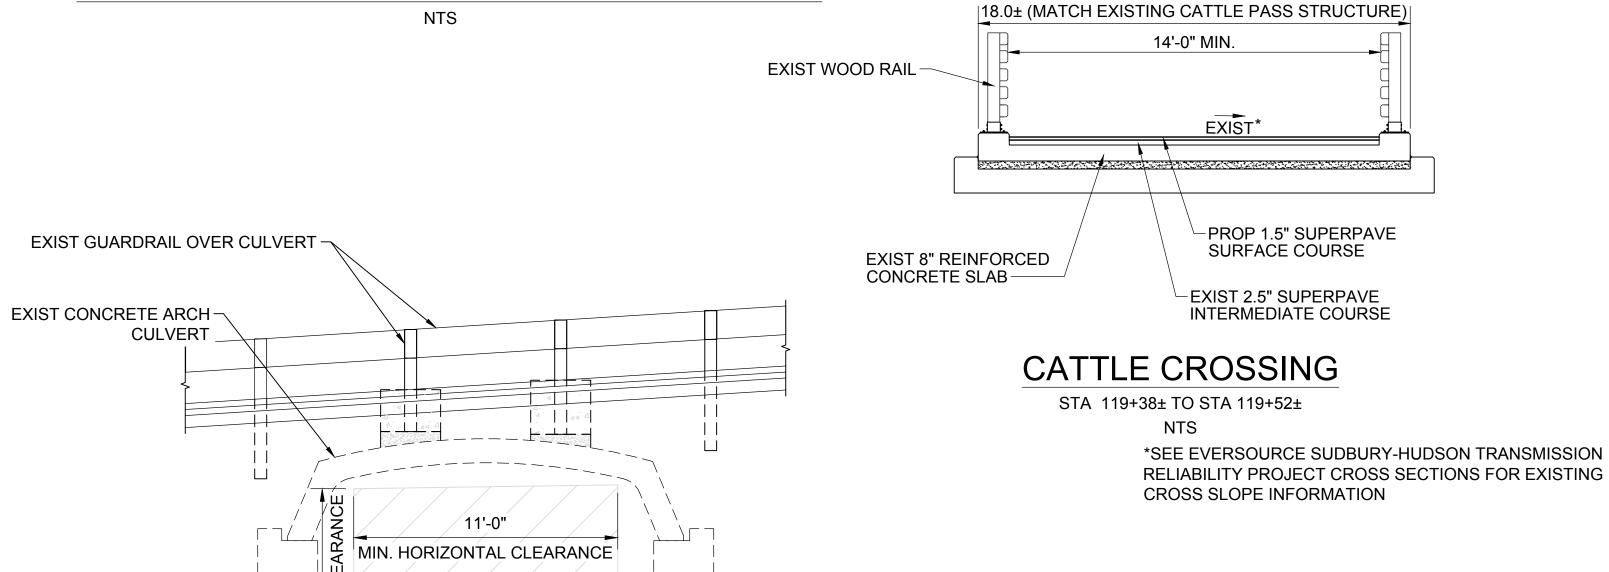

CHESTNUT STREET CULVERT

STA 132+44± TO STA 132+84±

CONSTR

<u>____</u>

EXIST 14' GRAVEL

ACCESS ROAD

EXIST*

EXIST CONCRETE -

EXIST TRANSMISSION LINE

PEDESTAL WALL & FOOTING (TYP)

> *SEE EVERSOURCE SUDBURY-HUDSON TRANSMISSION RELIABILITY PROJECT CROSS SECTIONS FOR EXISTING CROSS SLOPE INFORMATION




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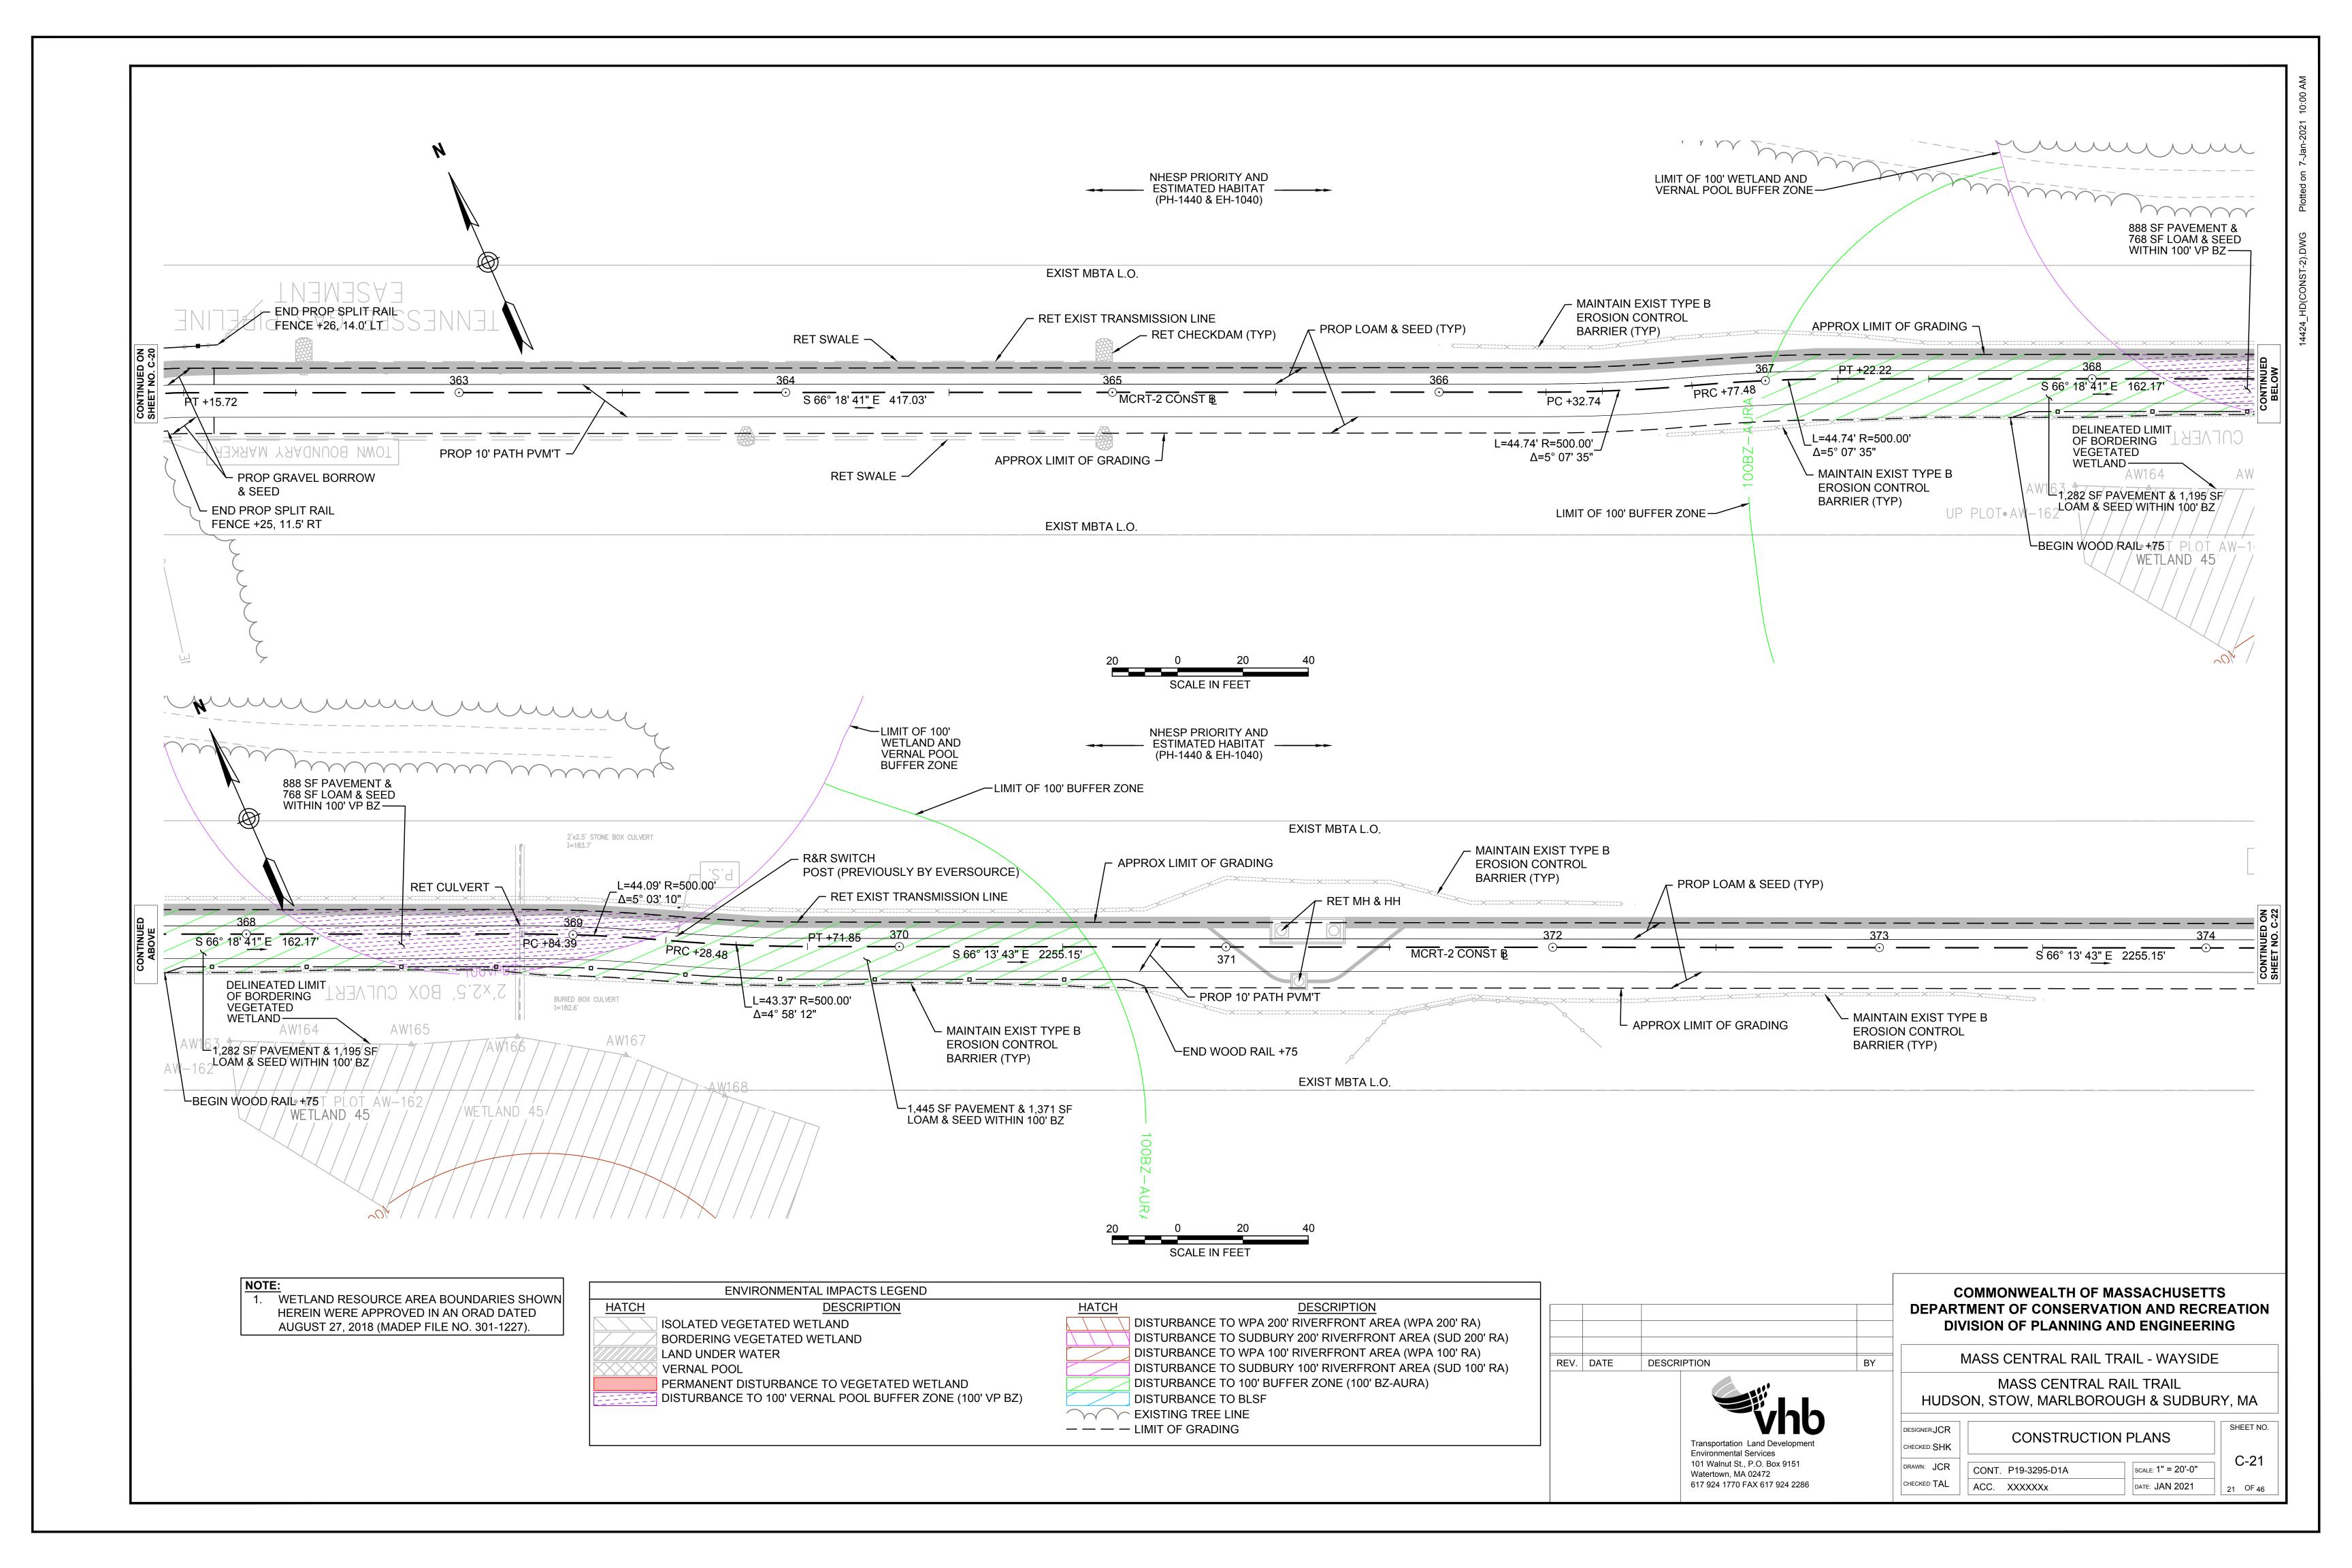
EXIST 8" GRAVEL BORROW


-PROP FULL DEPTH PAVEMENT


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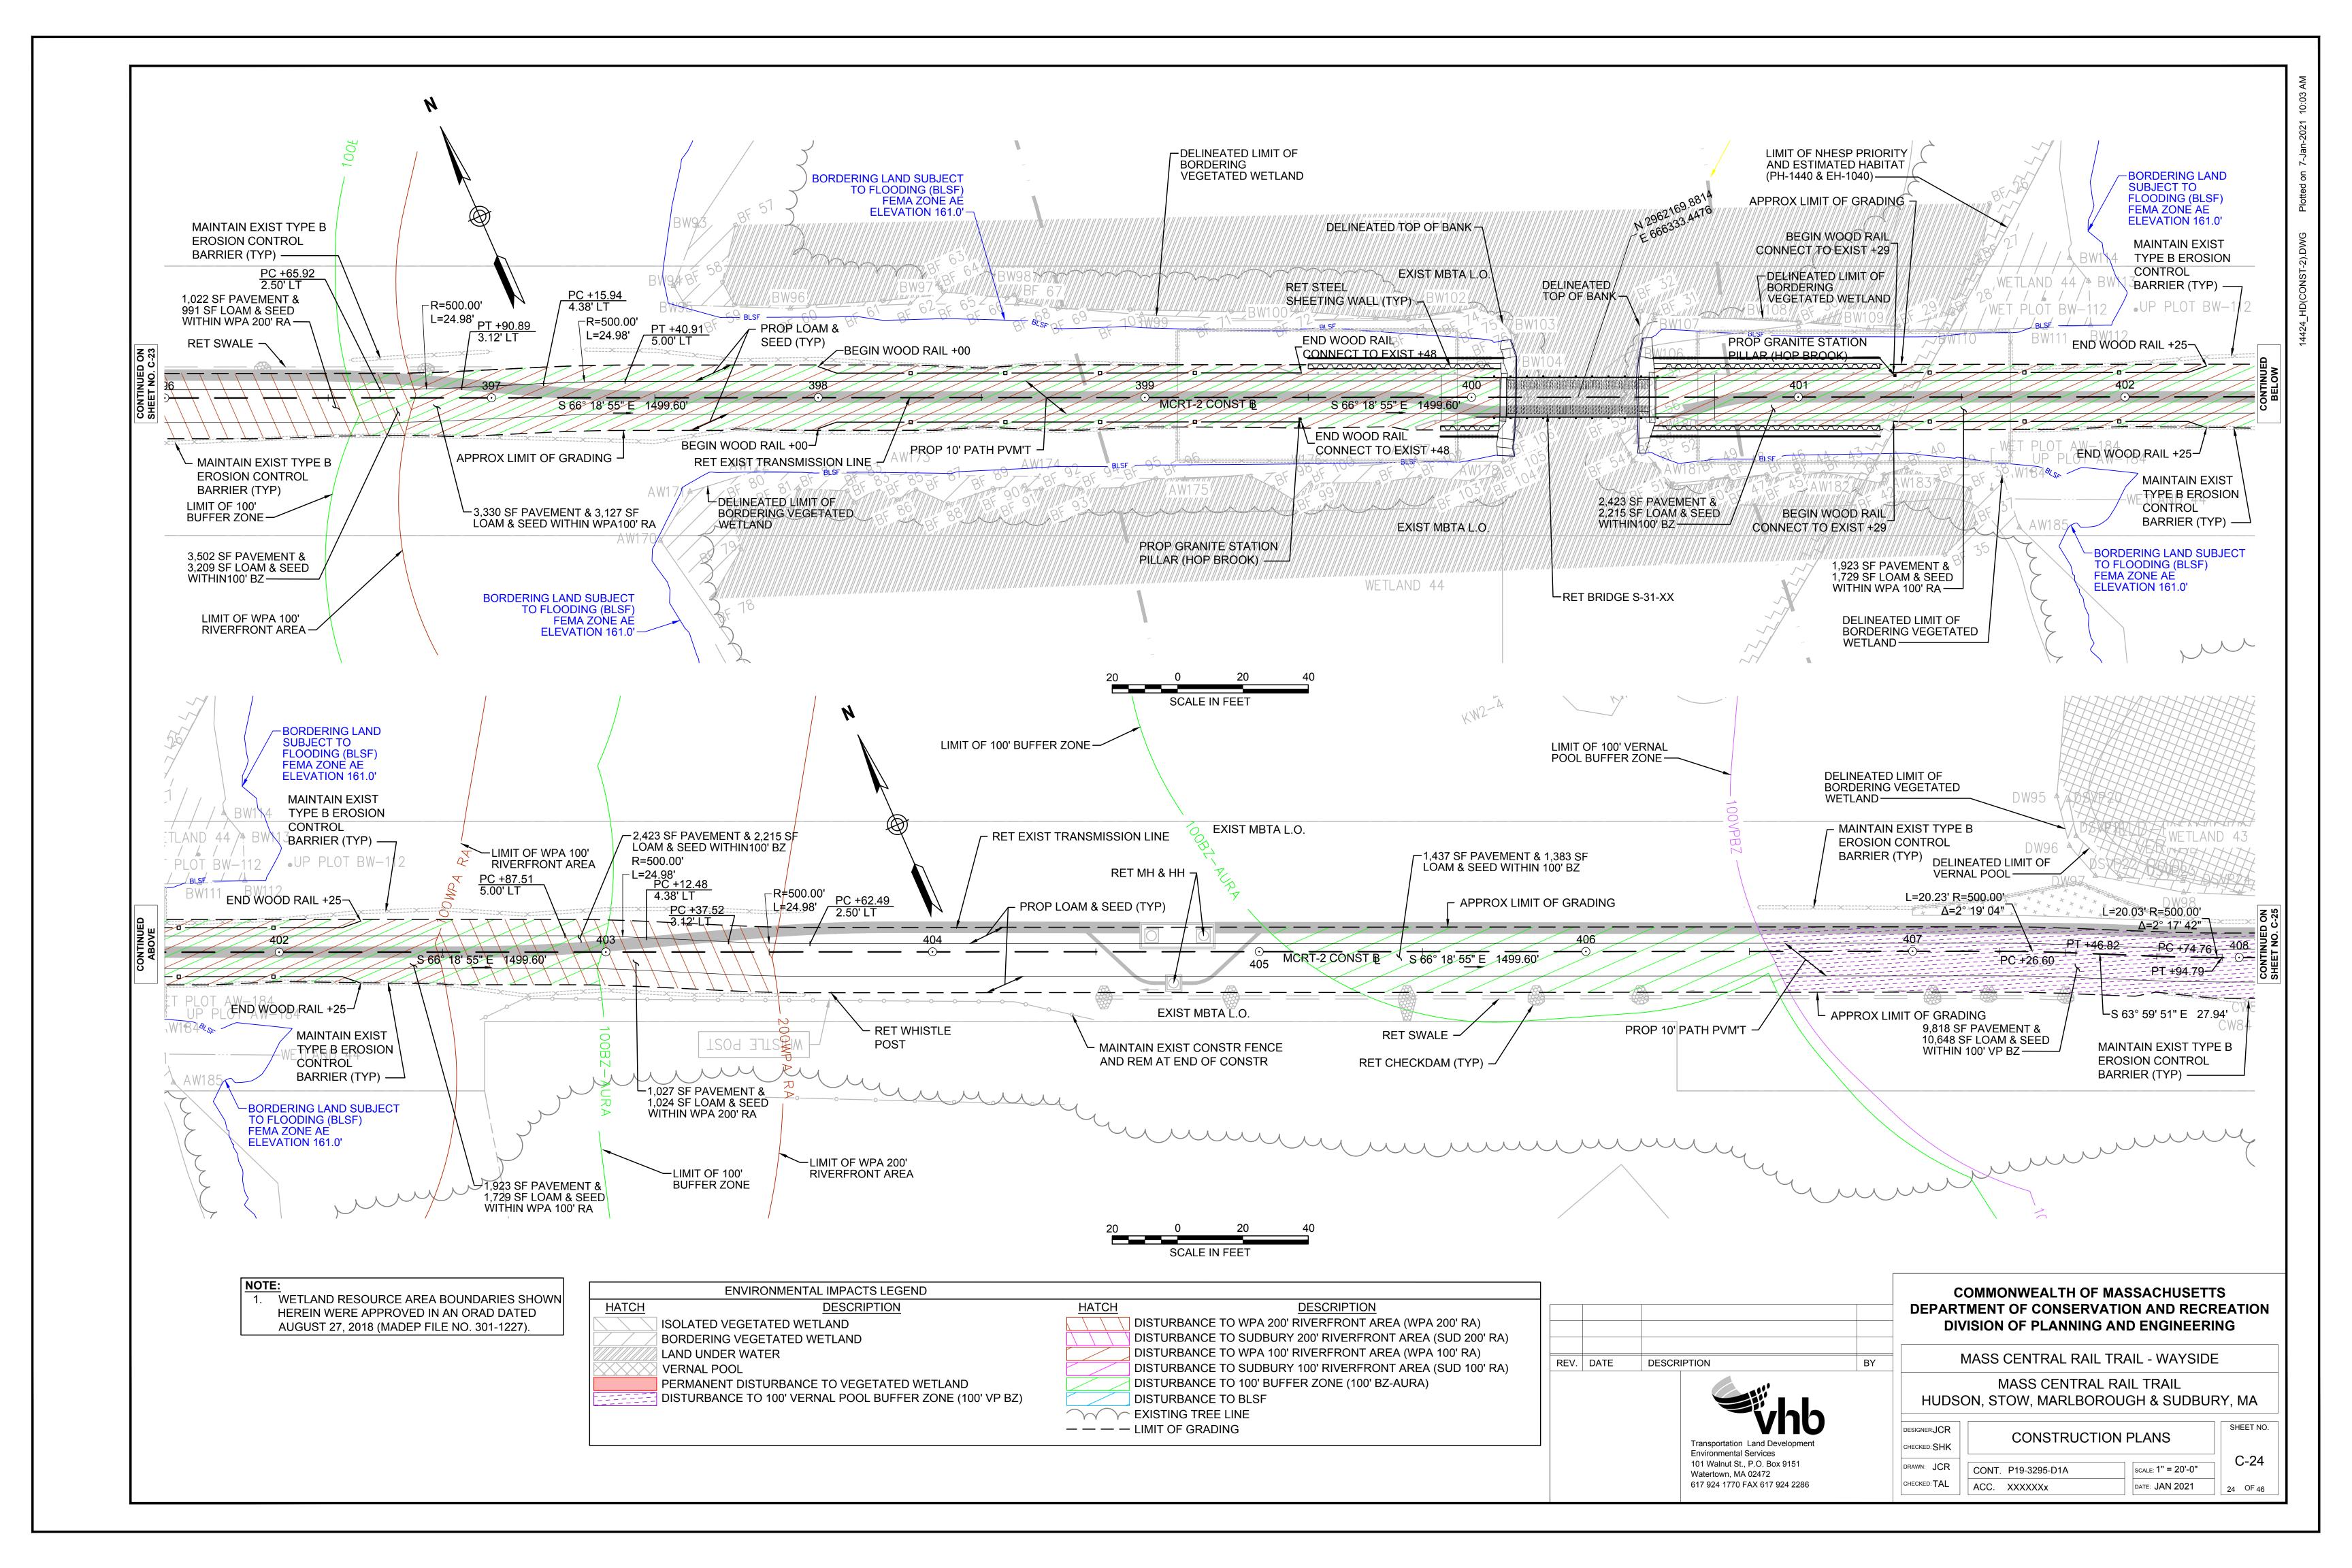
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	DESIGNER: JCR CHECKED: SHK TYPICAL SECTIONS & PVMT NOTES			SHEET NO.	
	DRAWN: JCR CHECKED: TAL	CONT. P19-3295-D1A ACC. XXXXXXX	SCALE: 1" = 20'-0" DATE: JAN 2021	TS-02 2 OF 2	







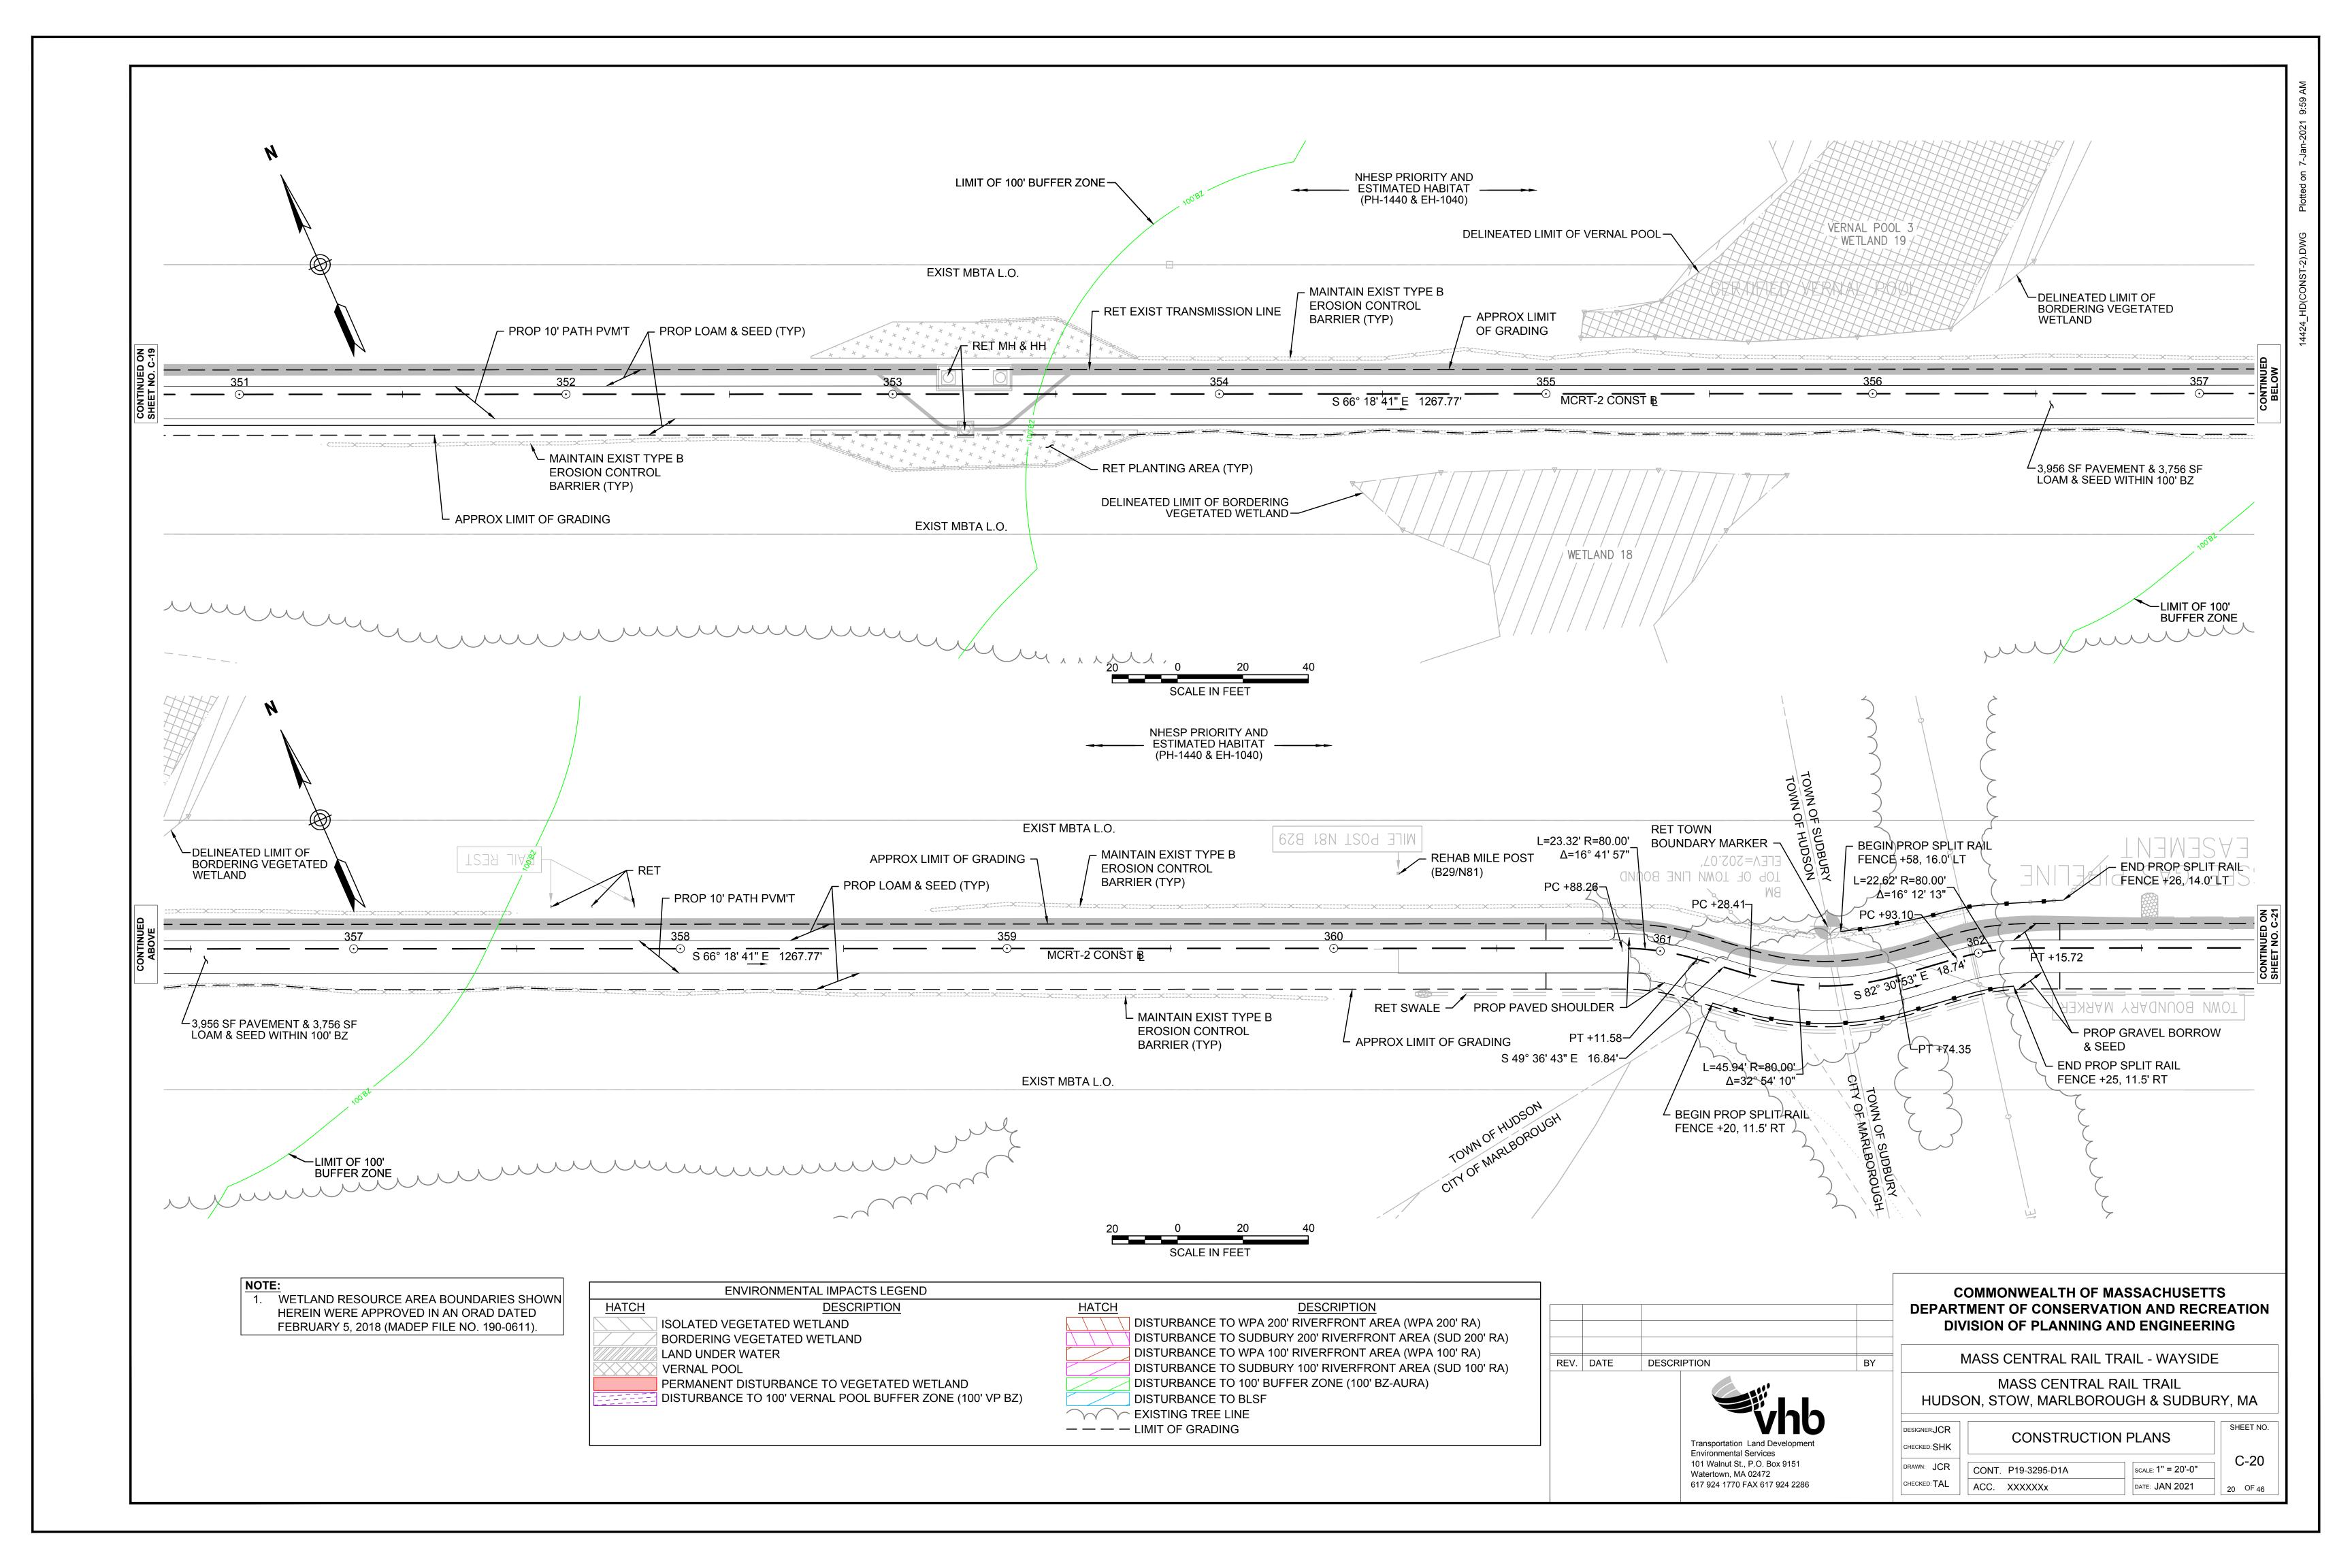


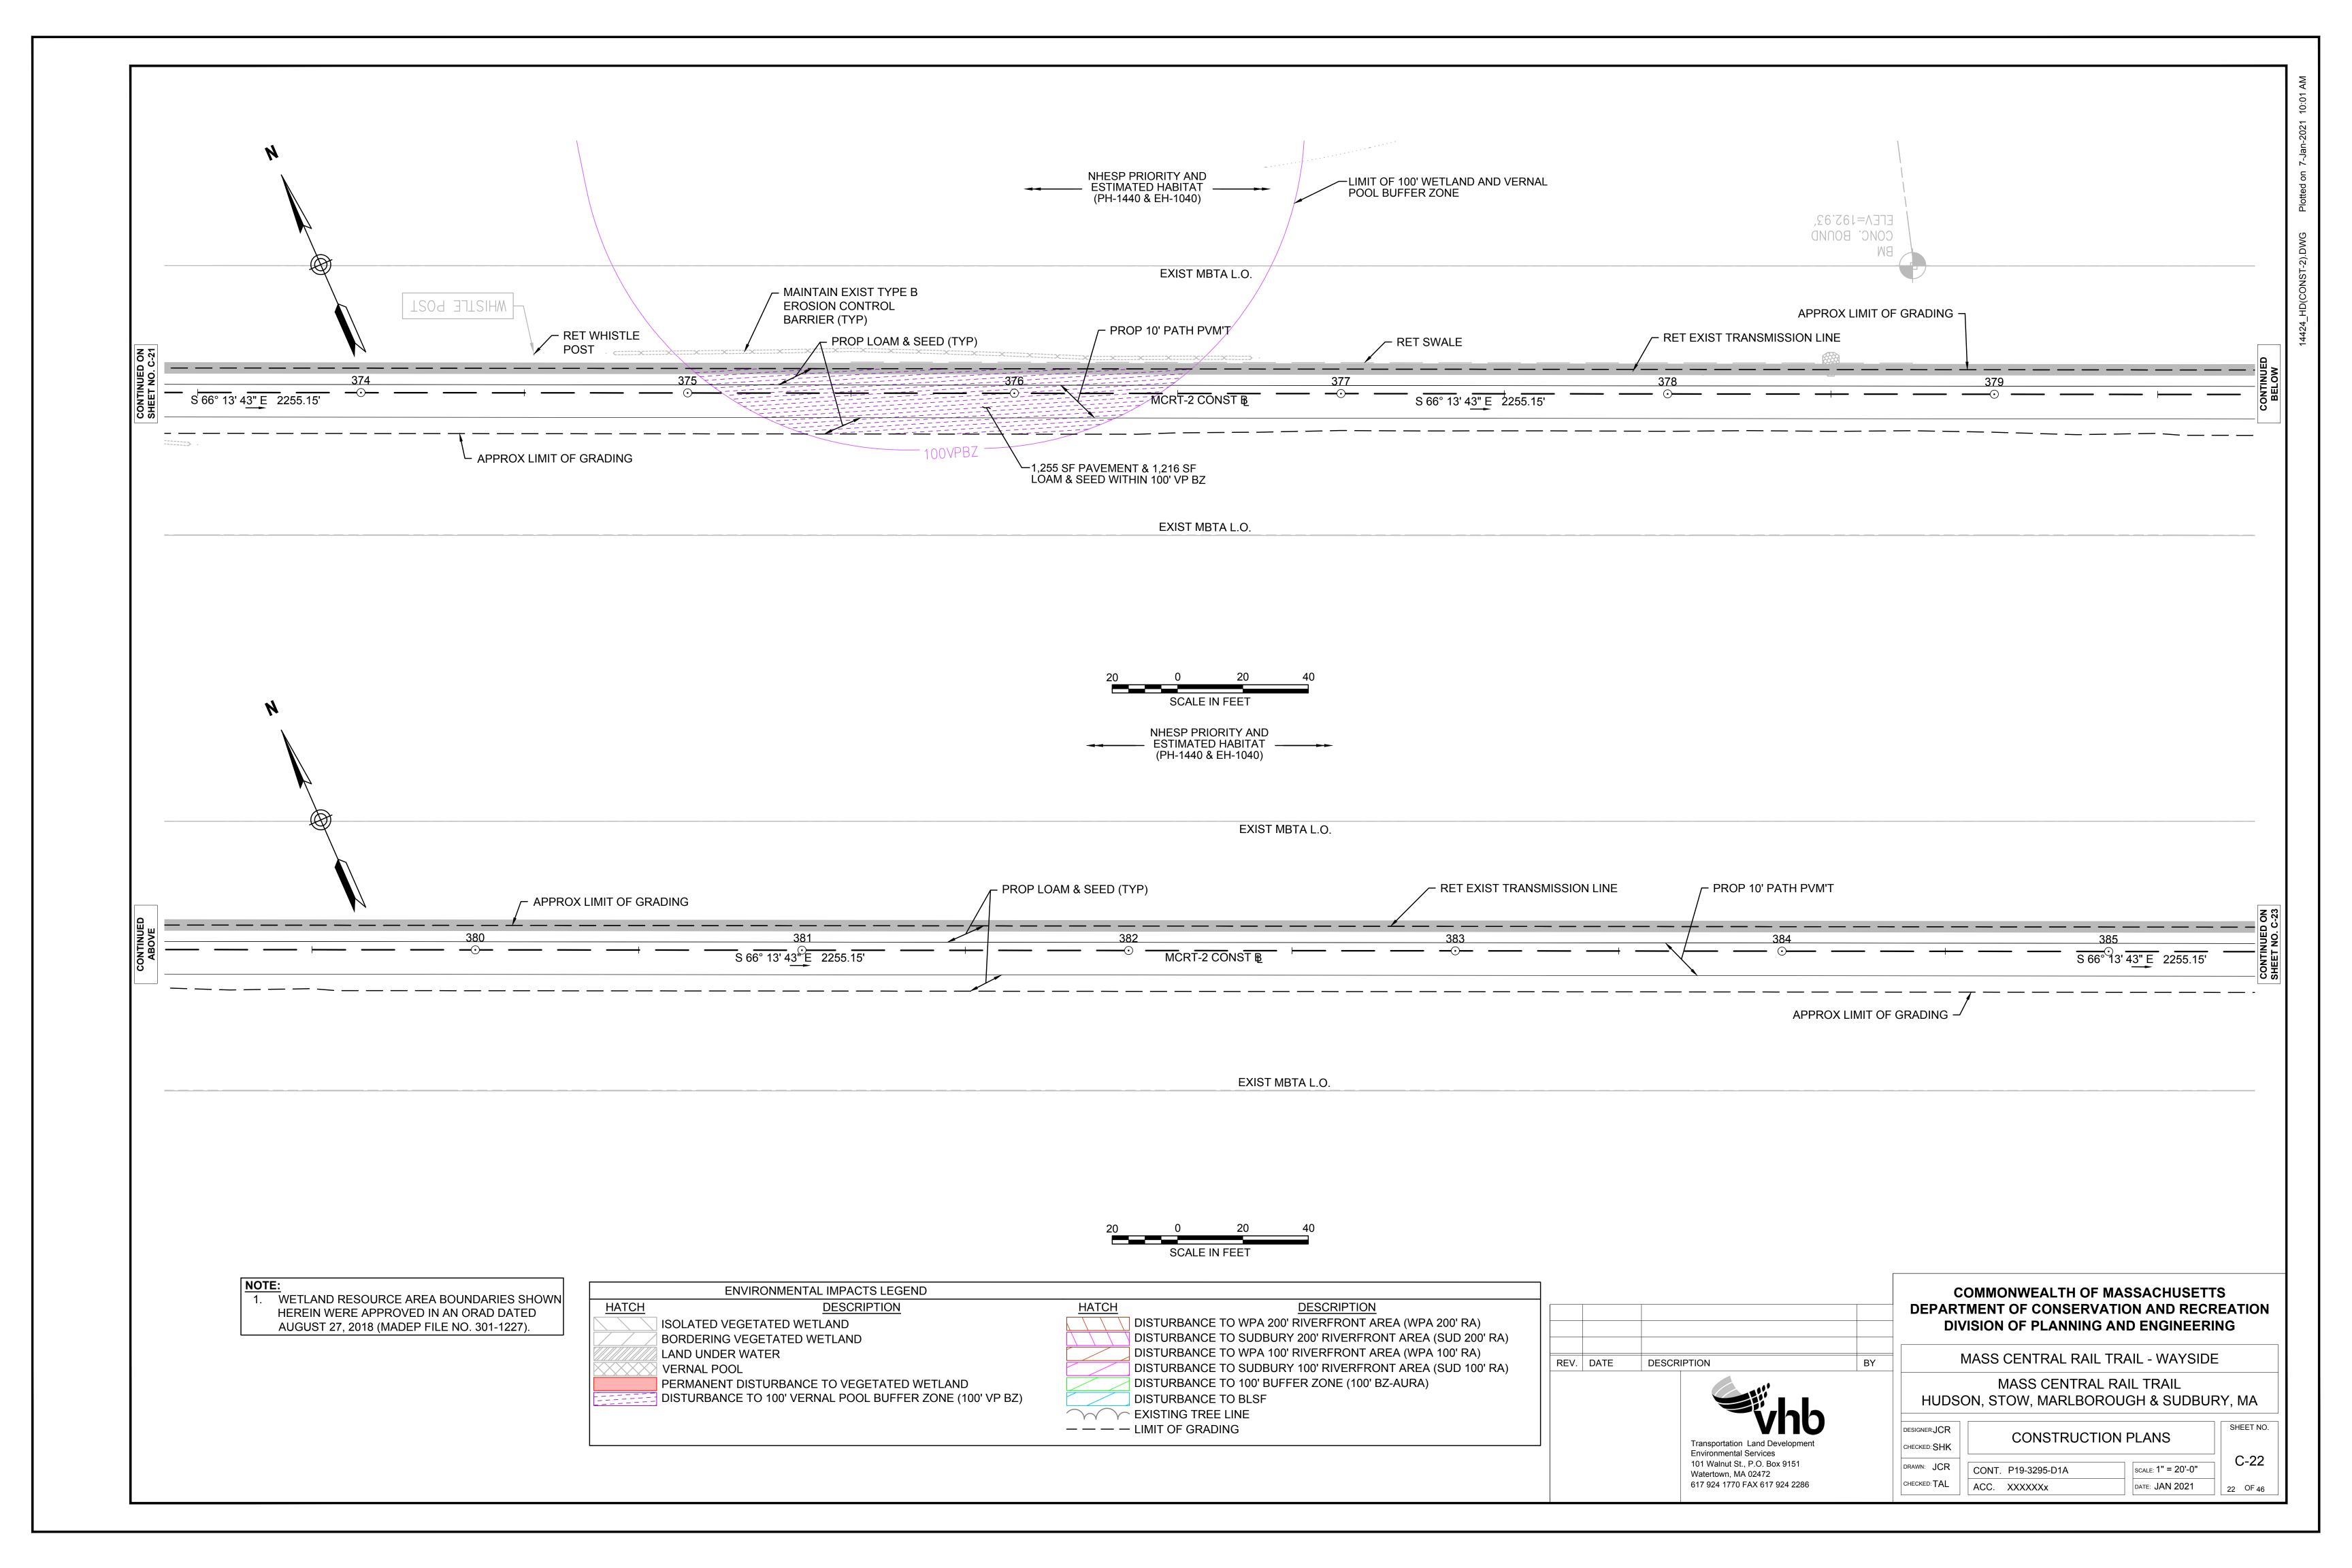


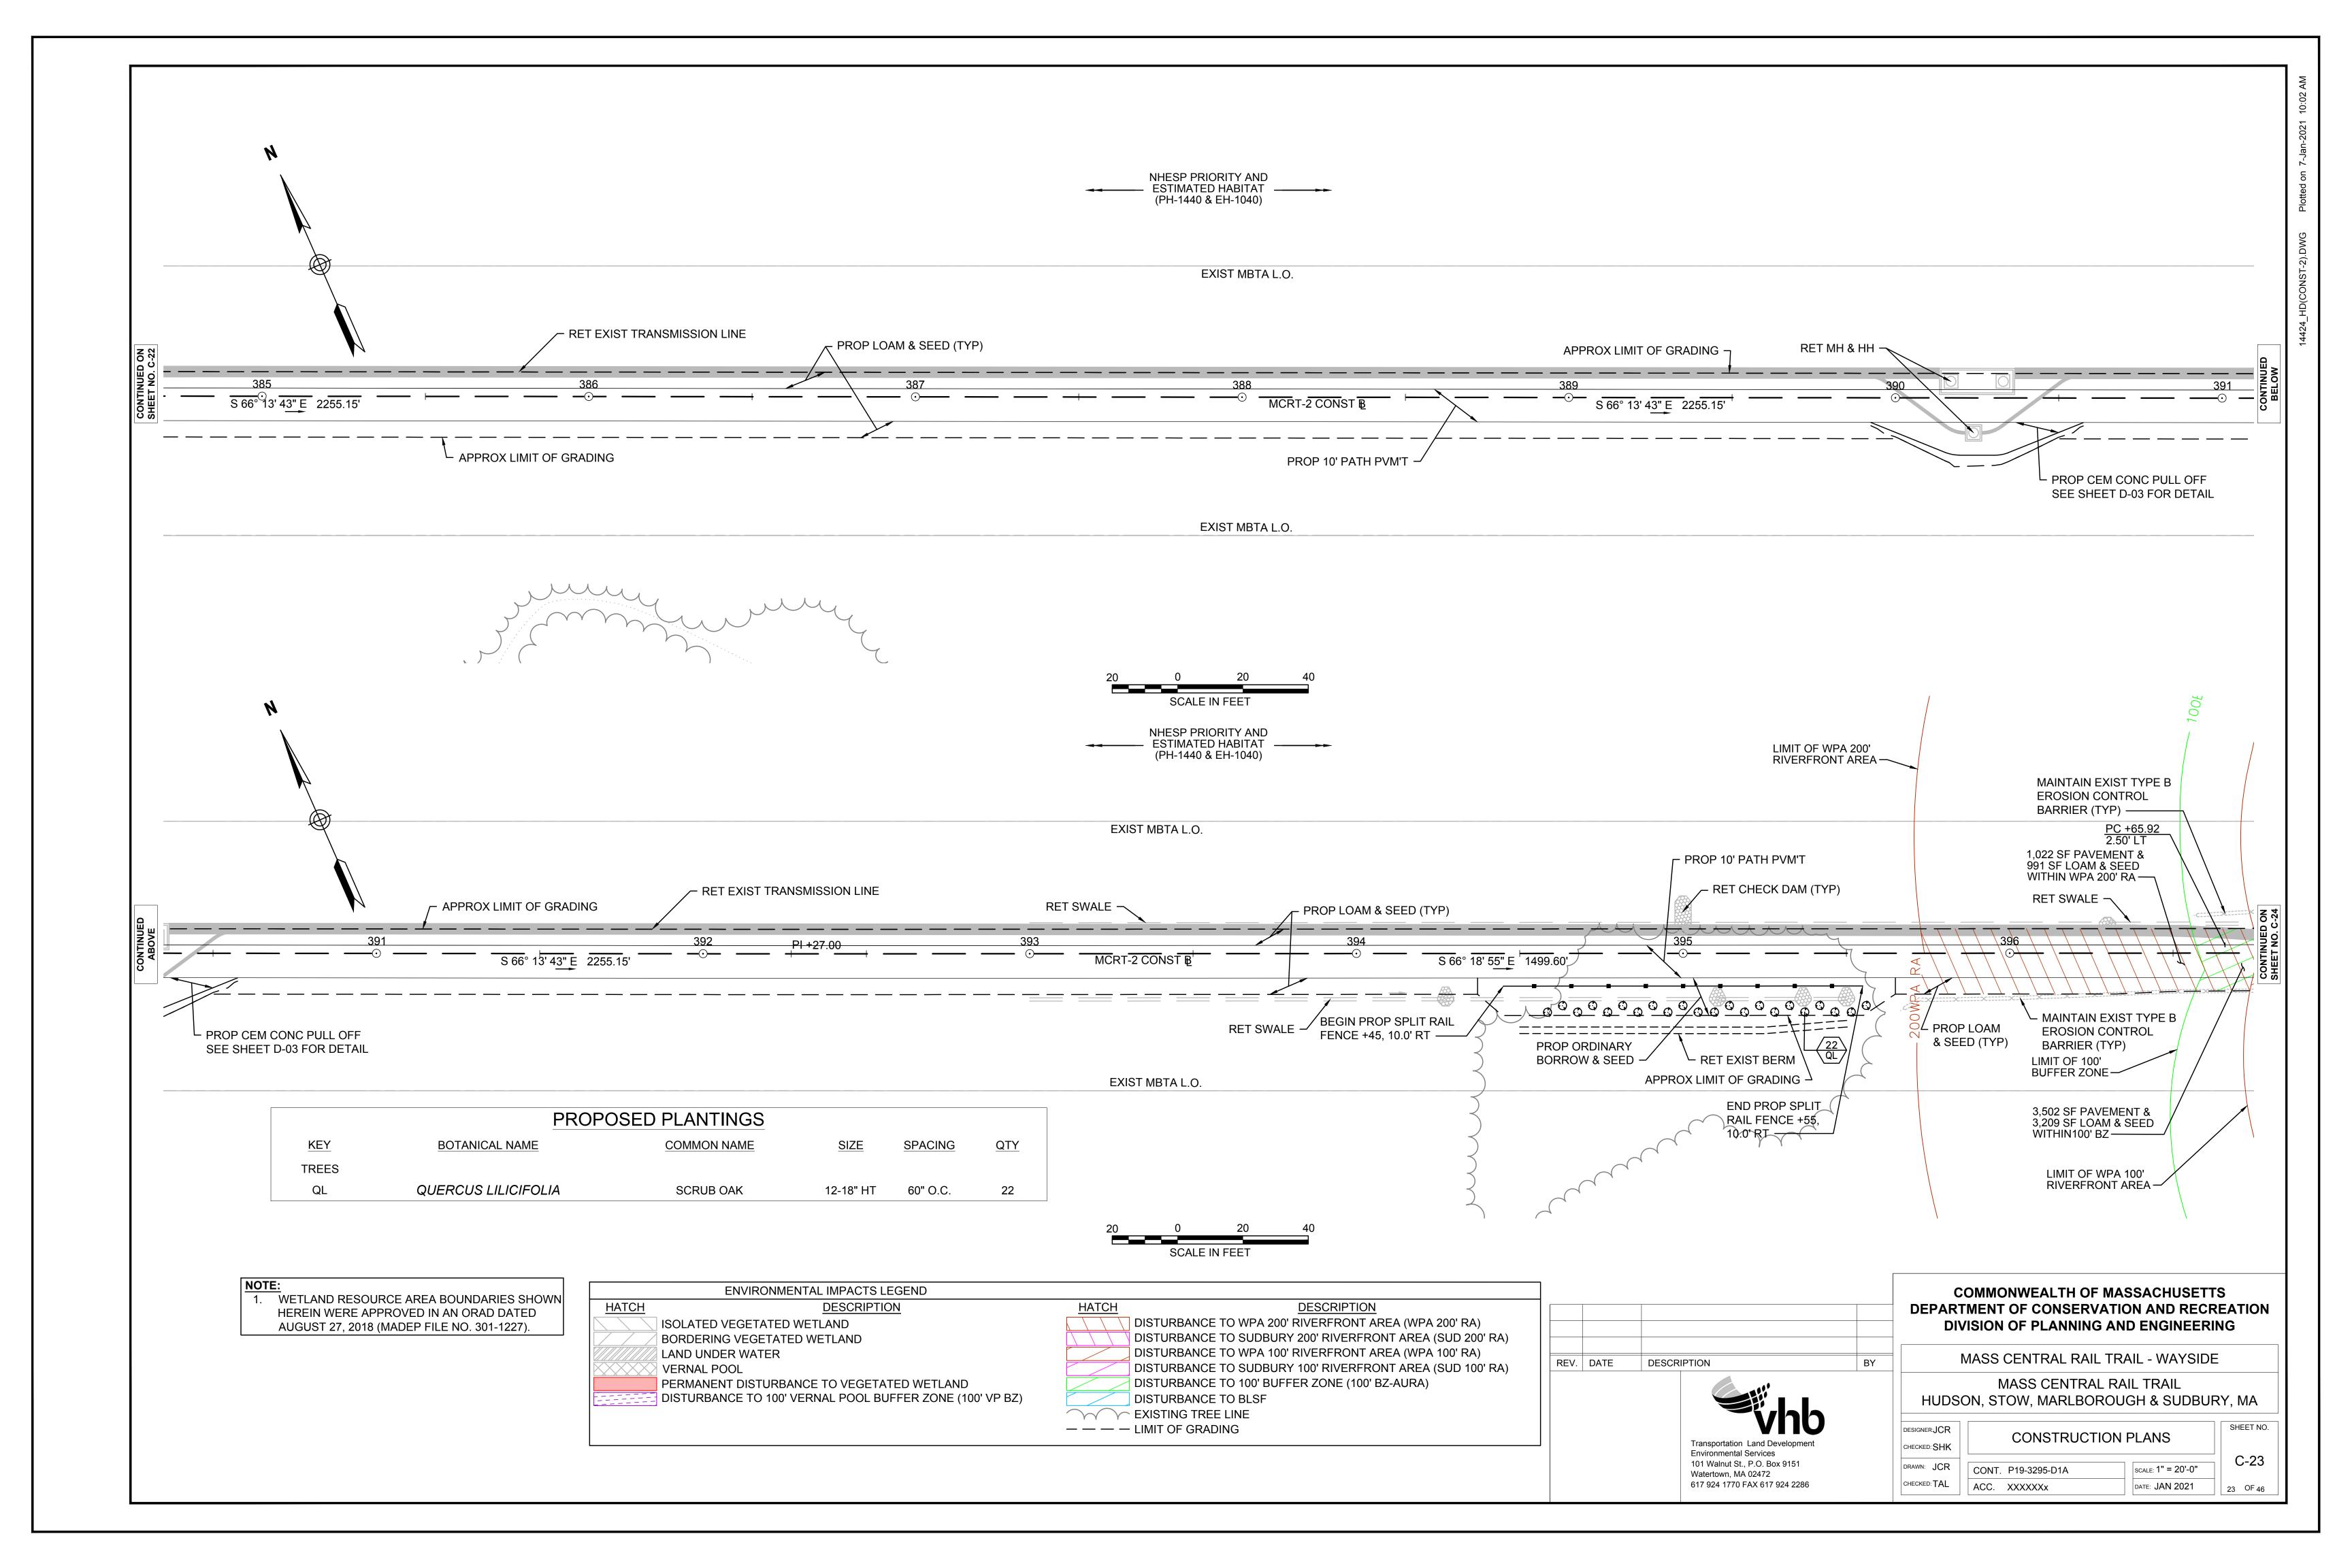


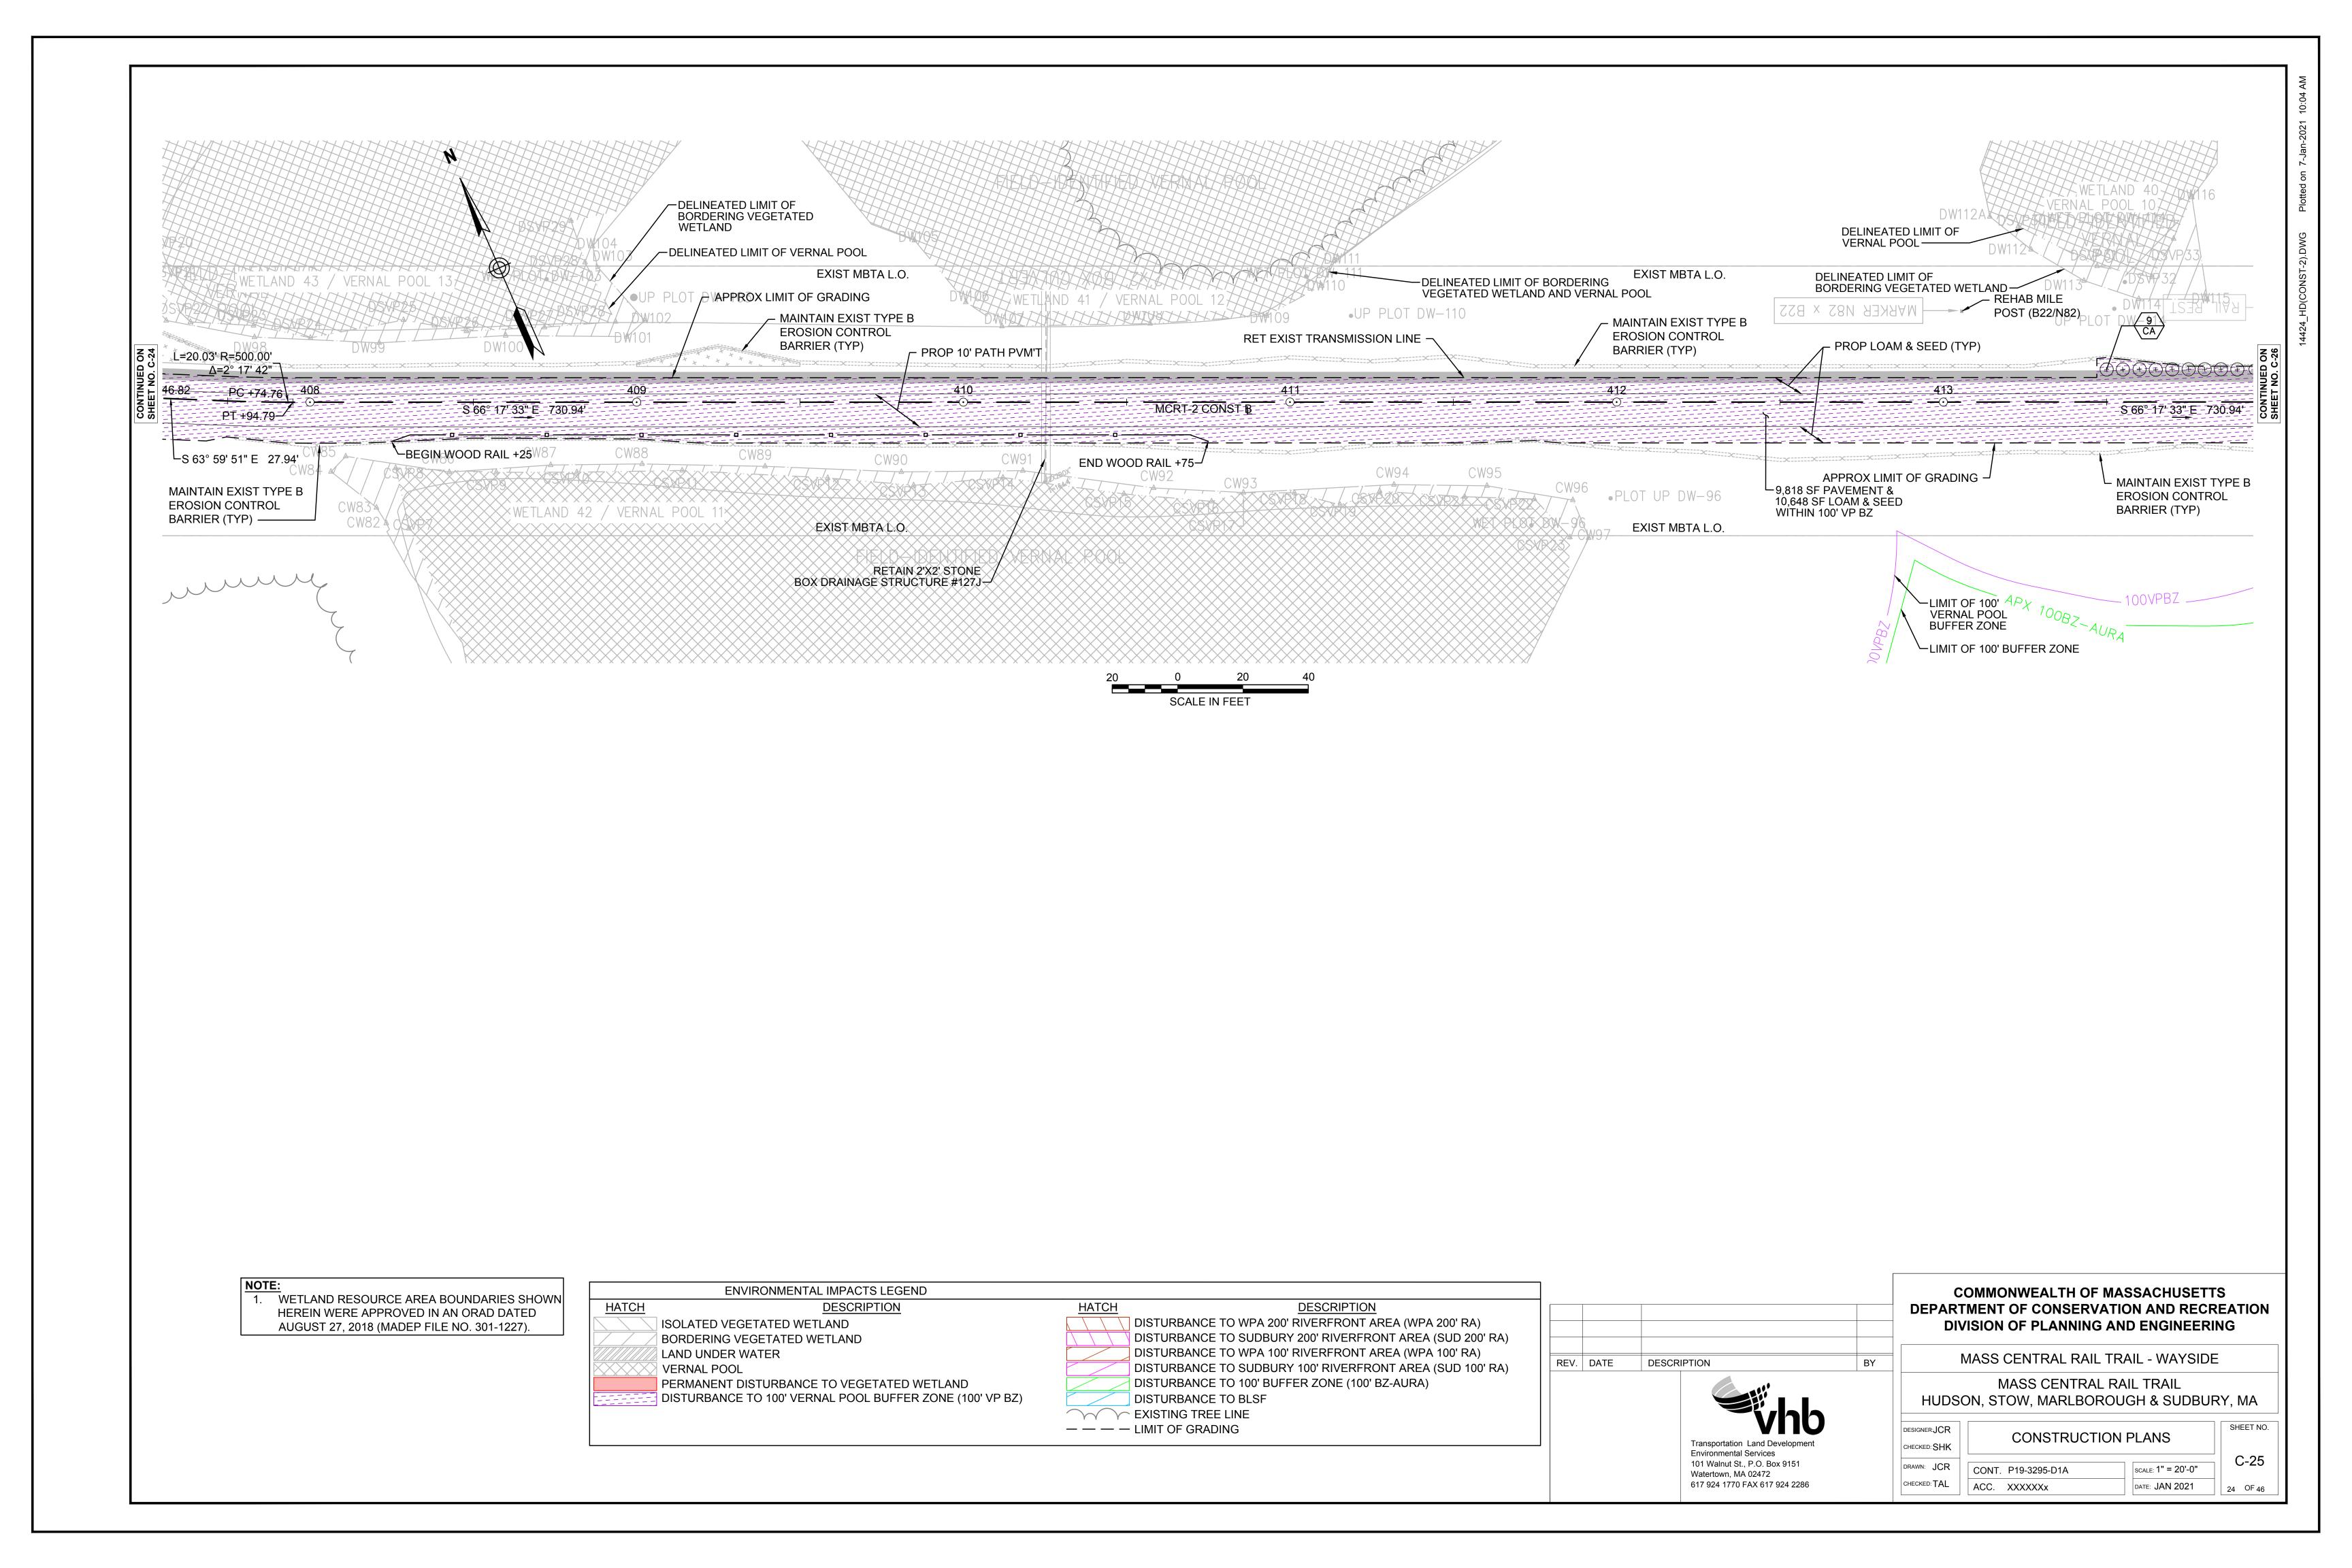


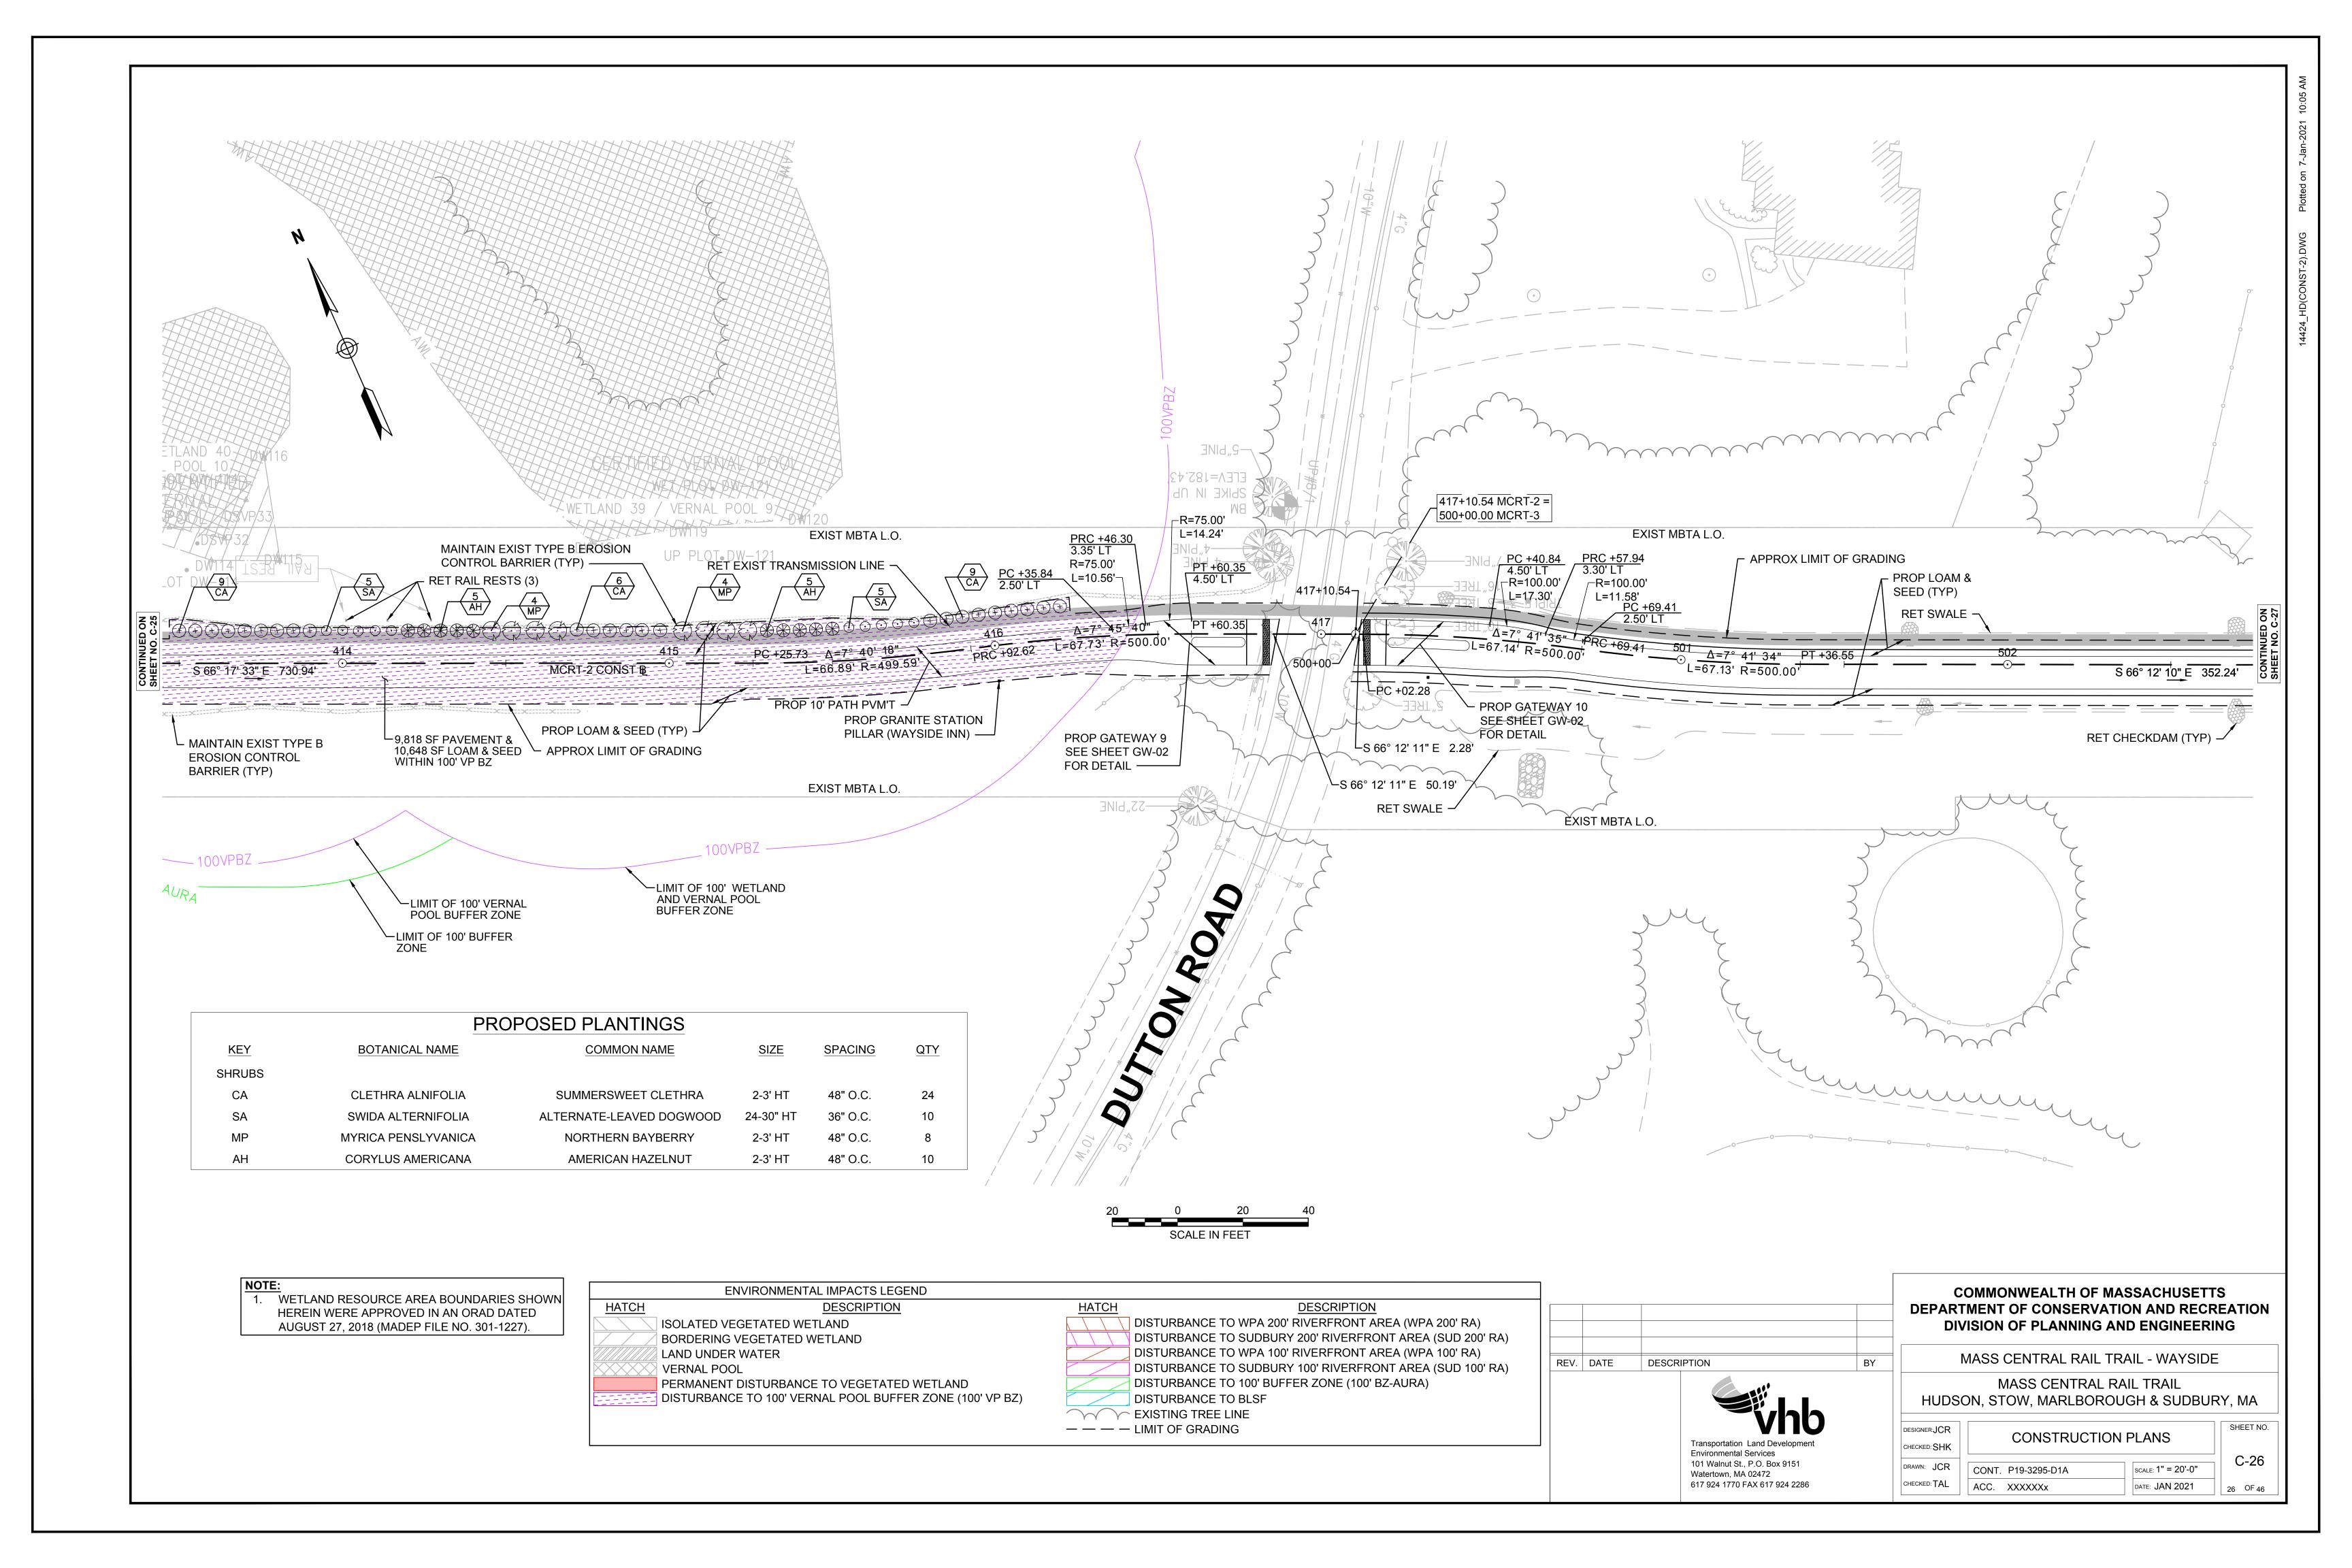


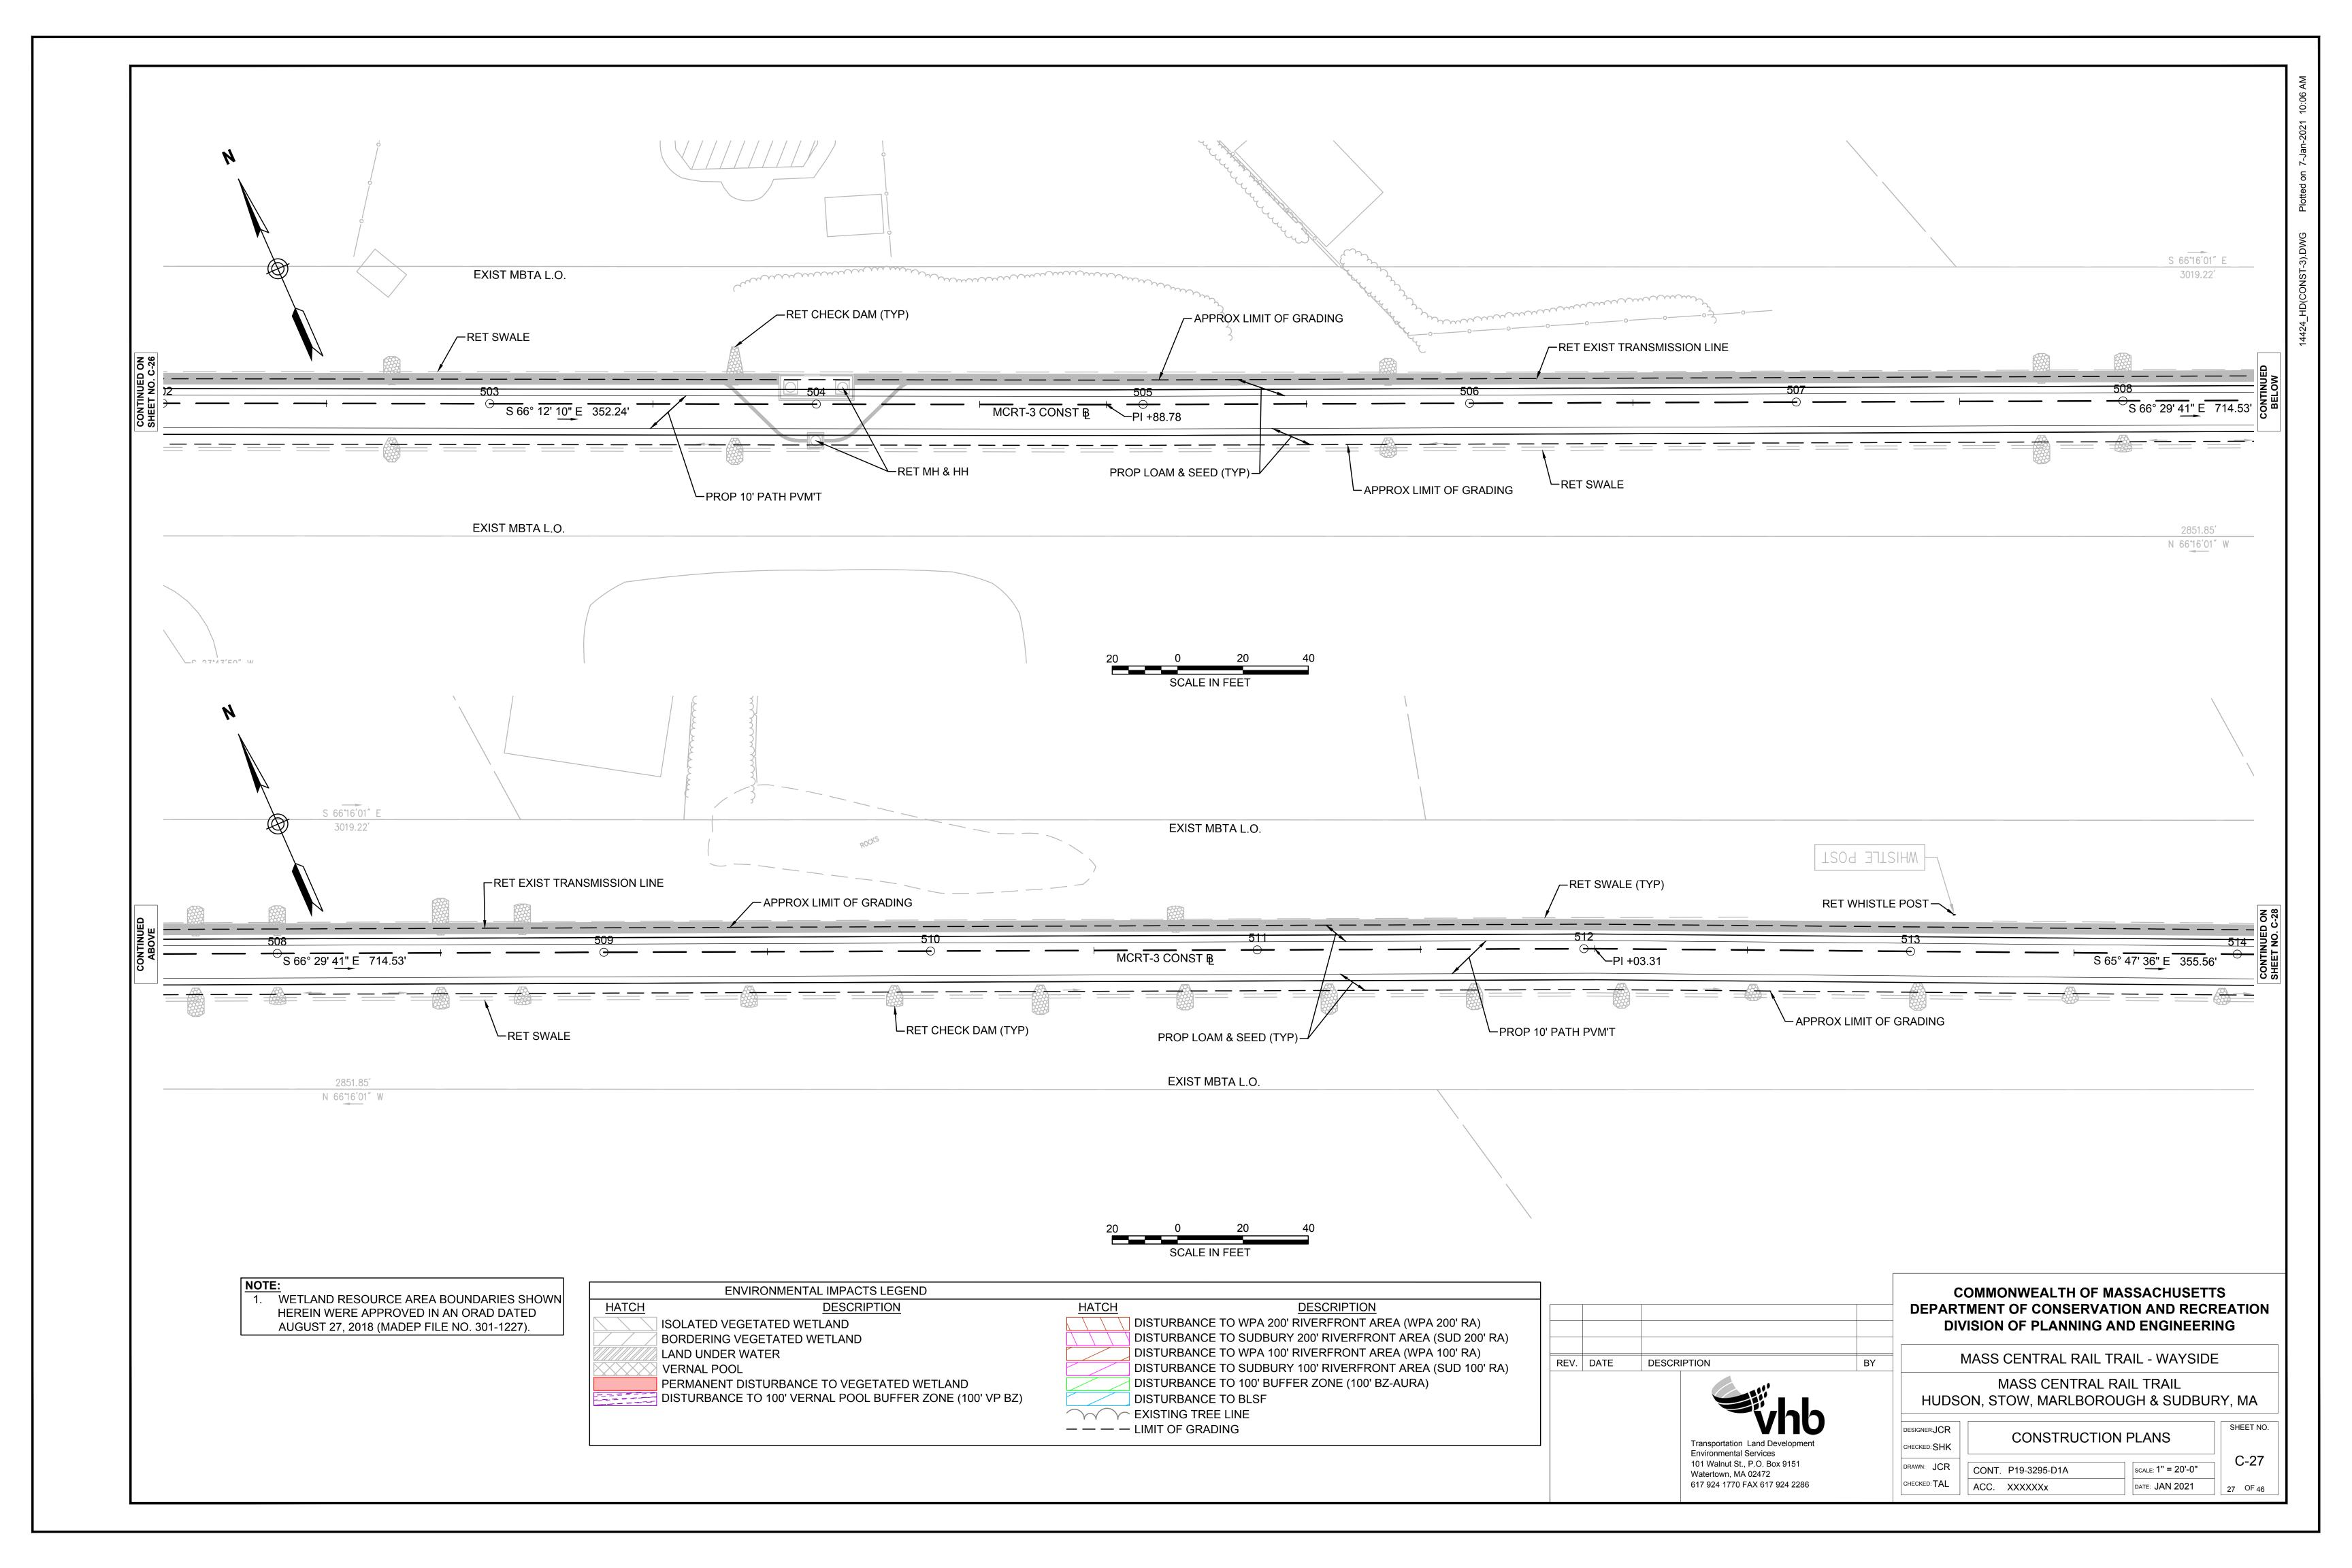


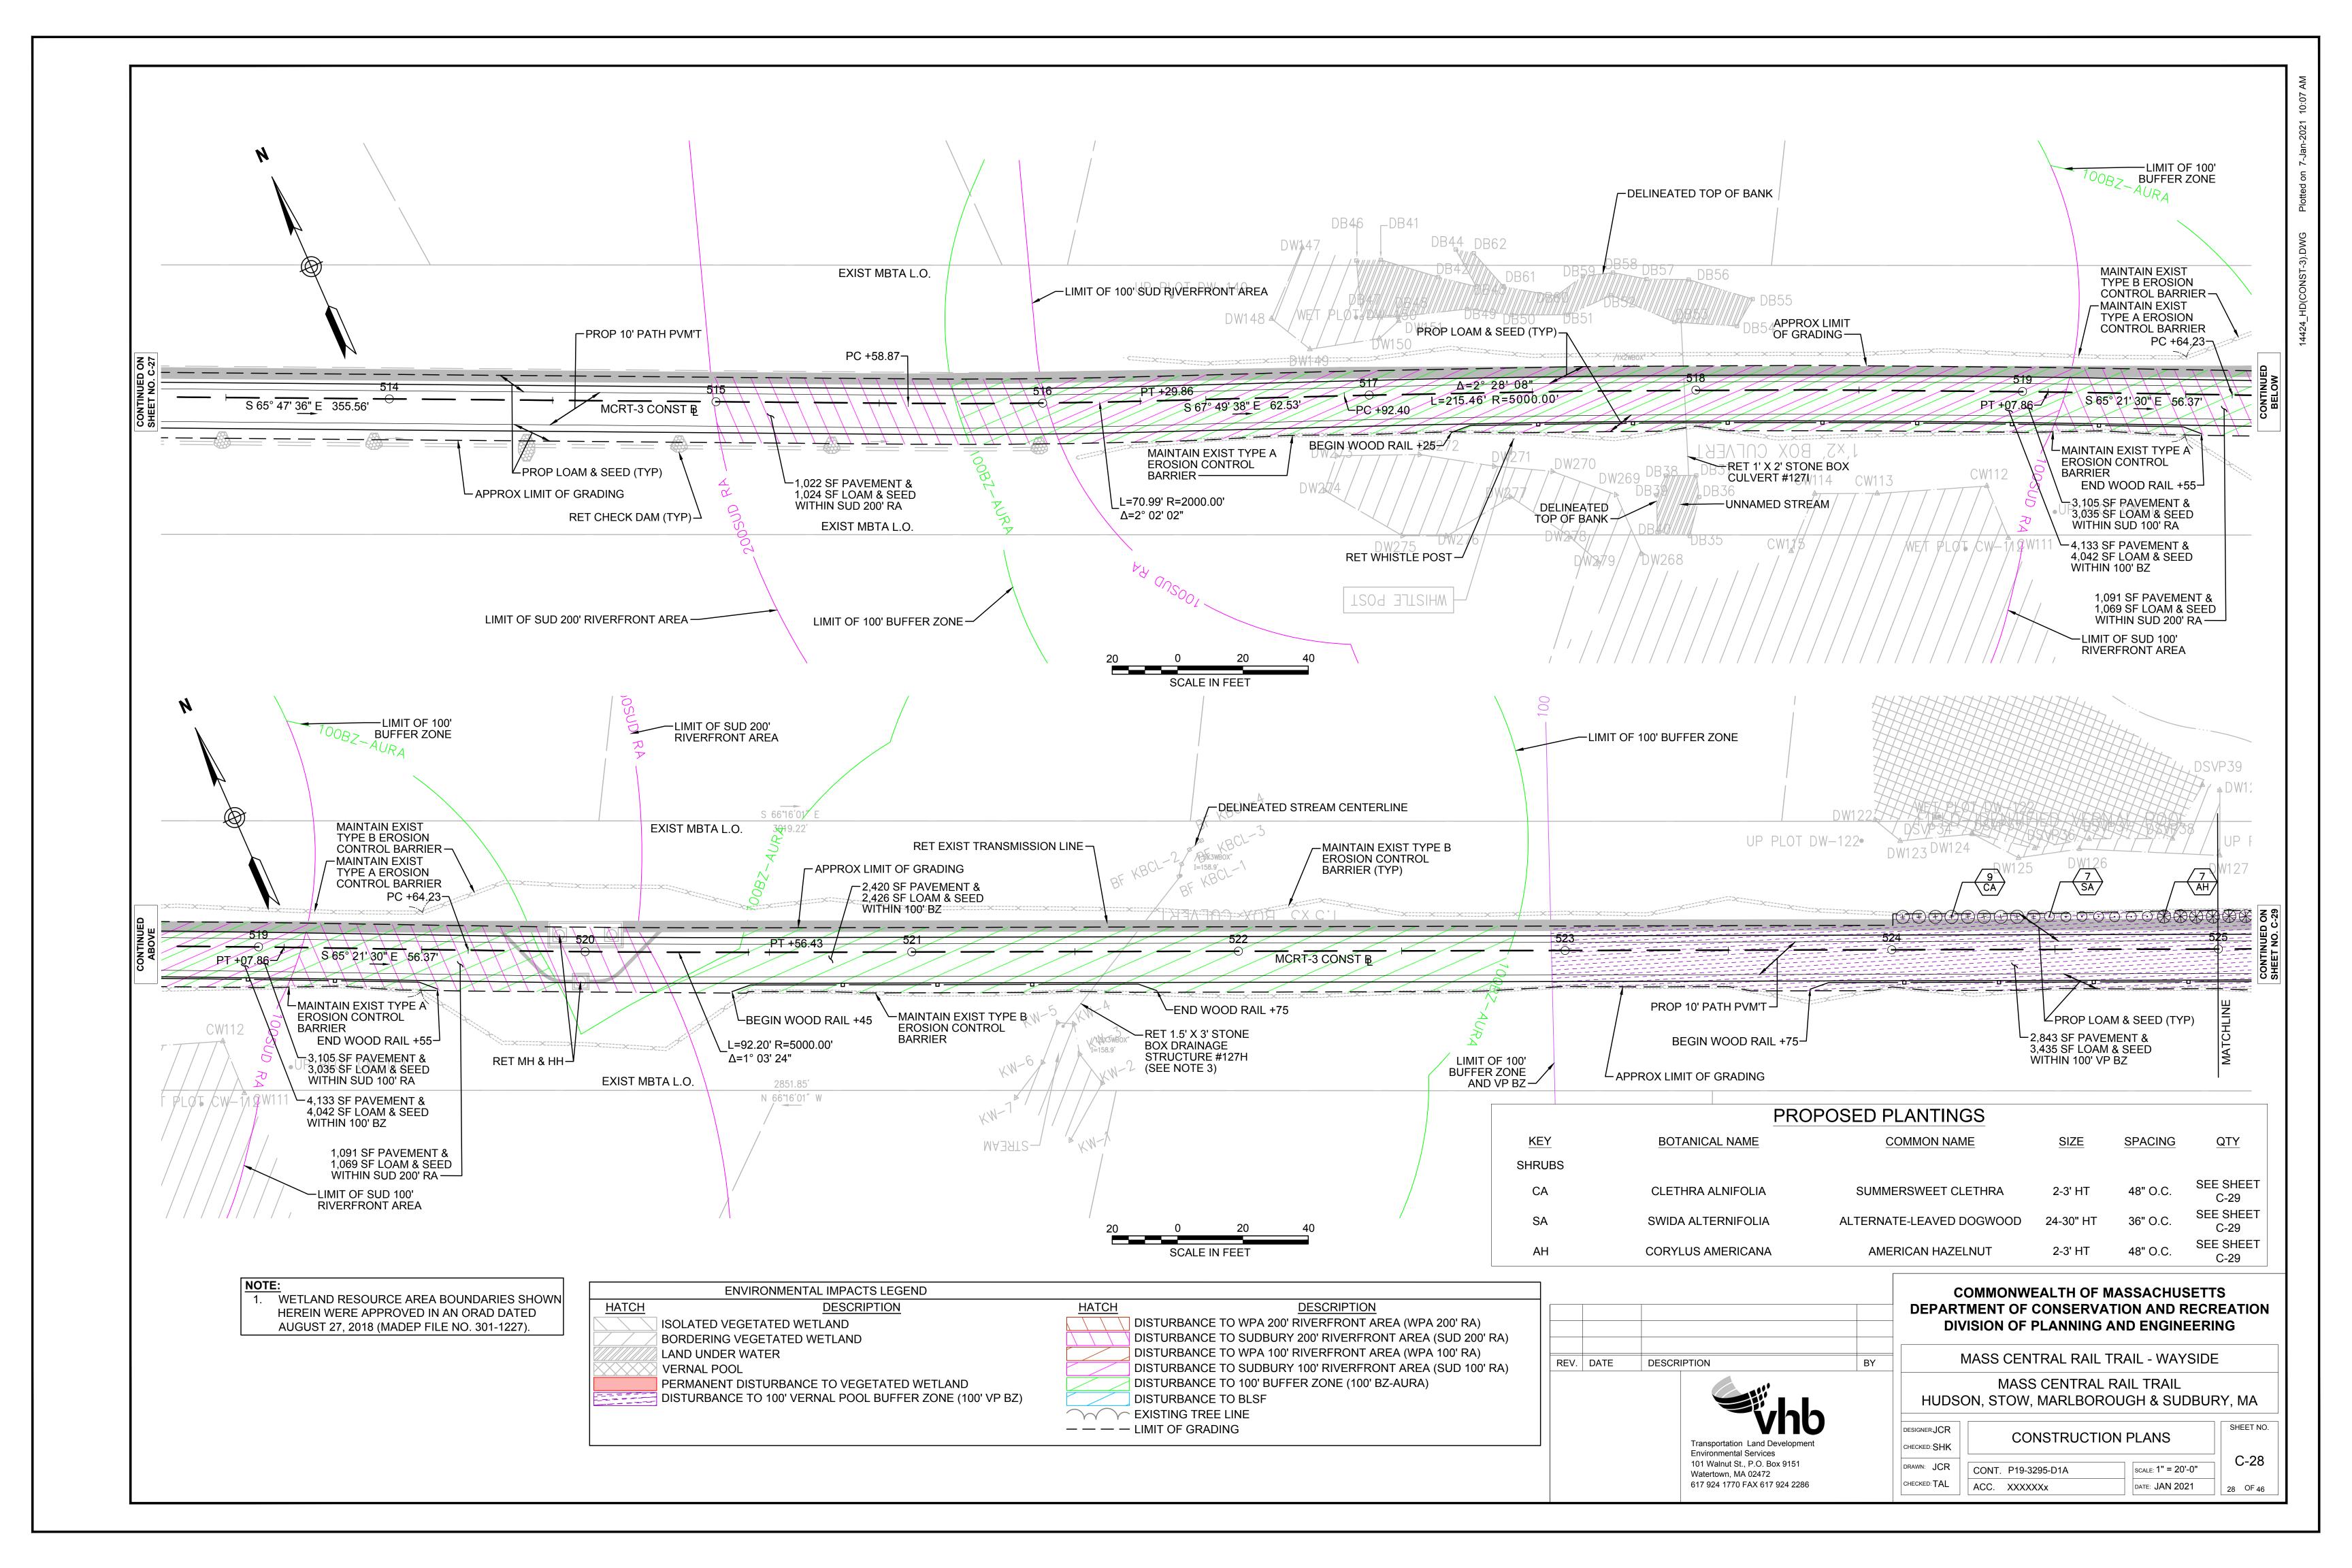


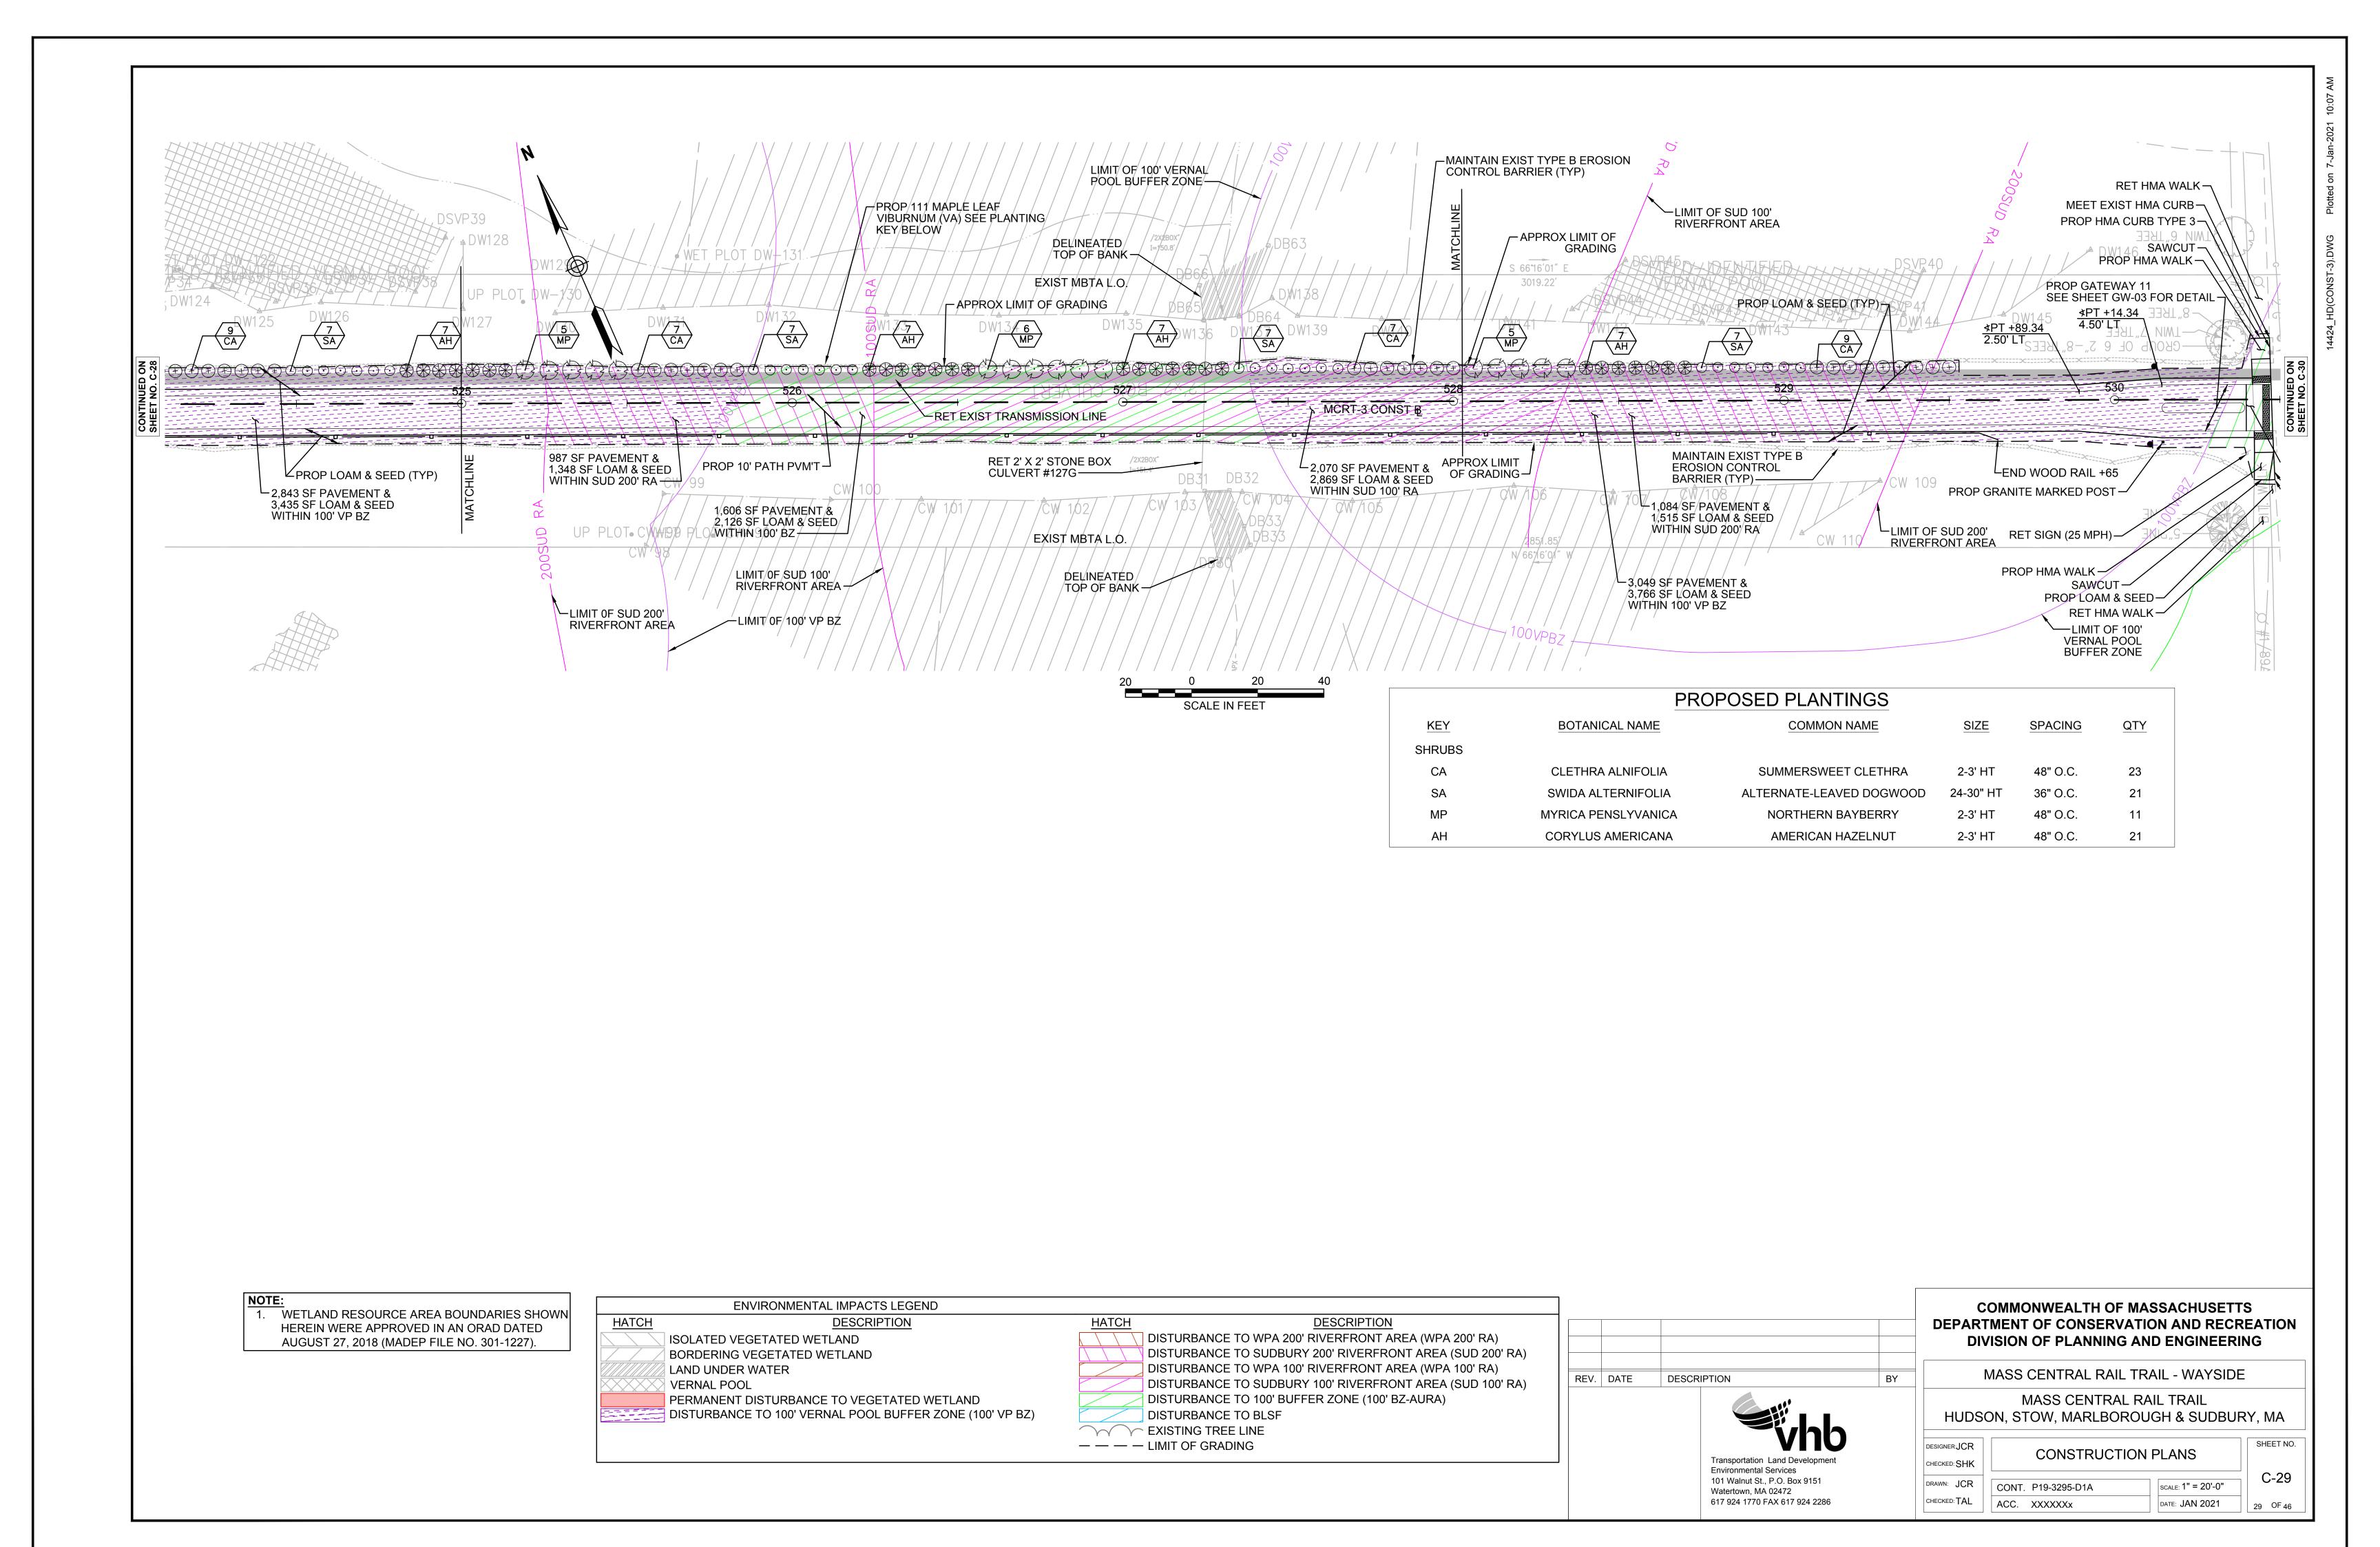


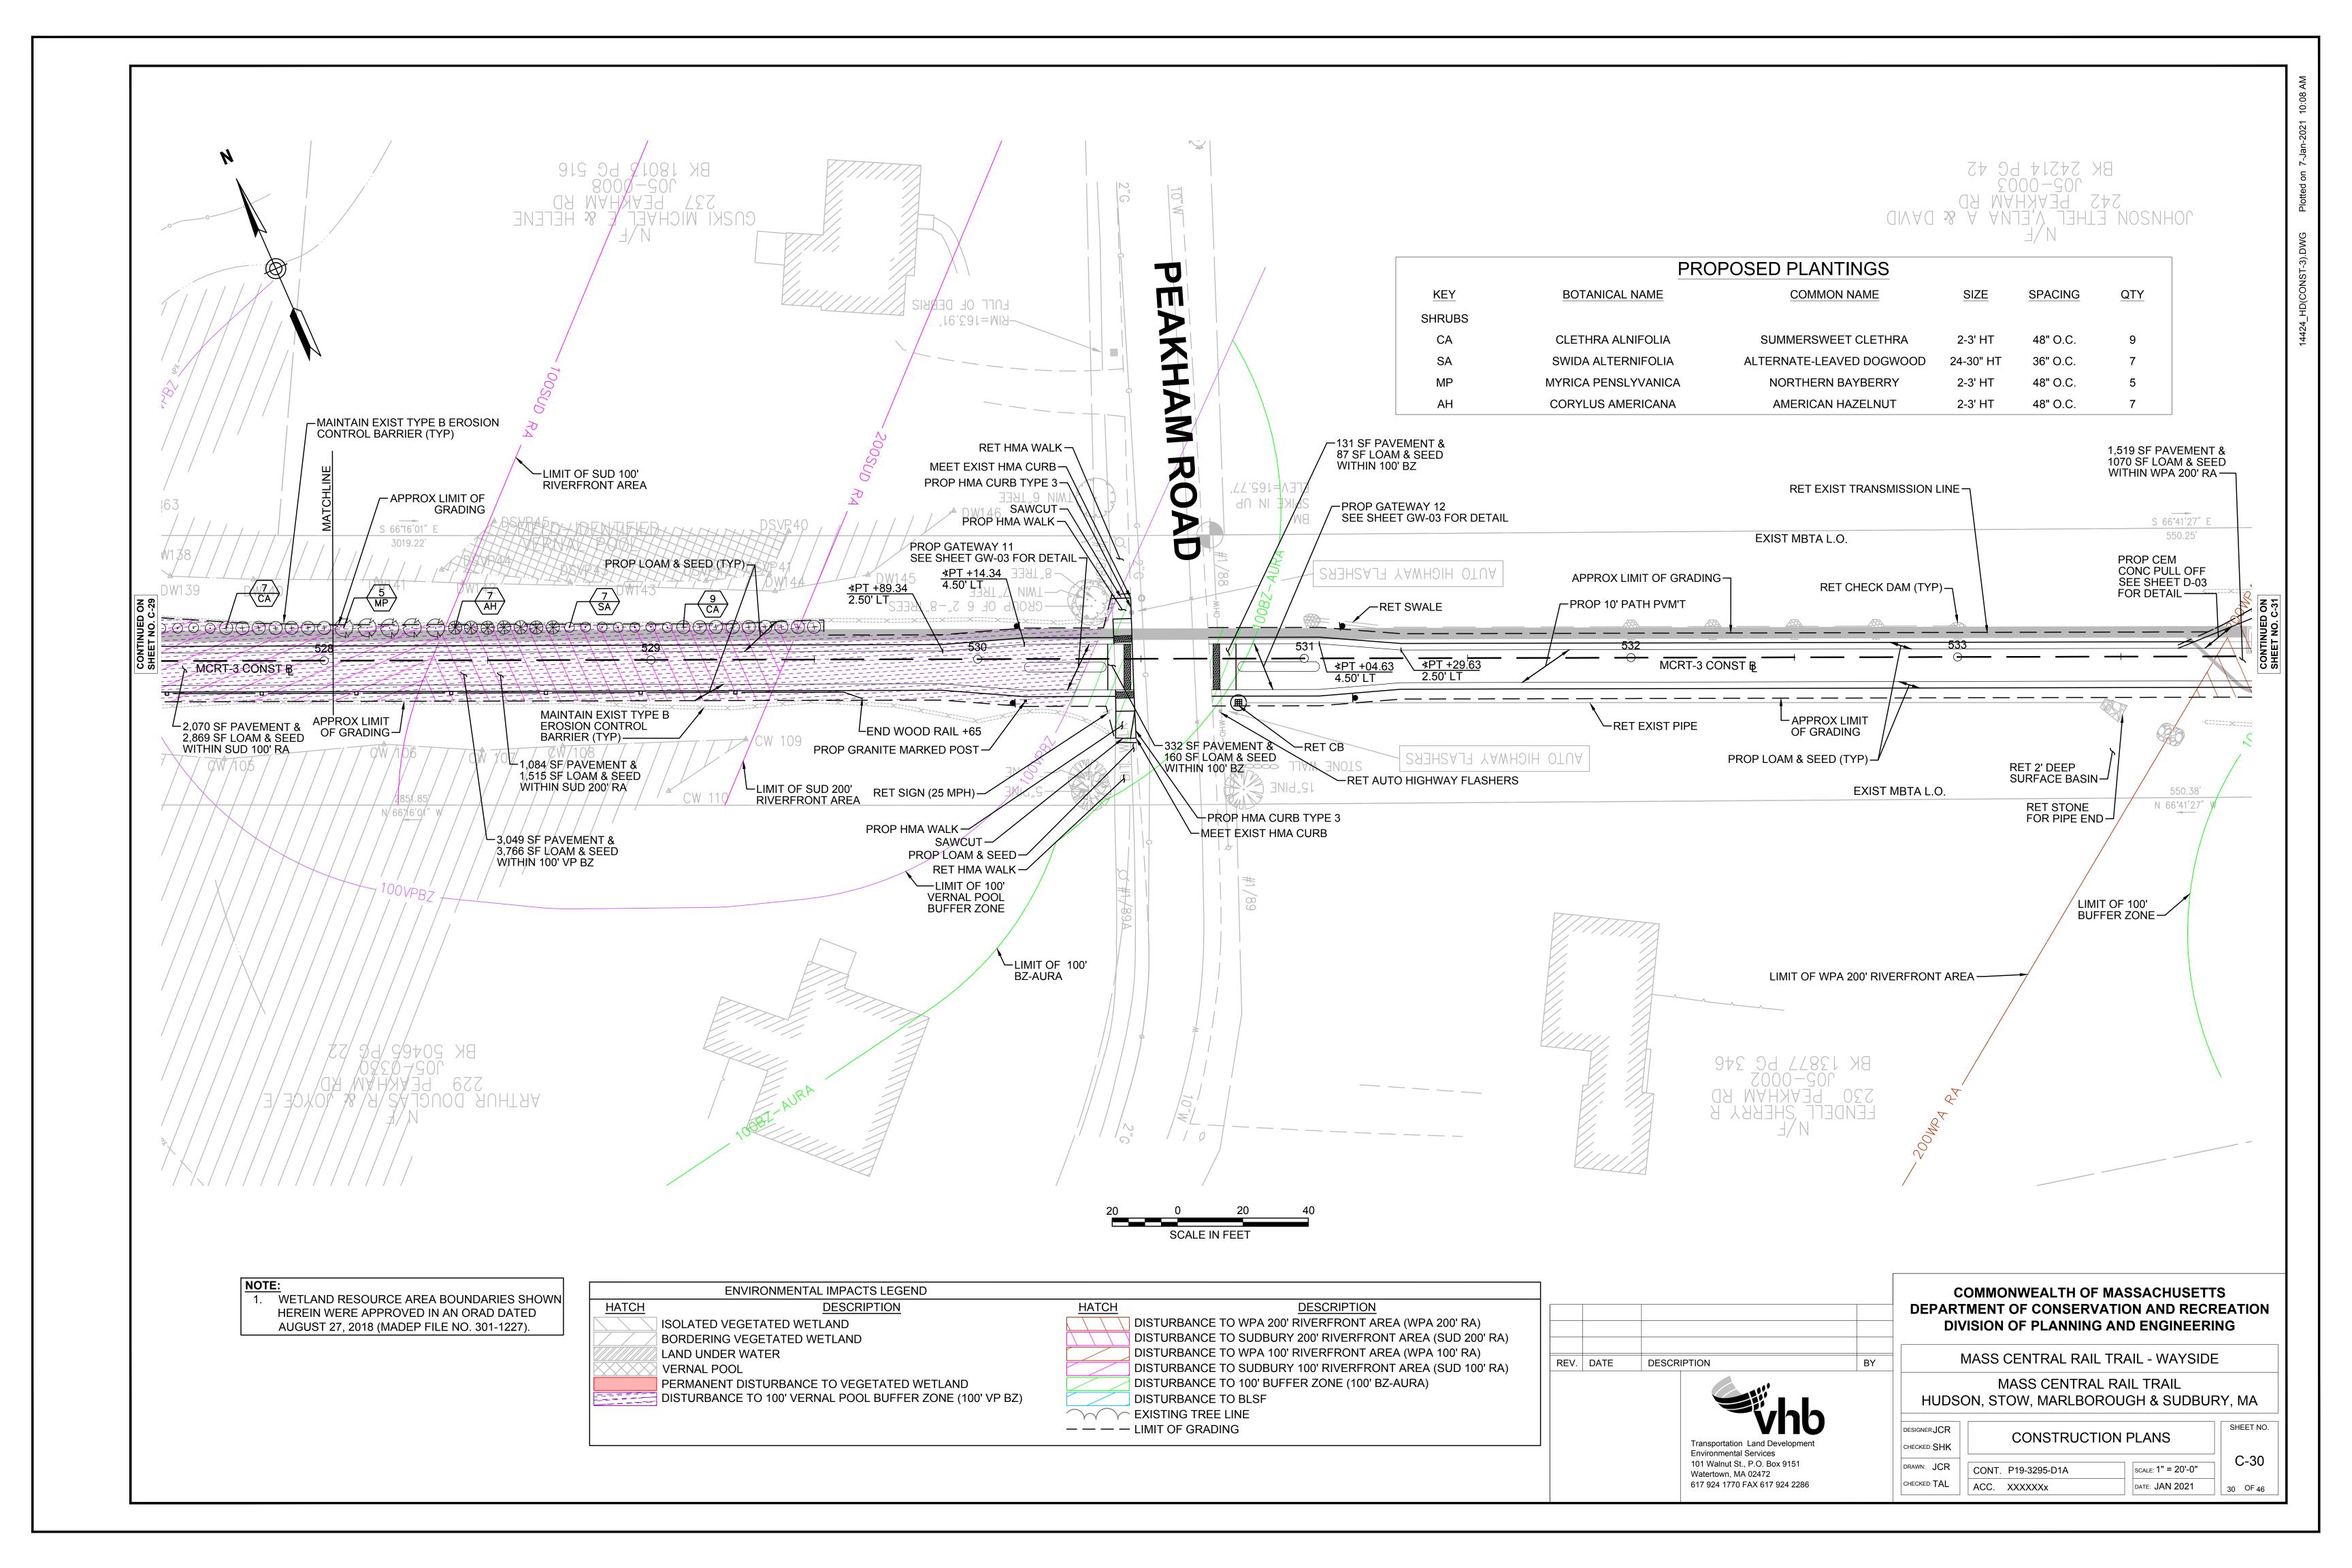


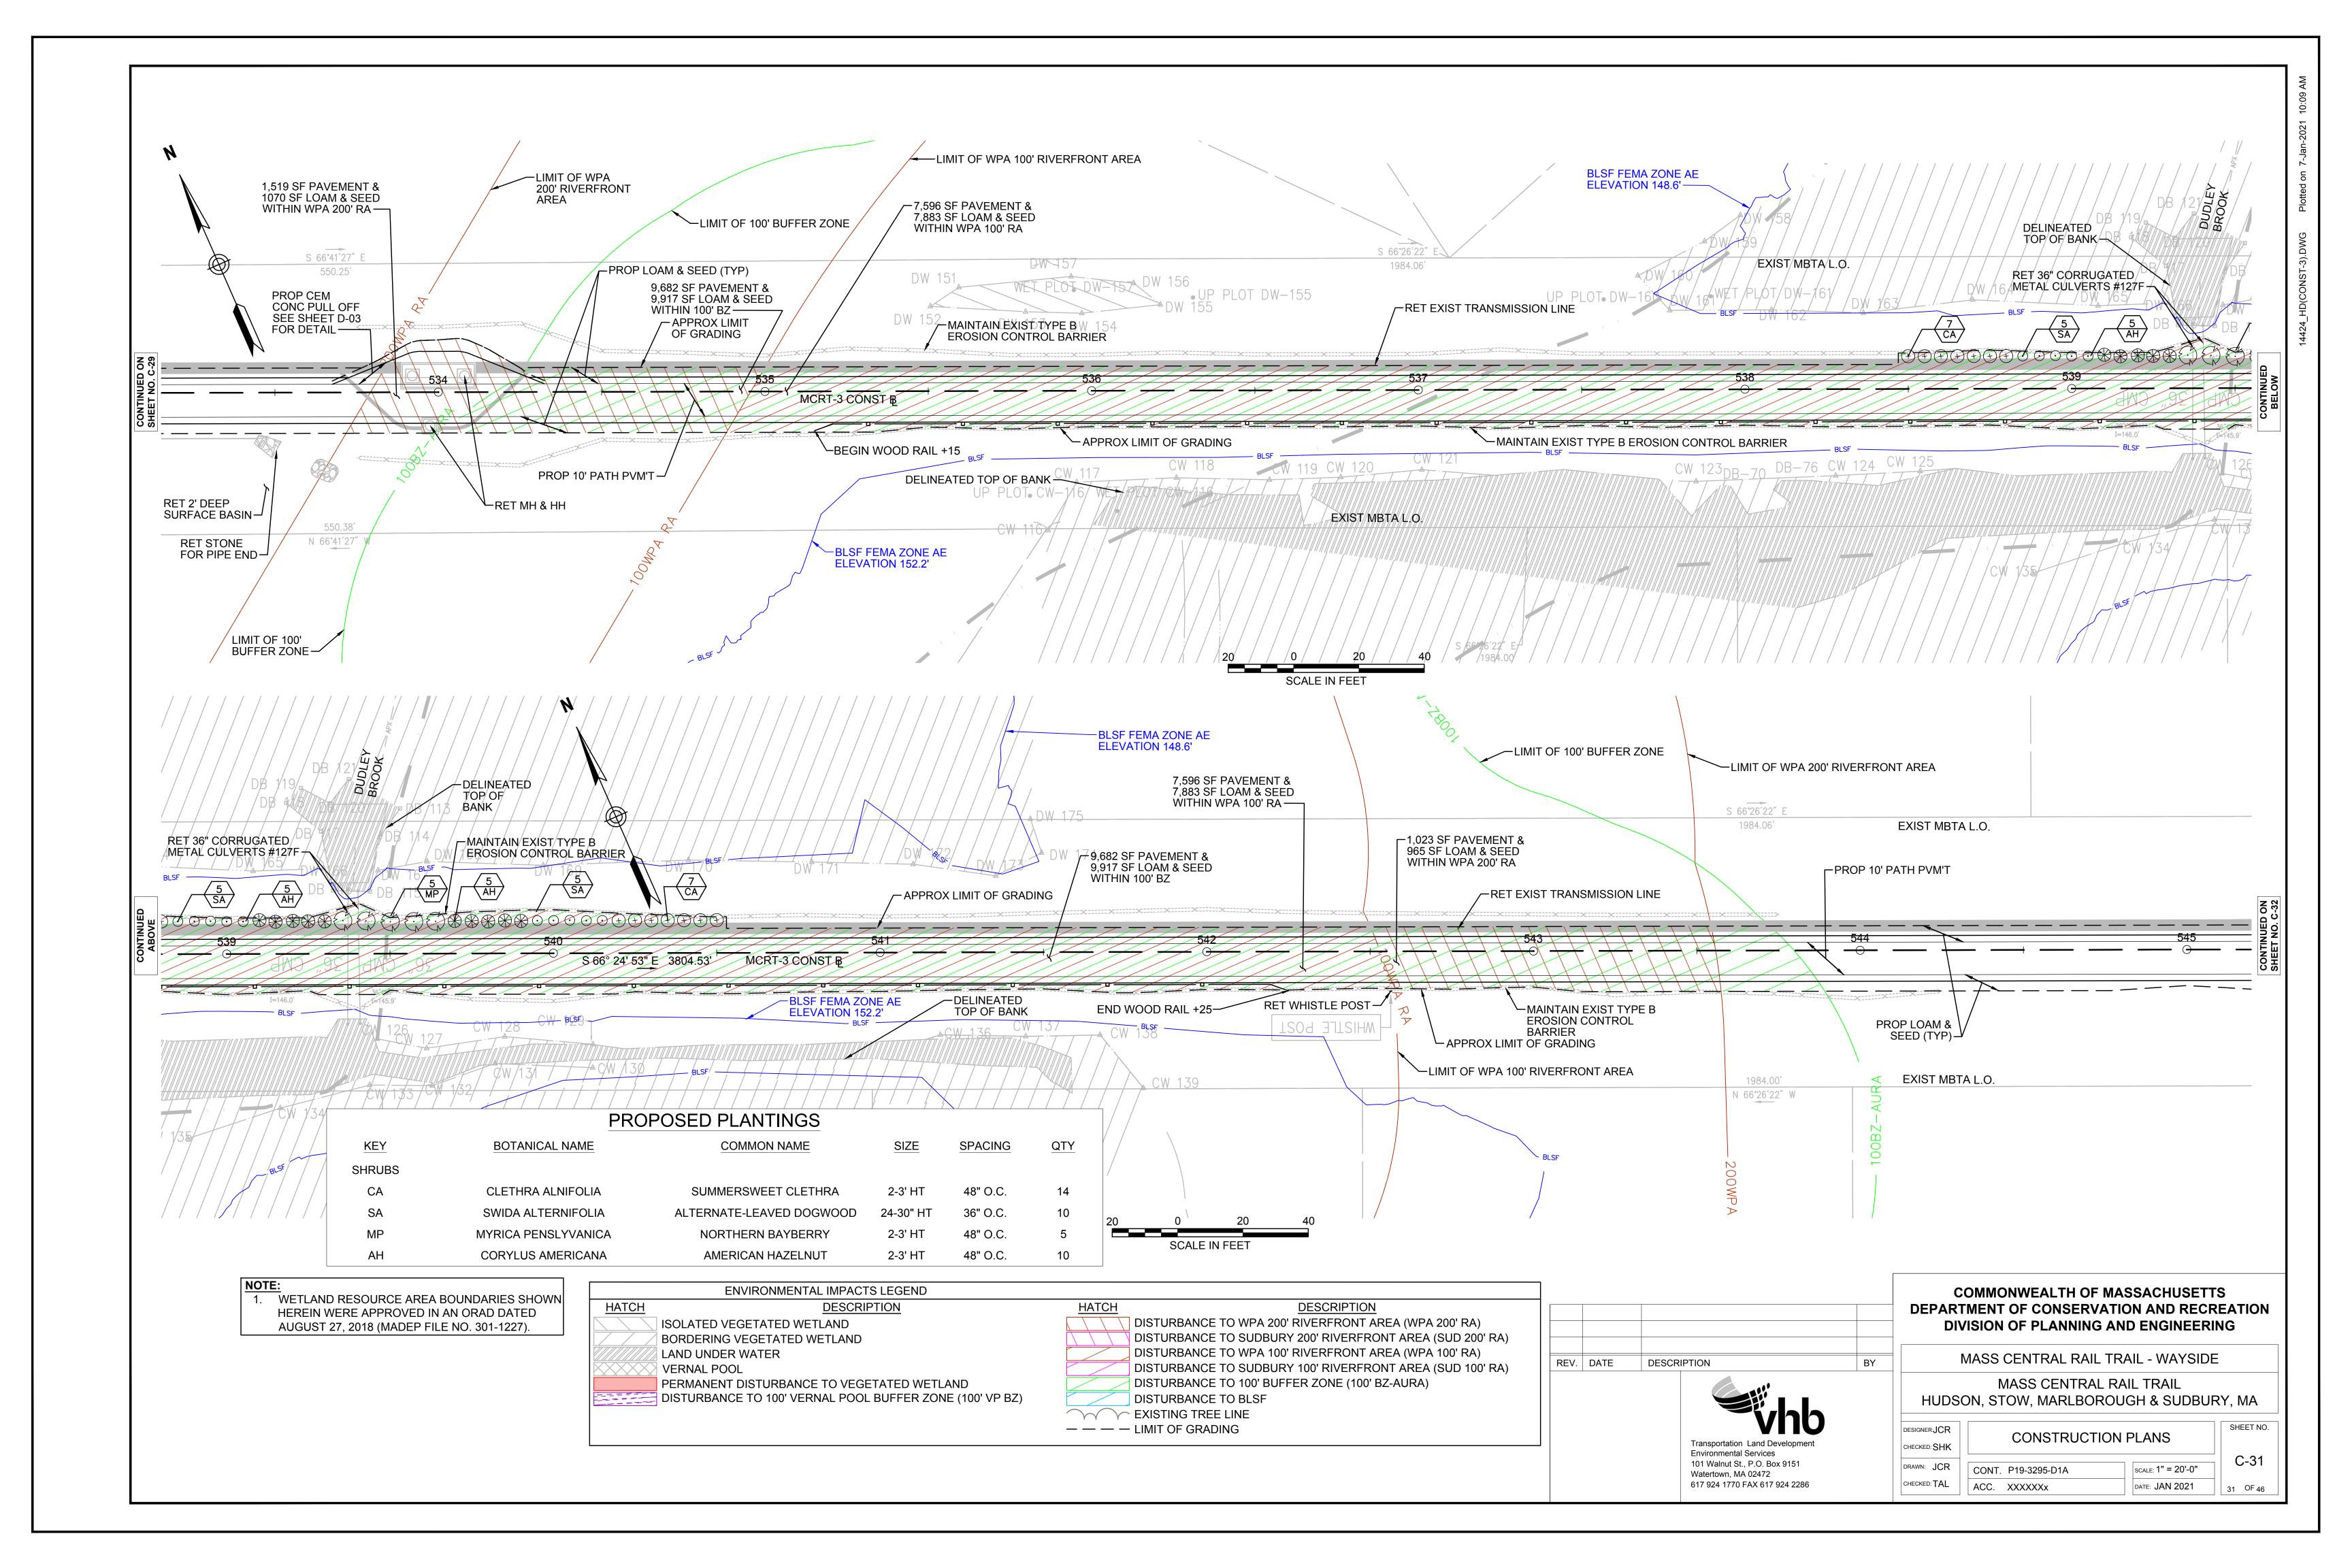


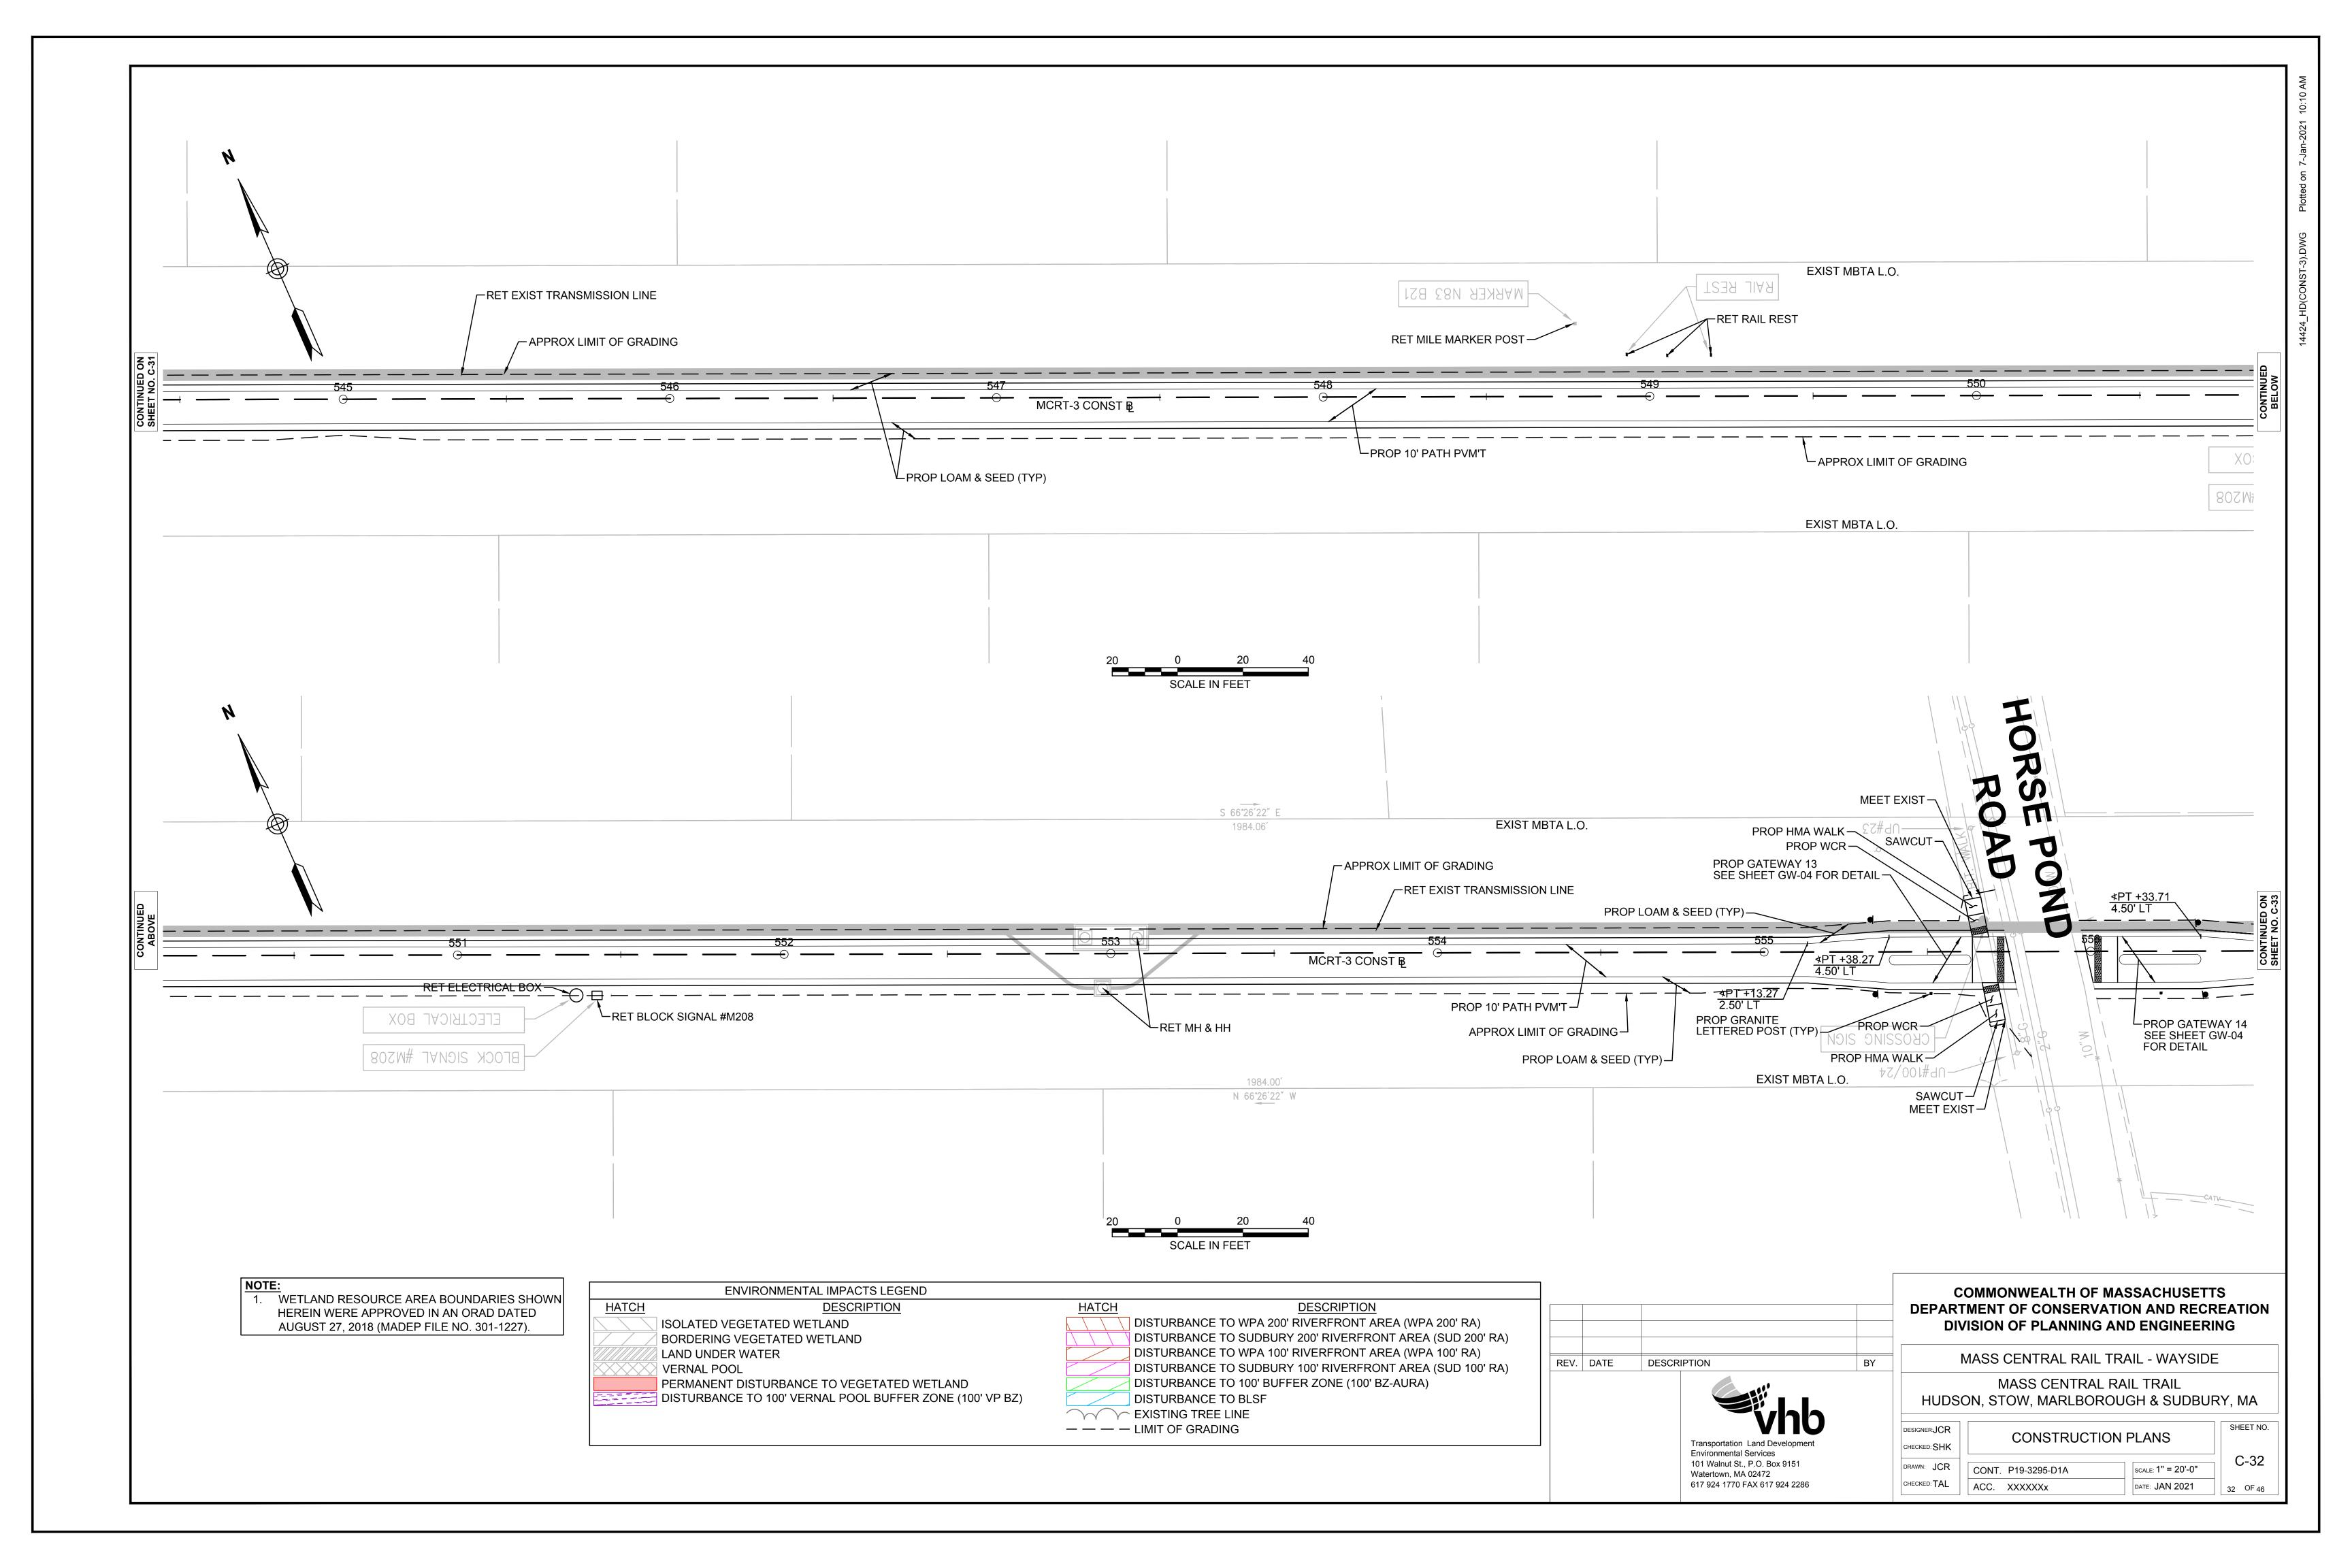


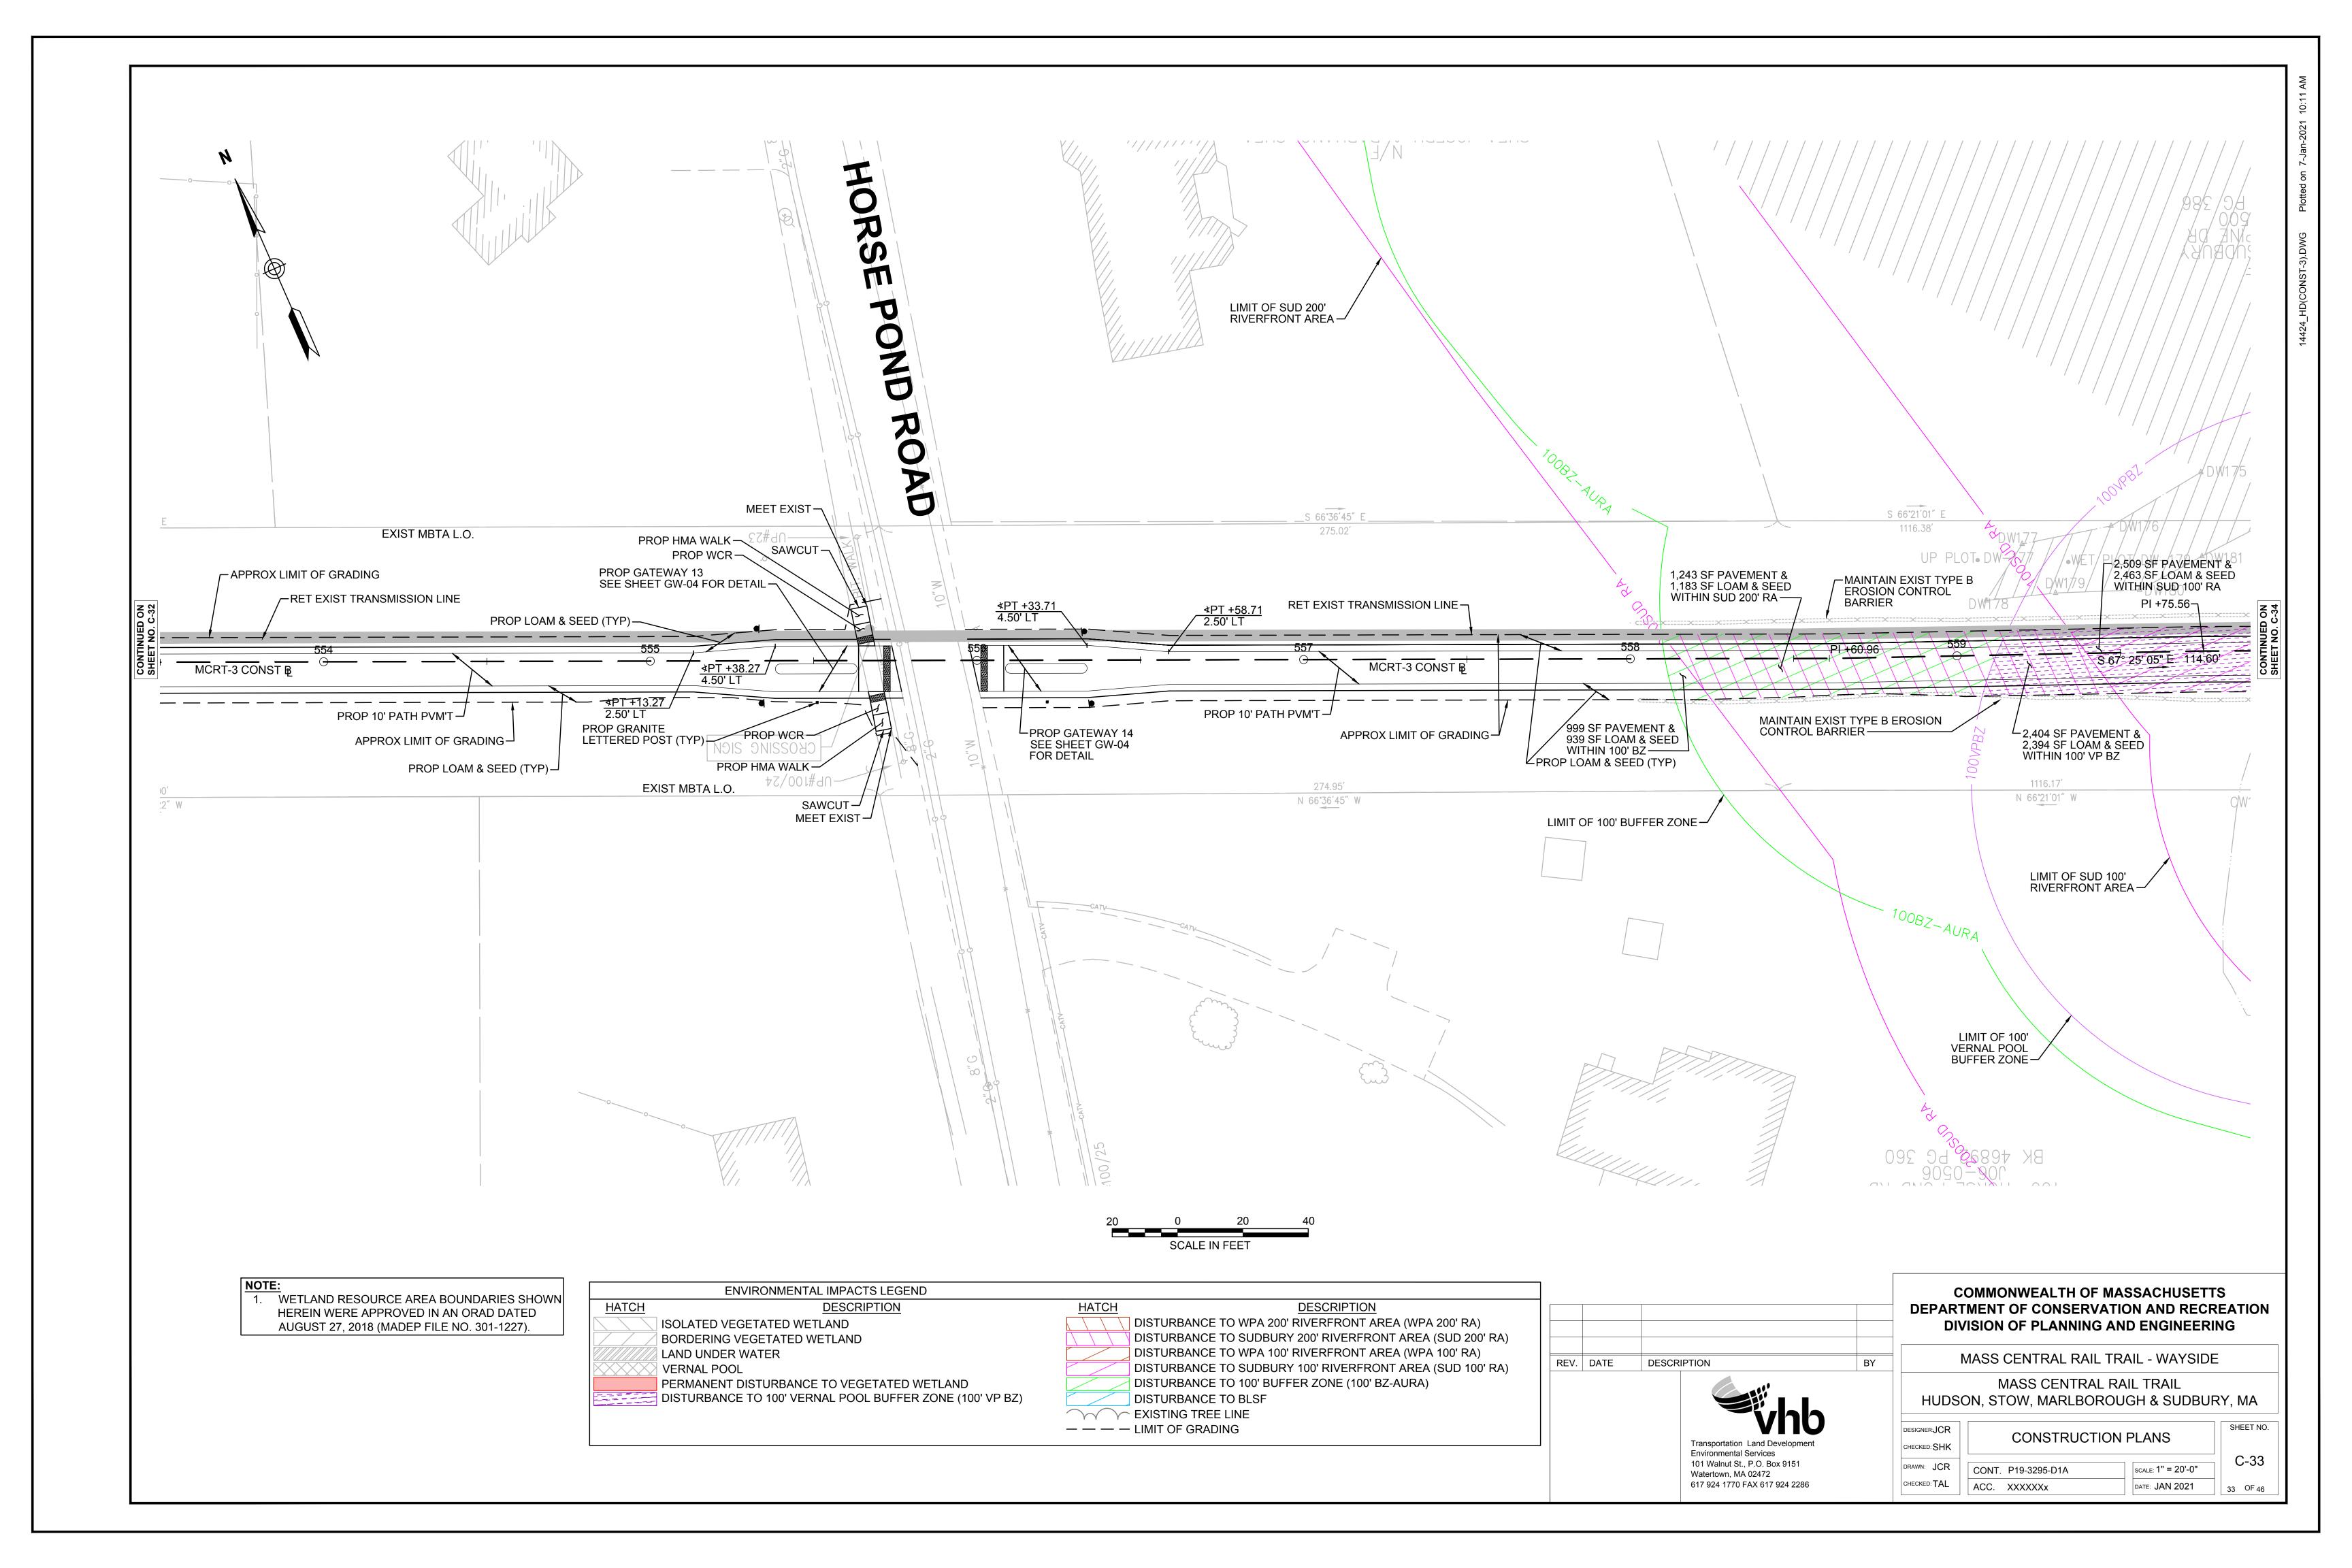


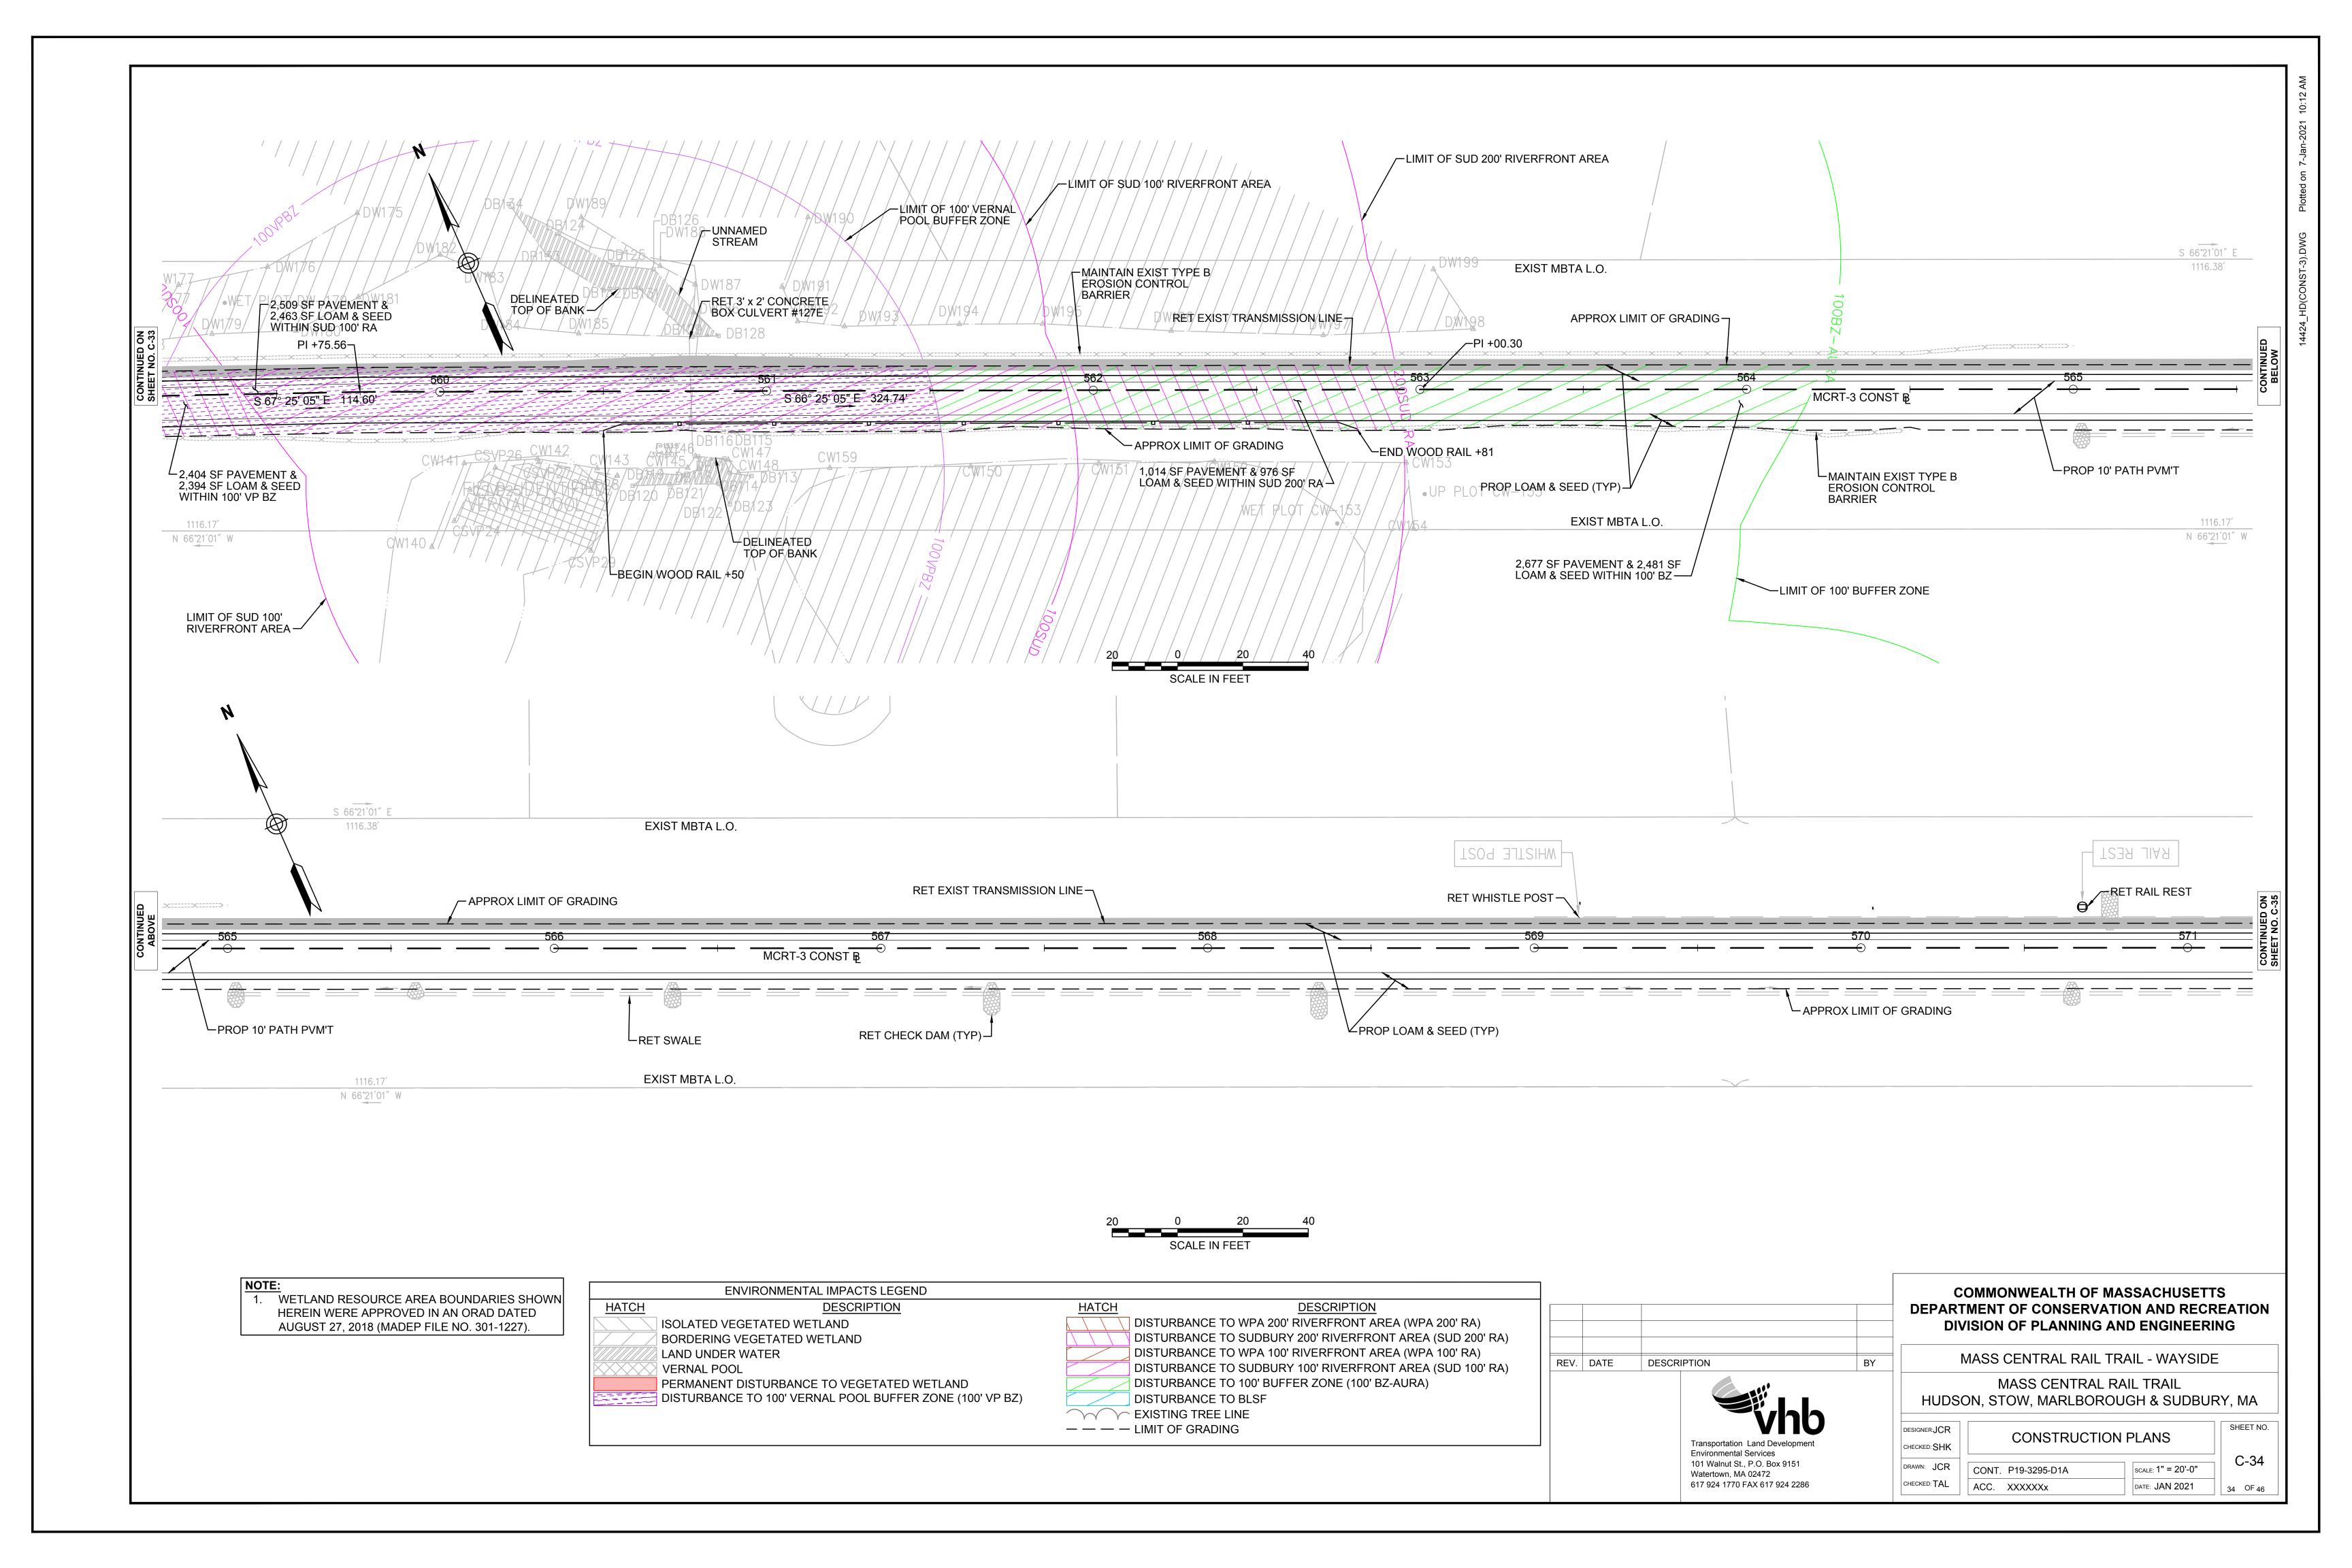


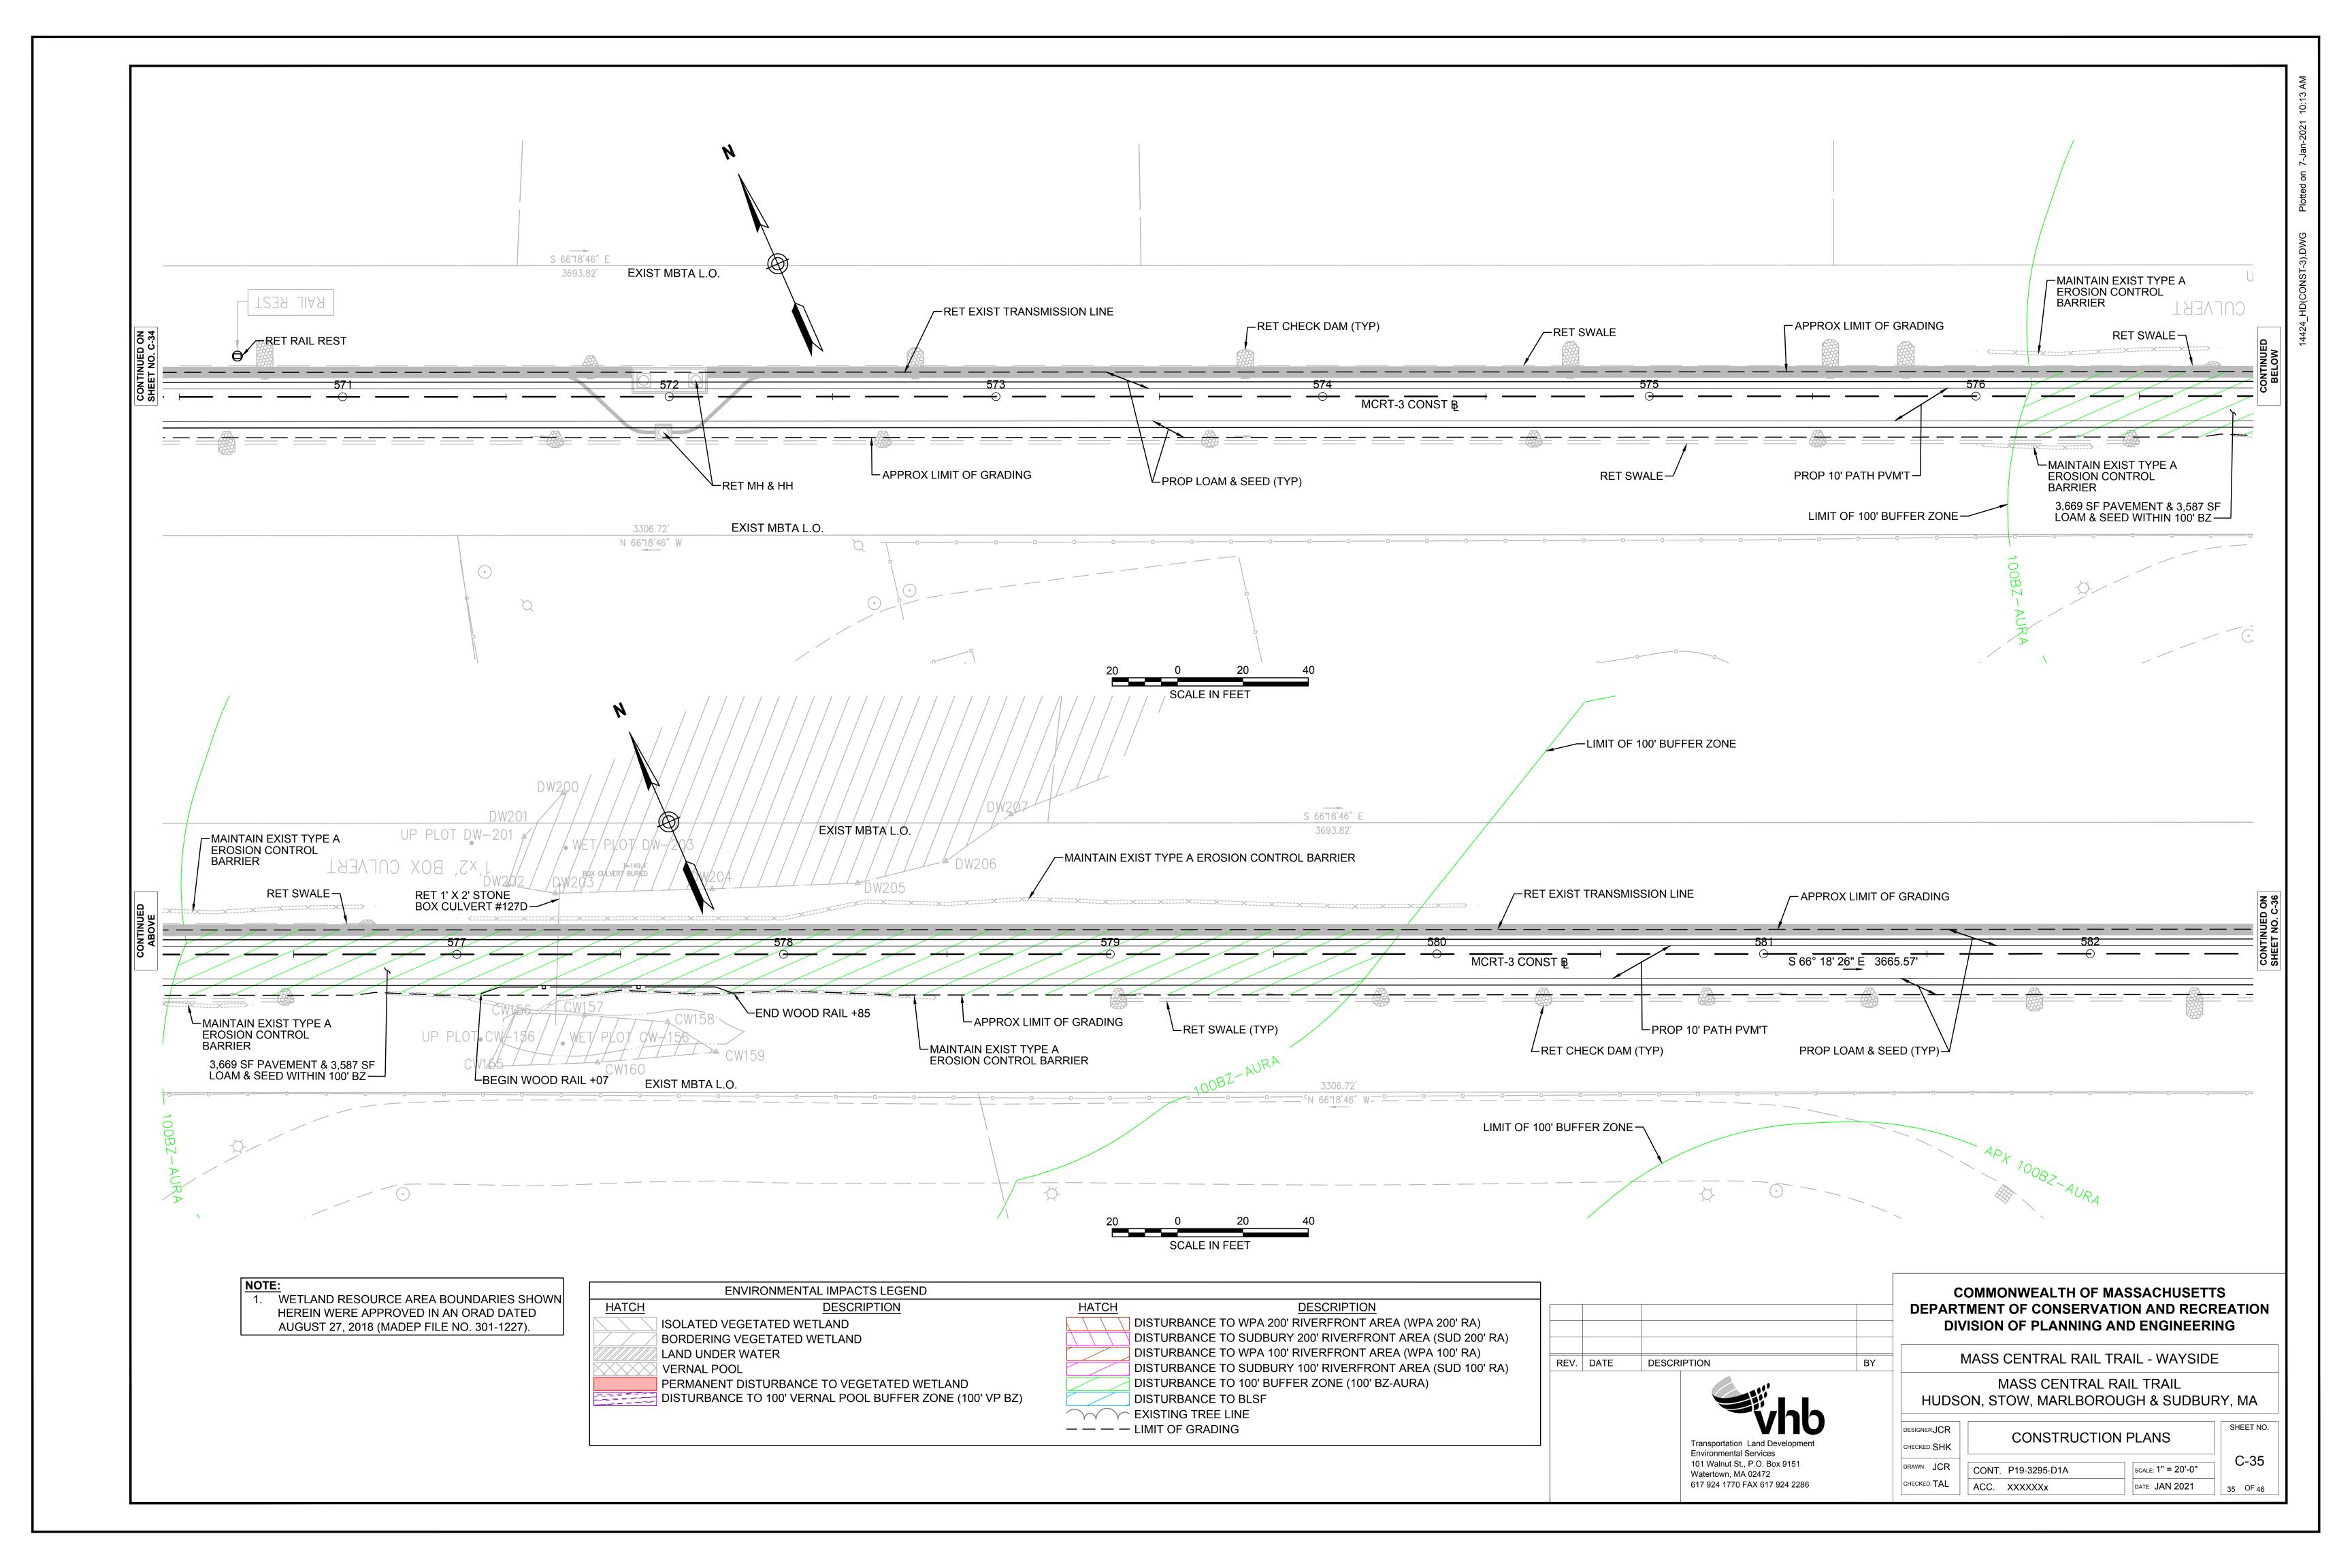


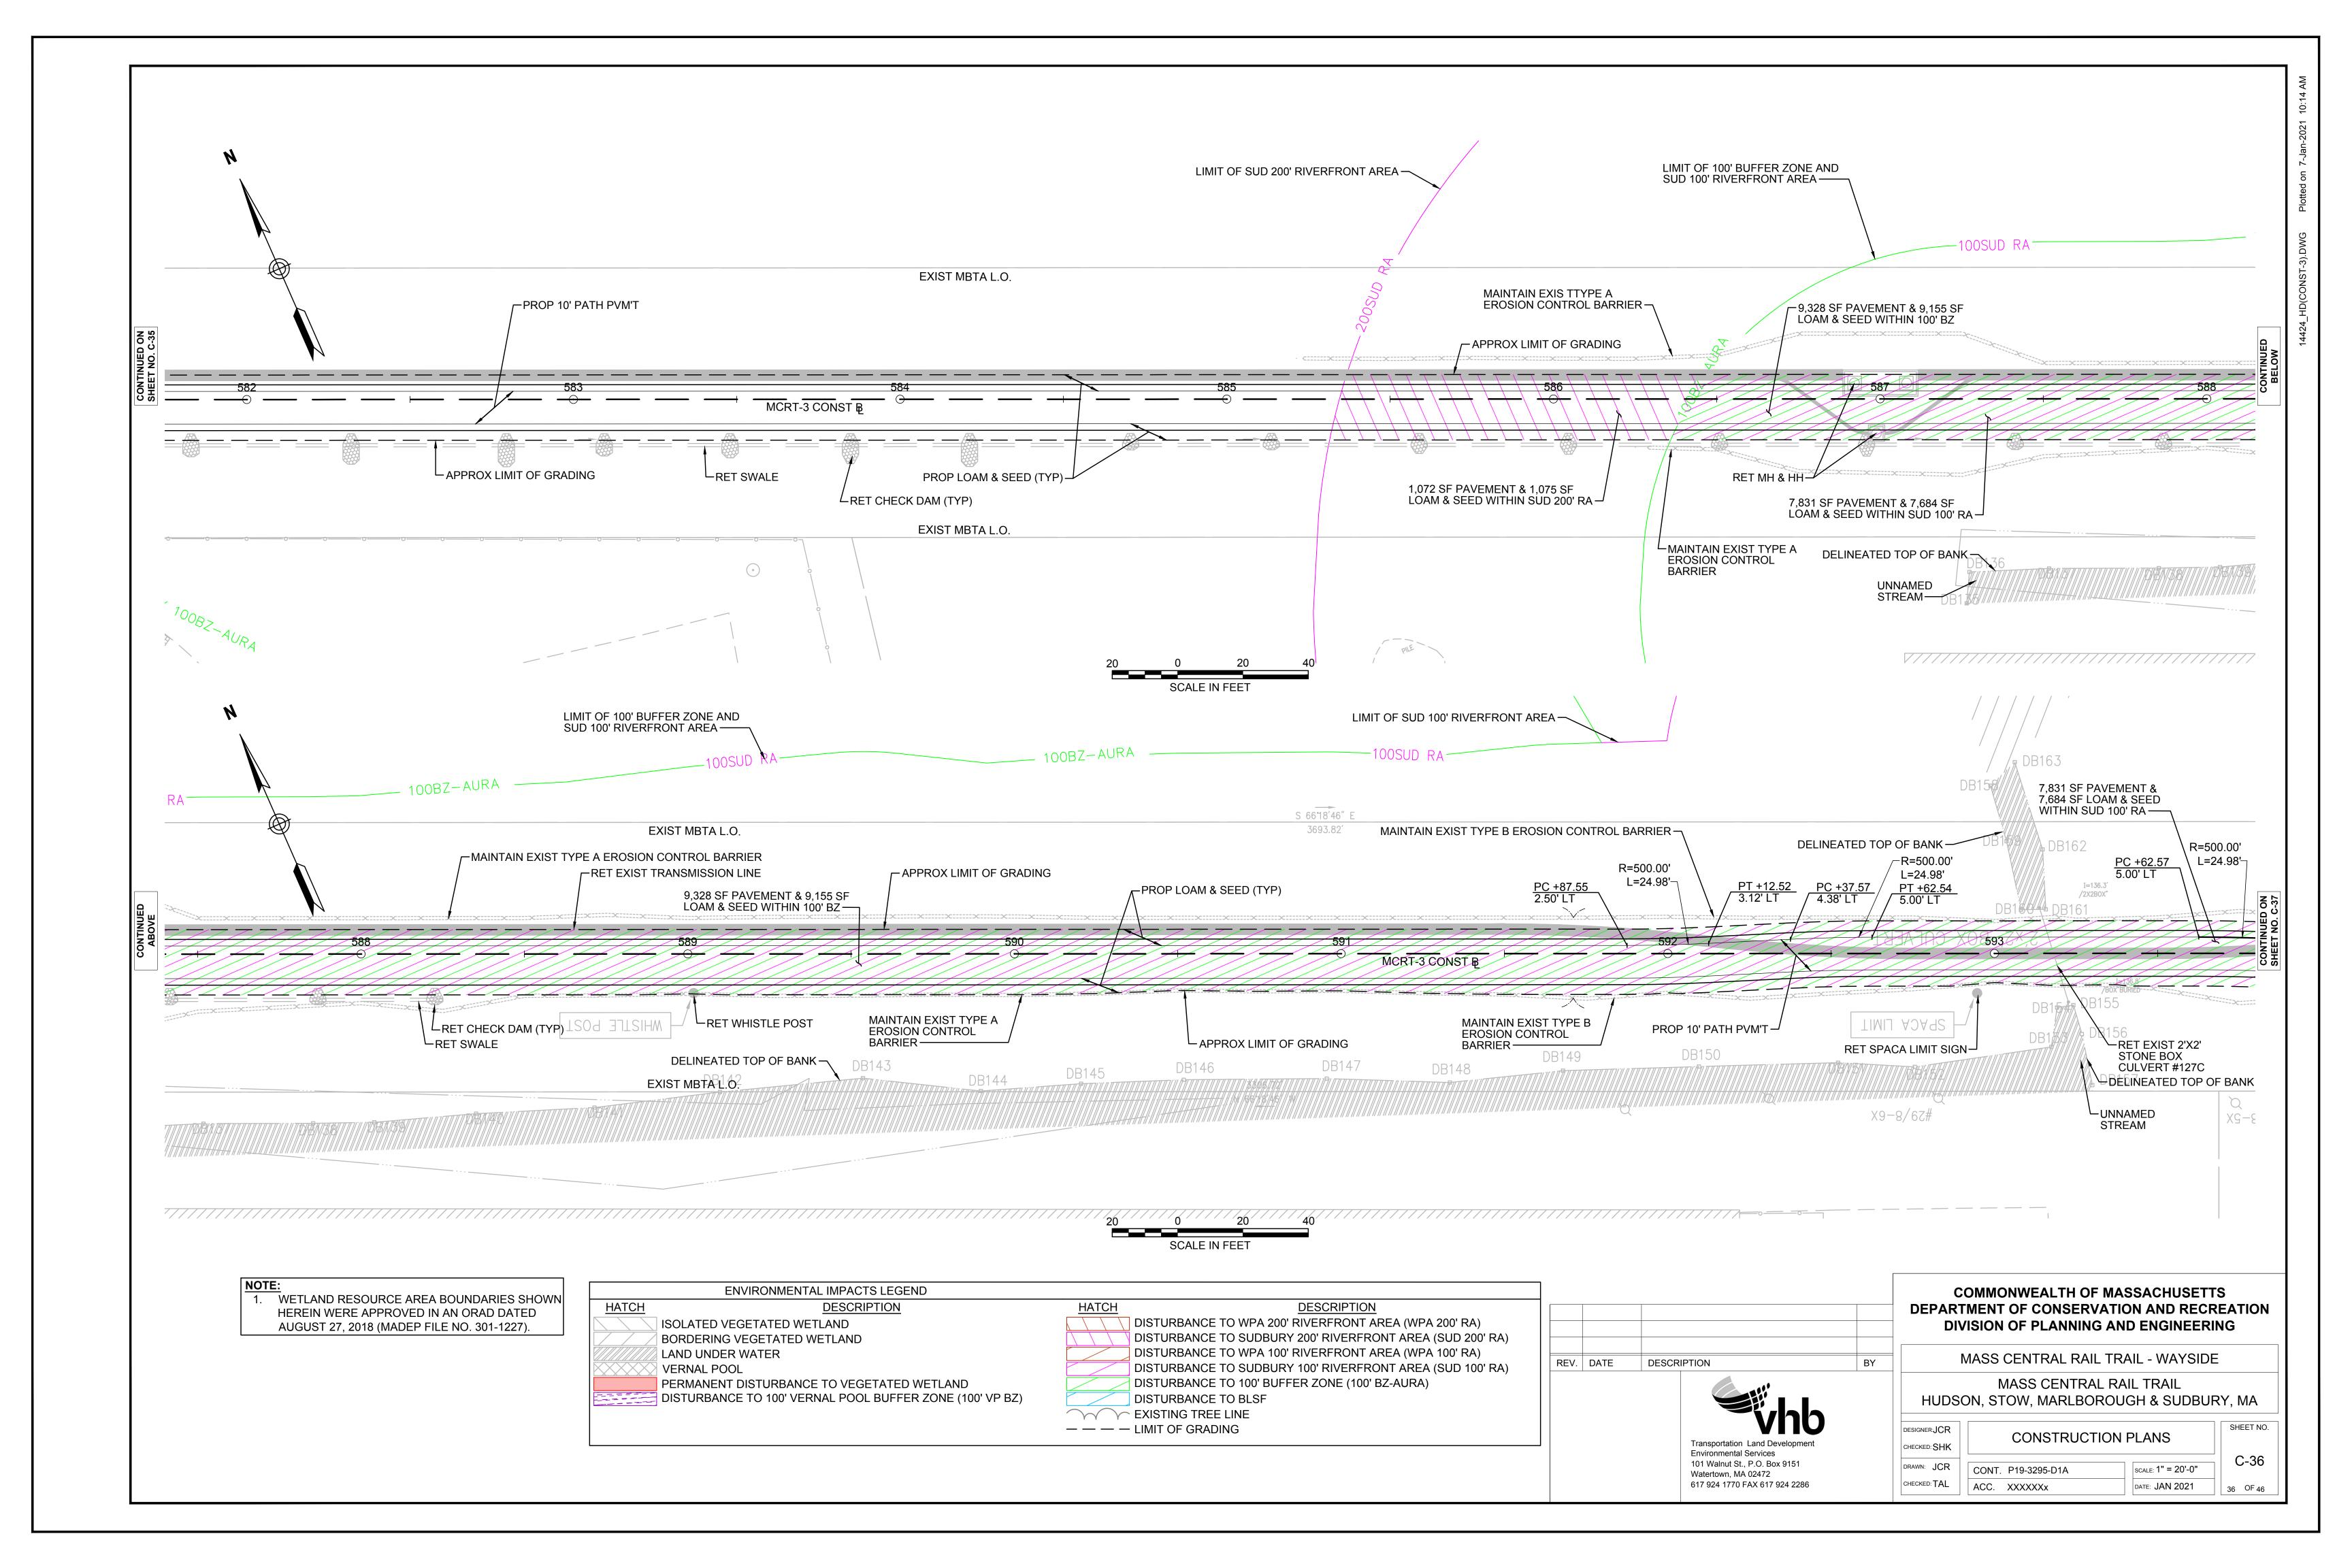


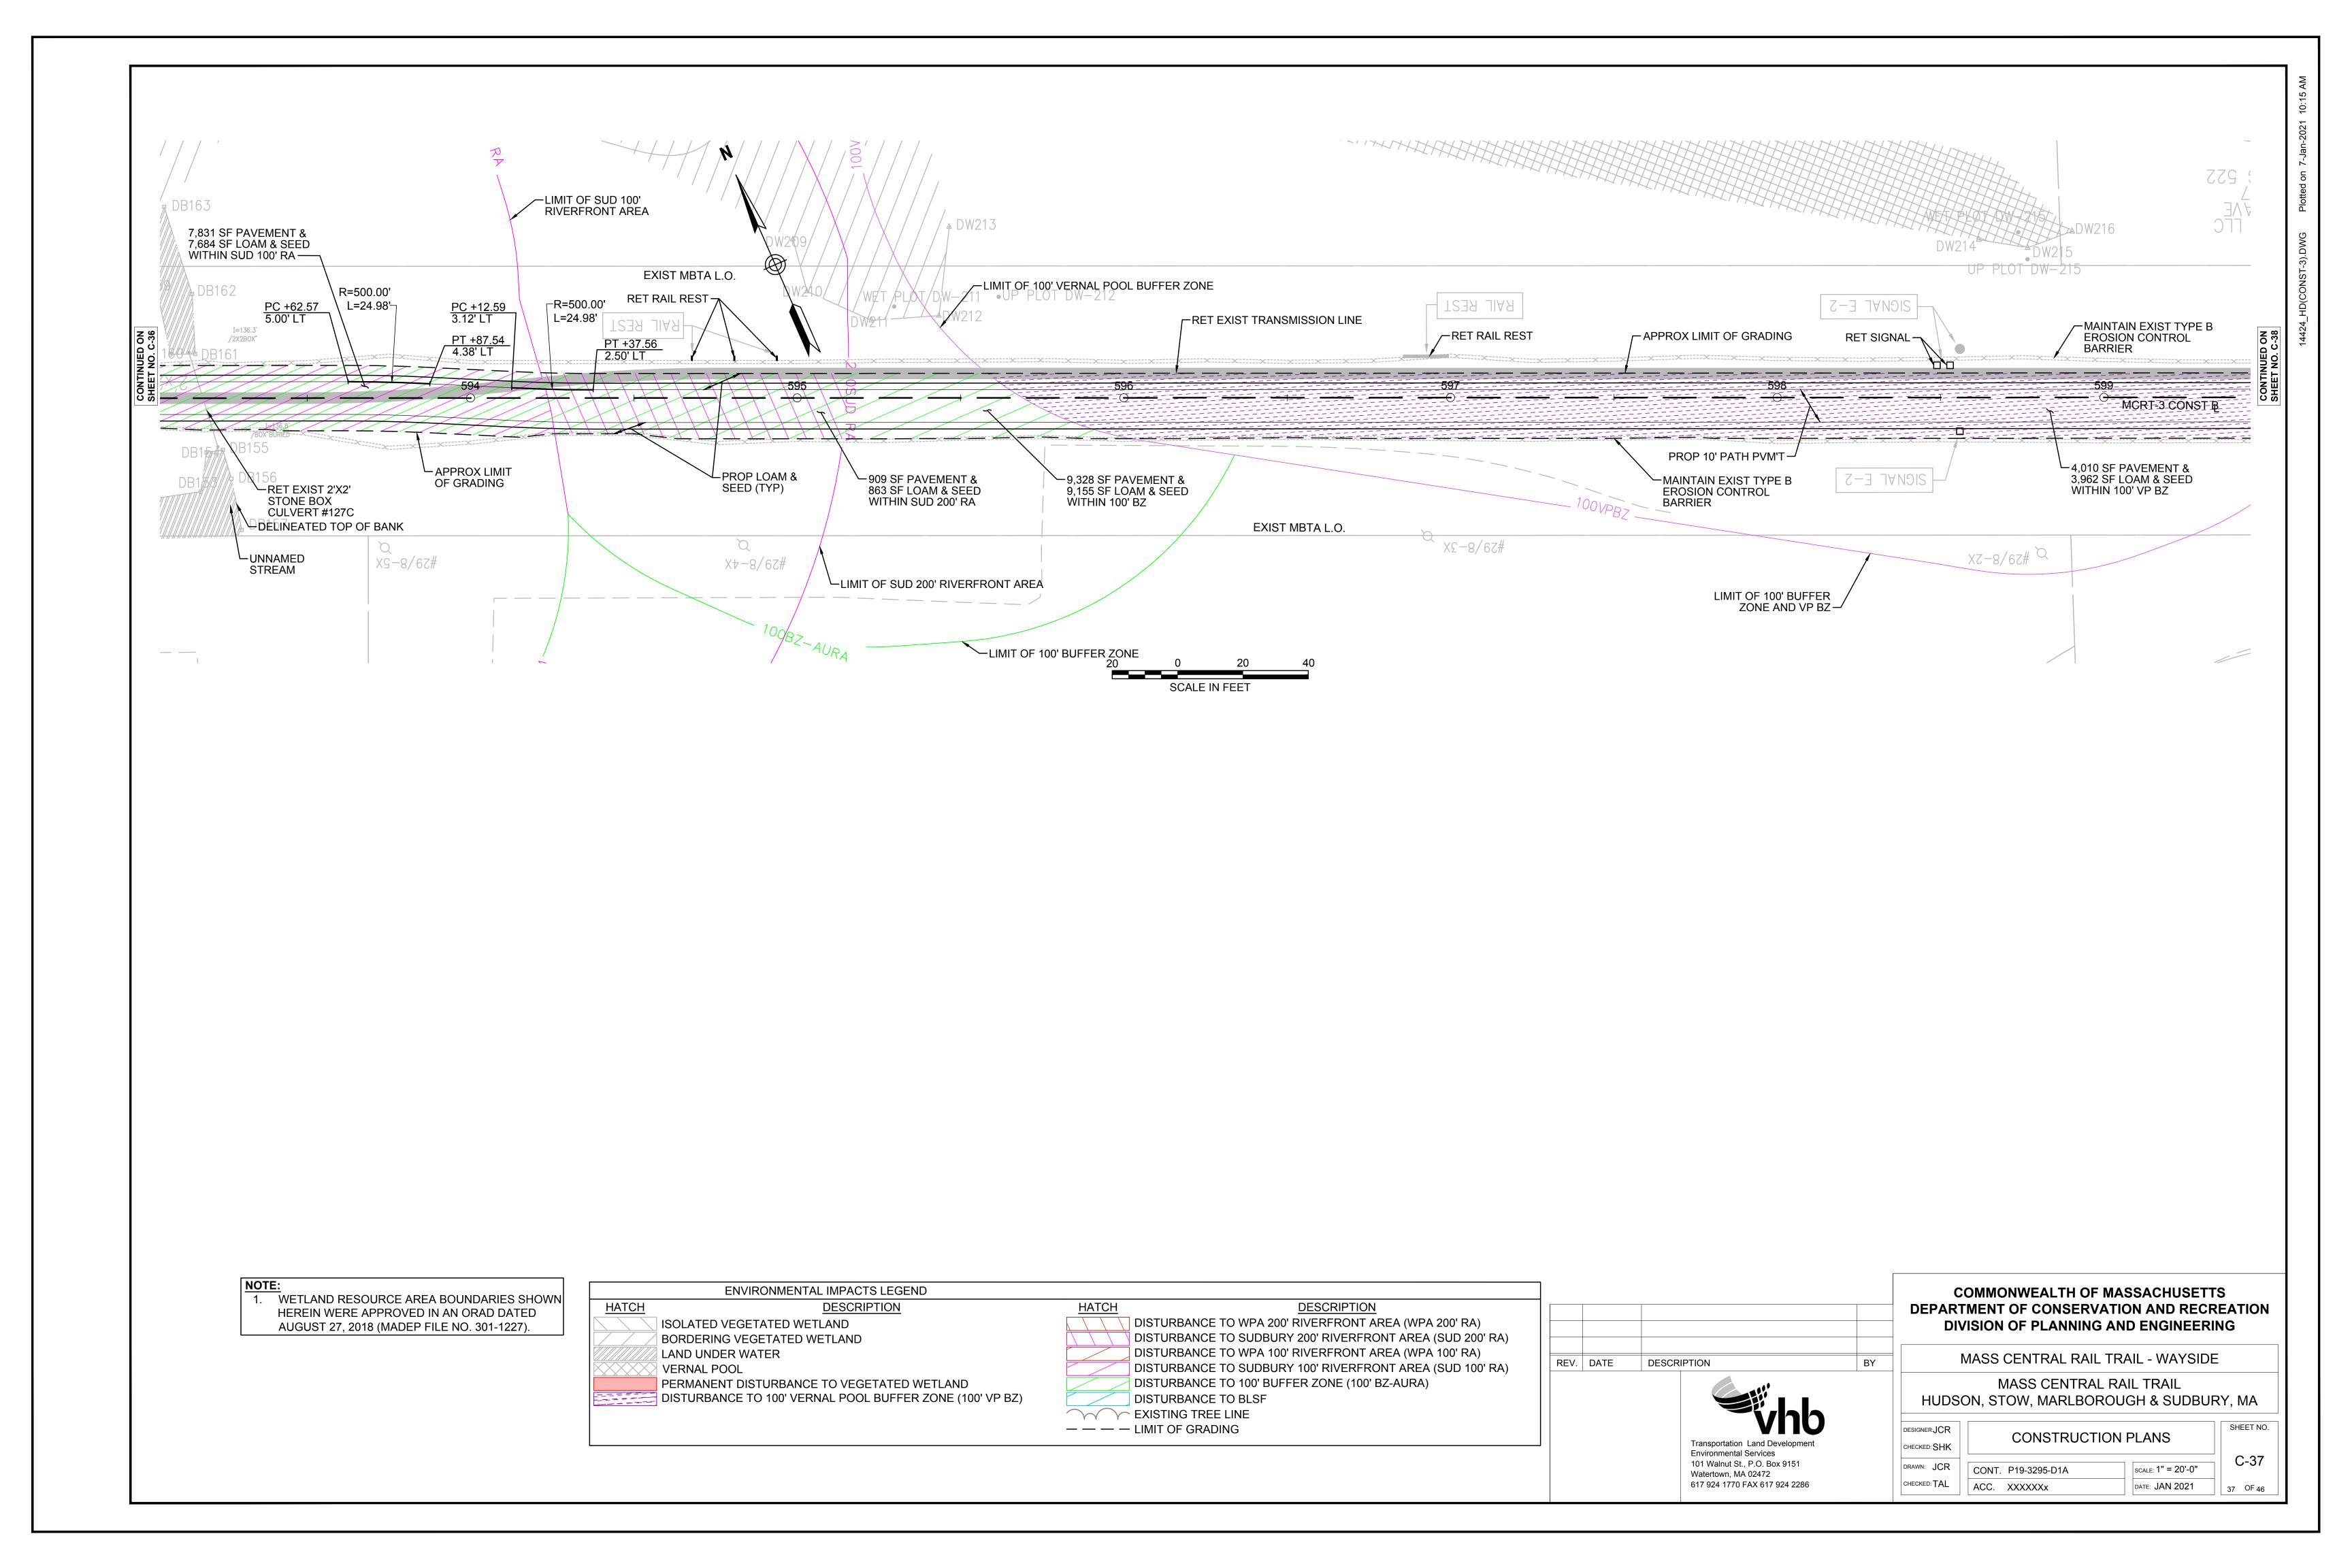


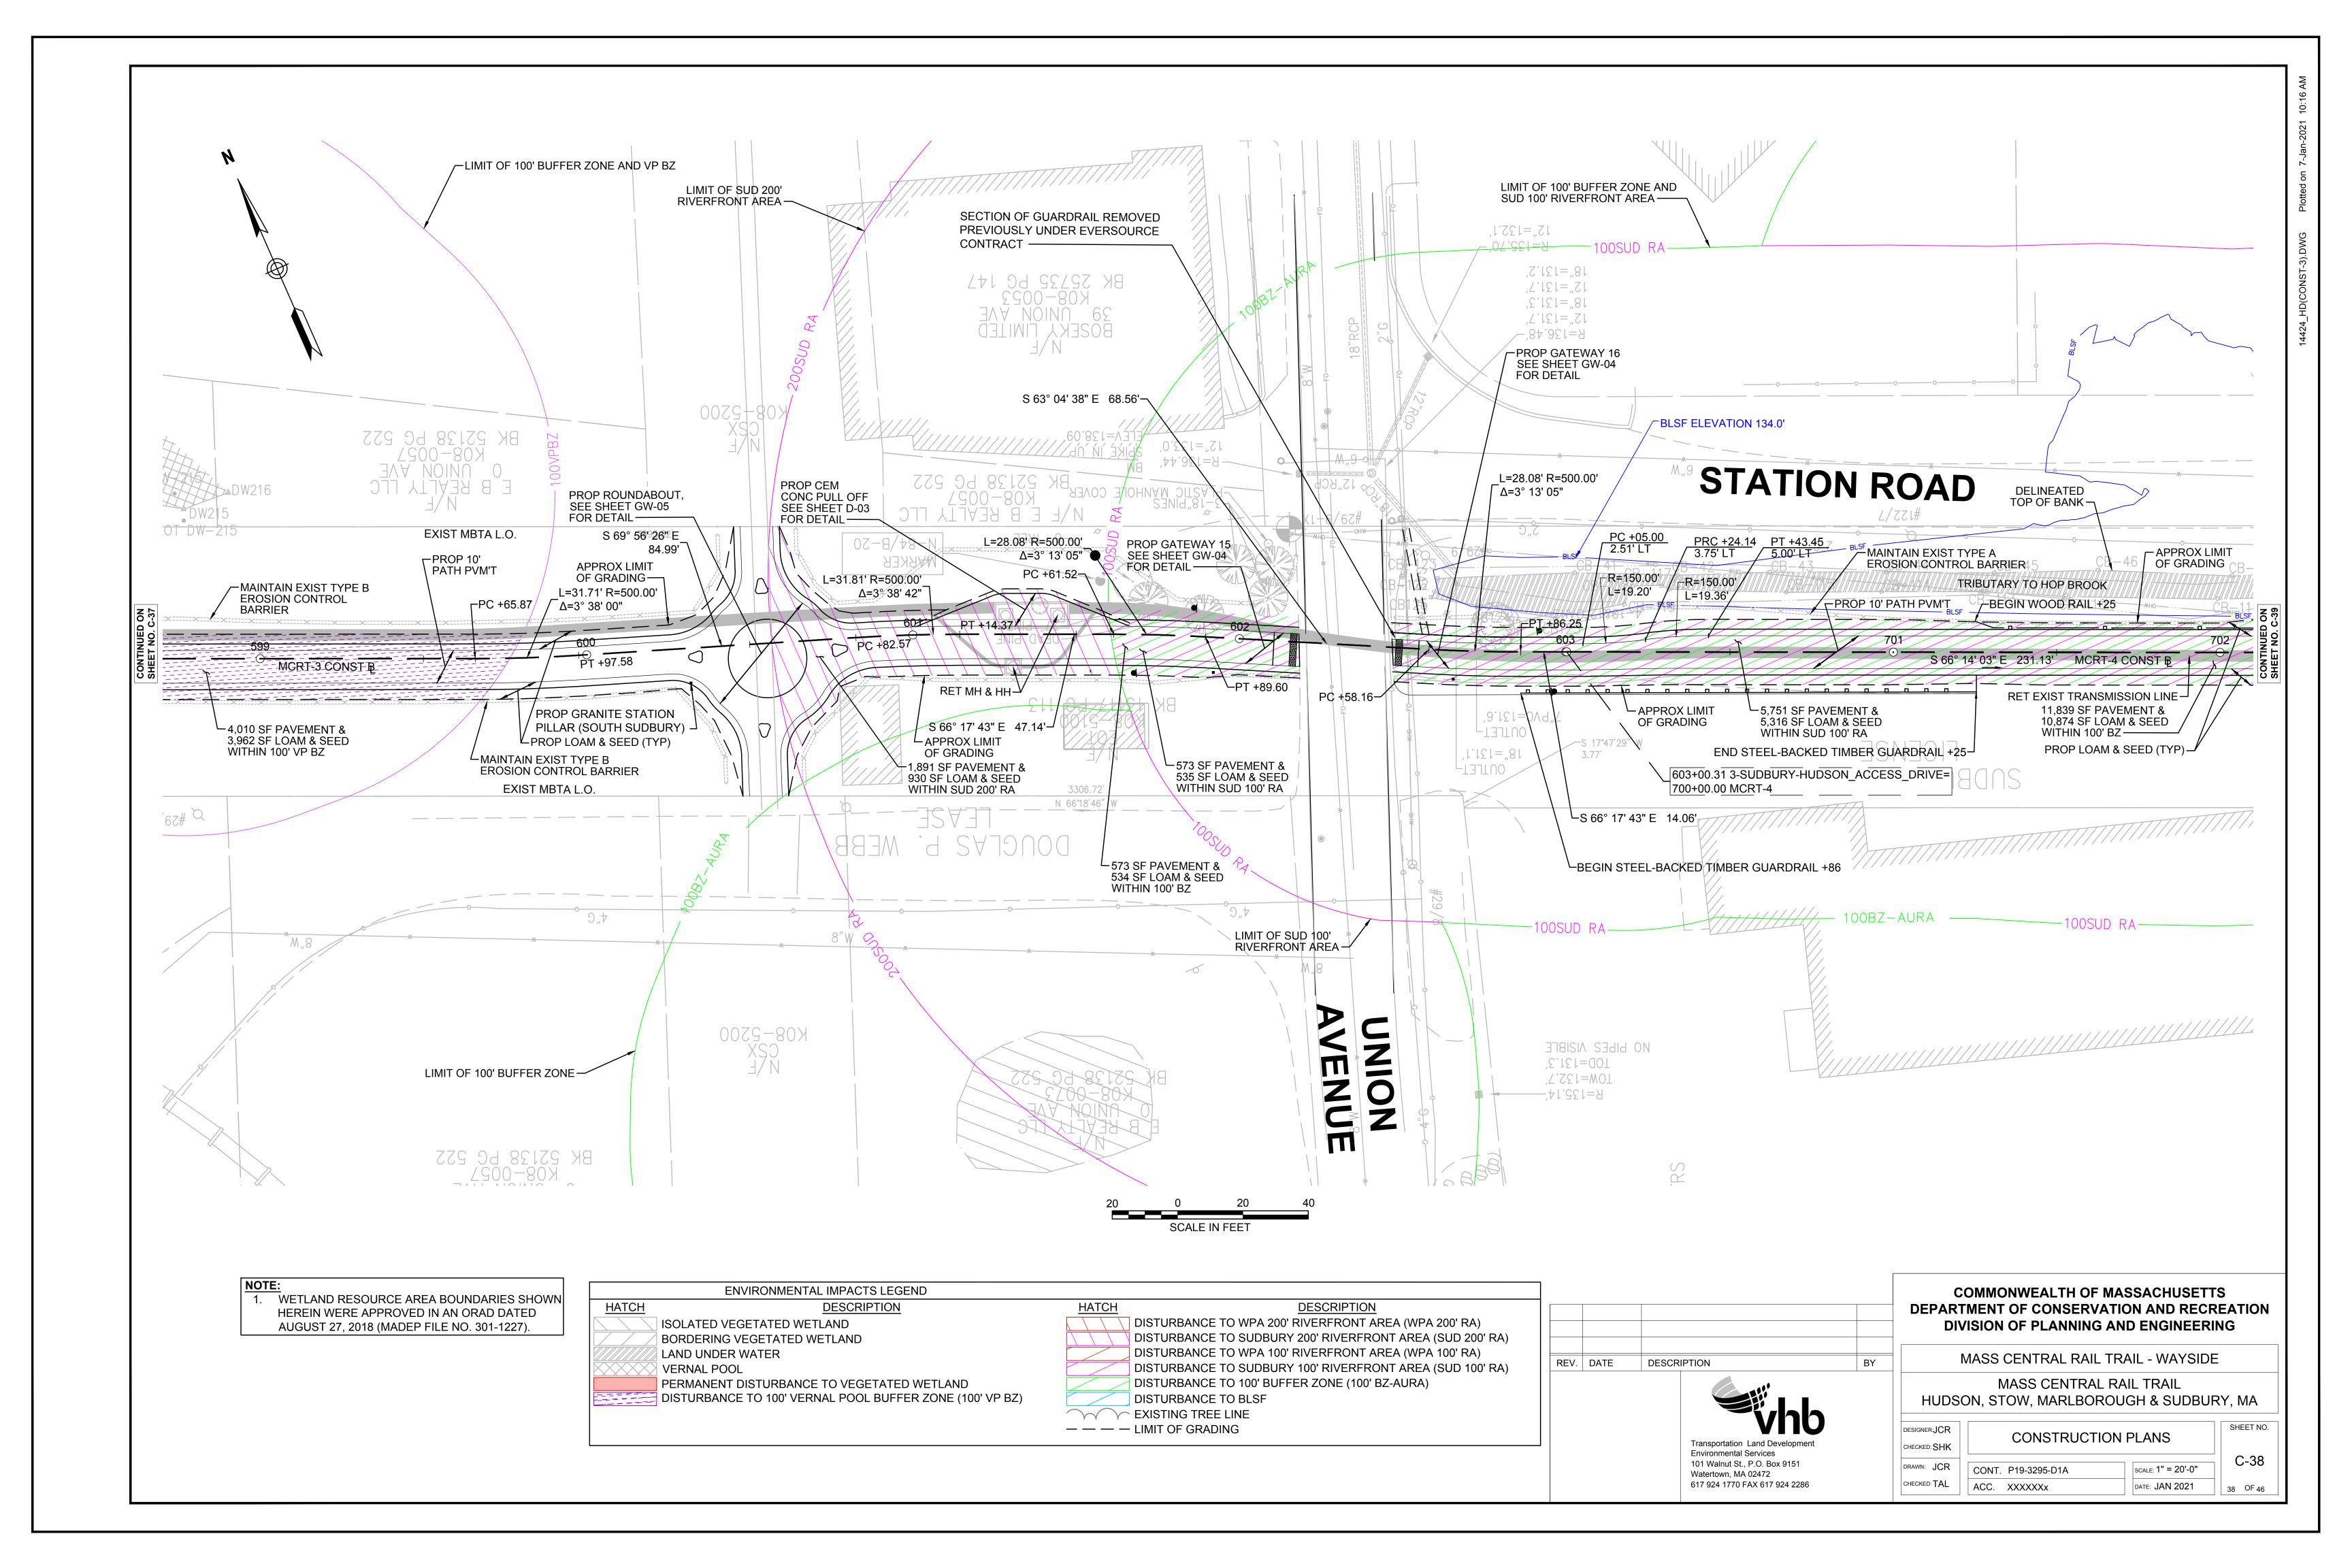


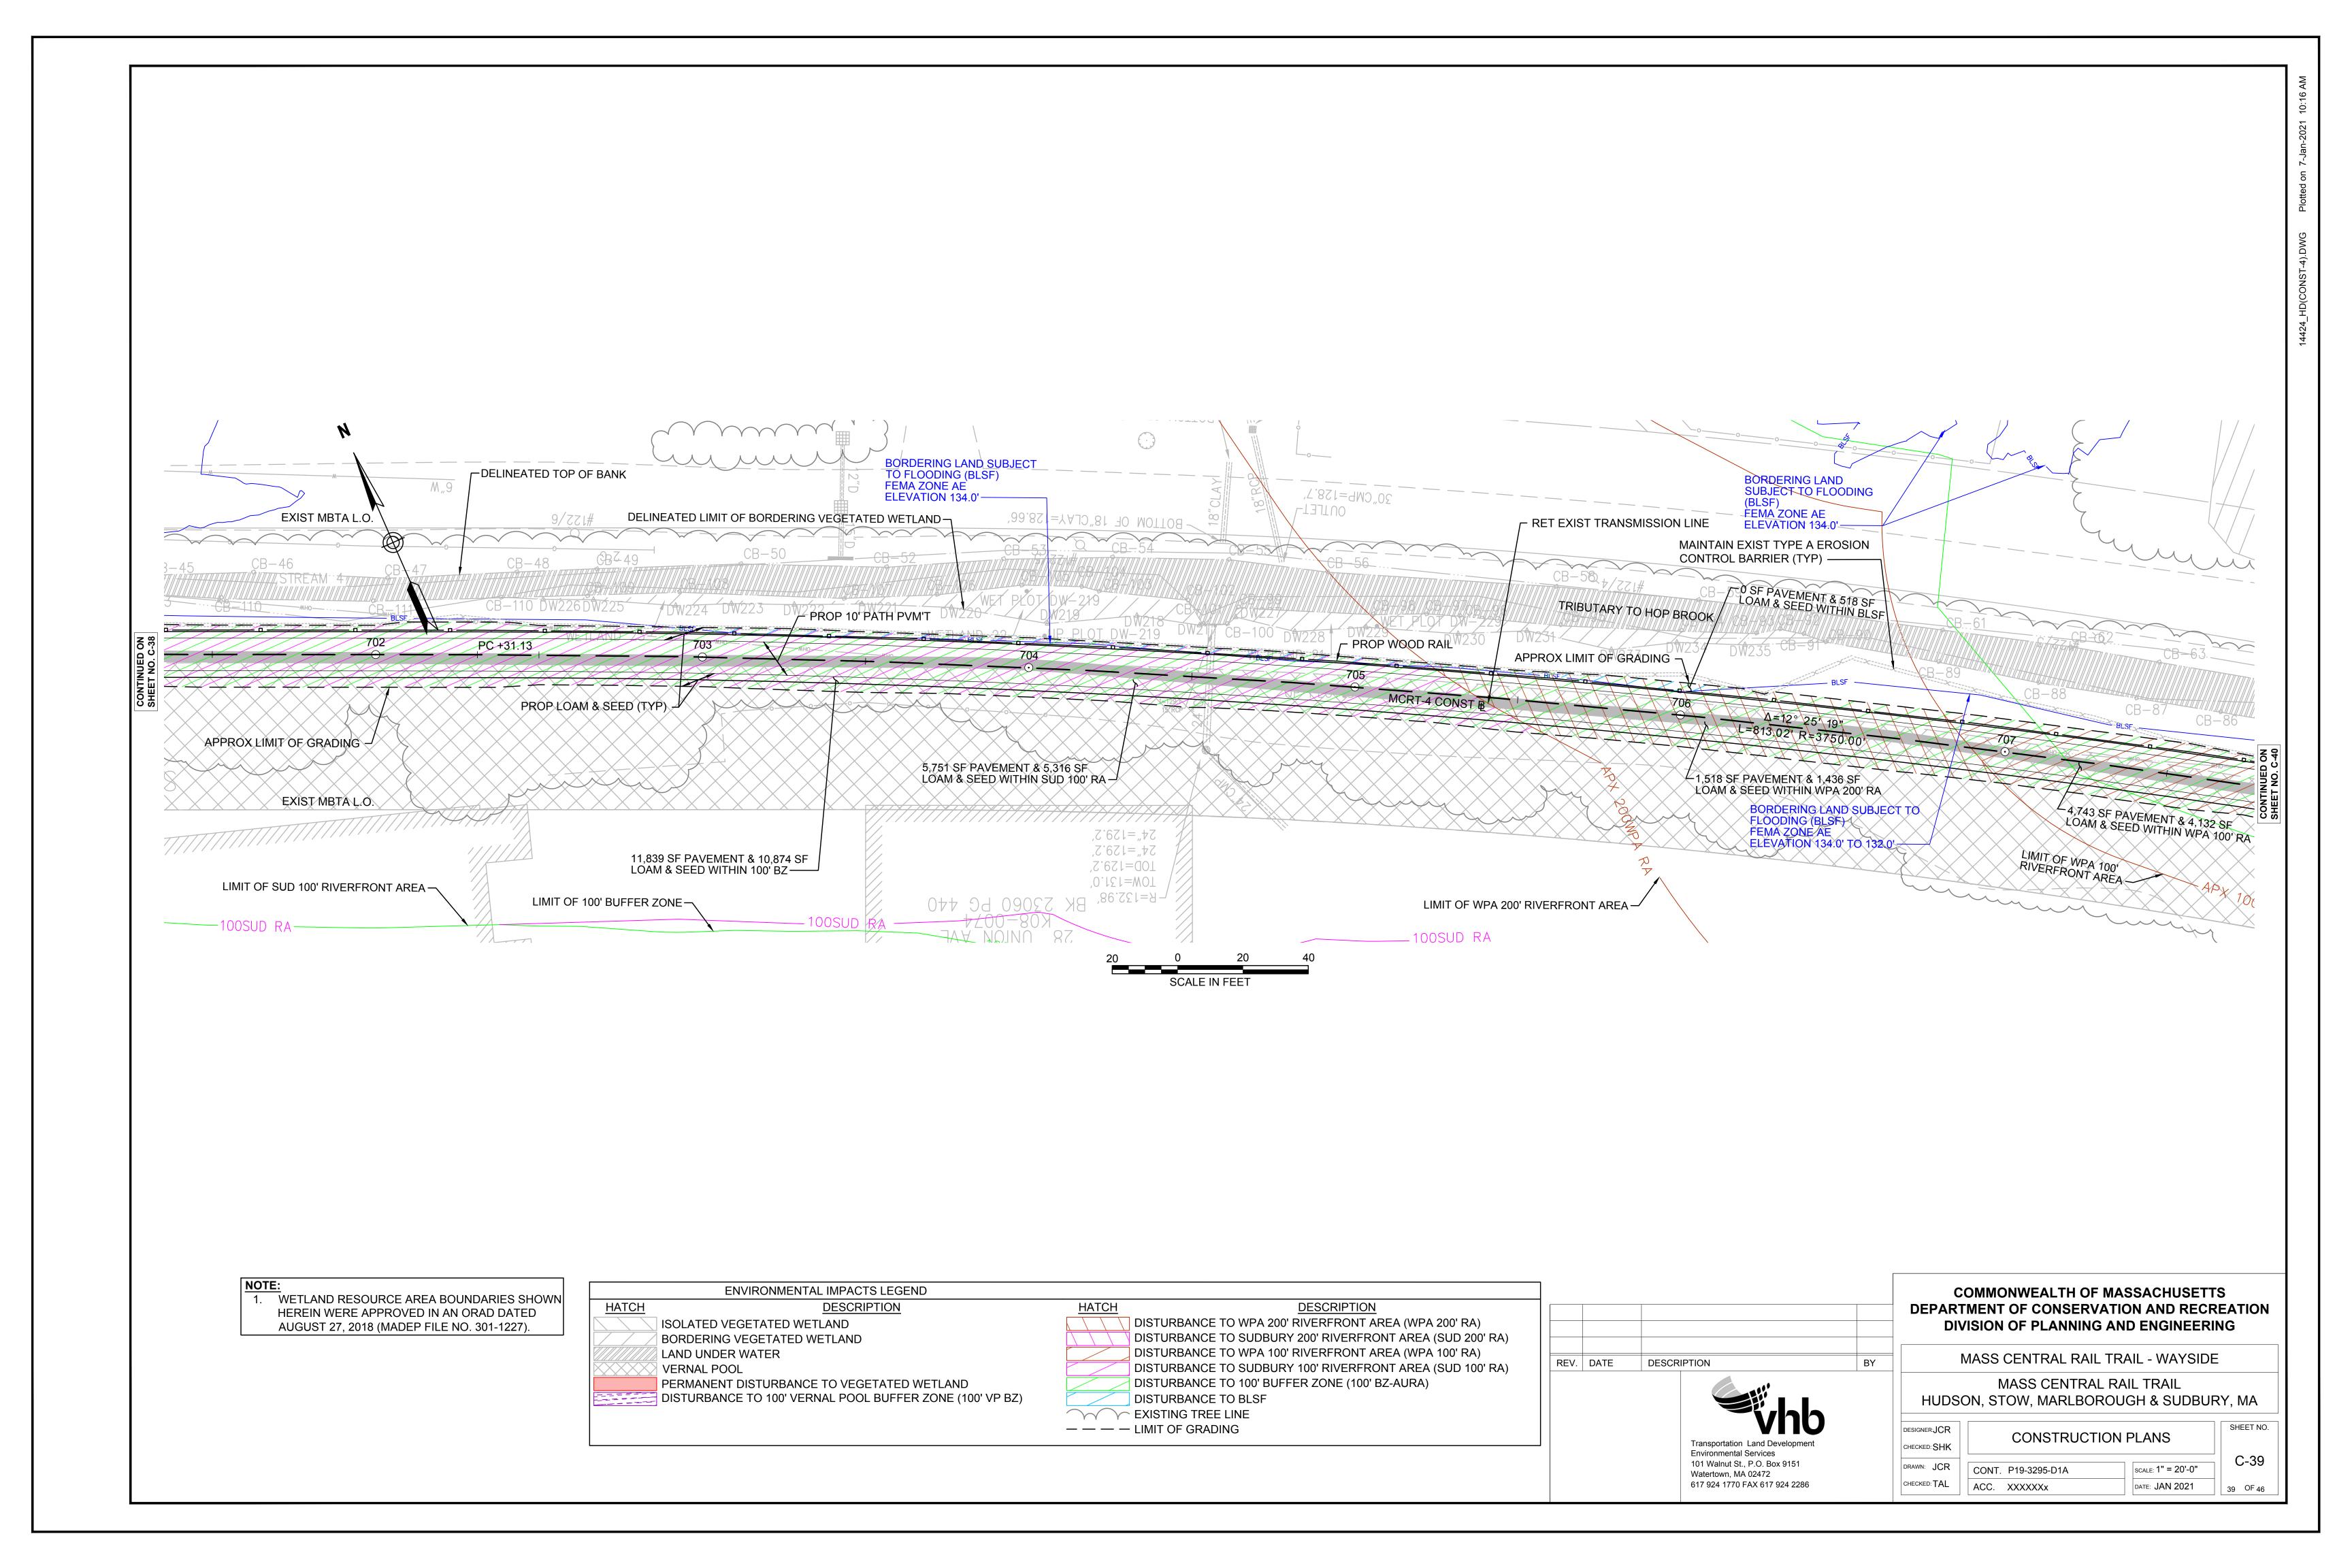


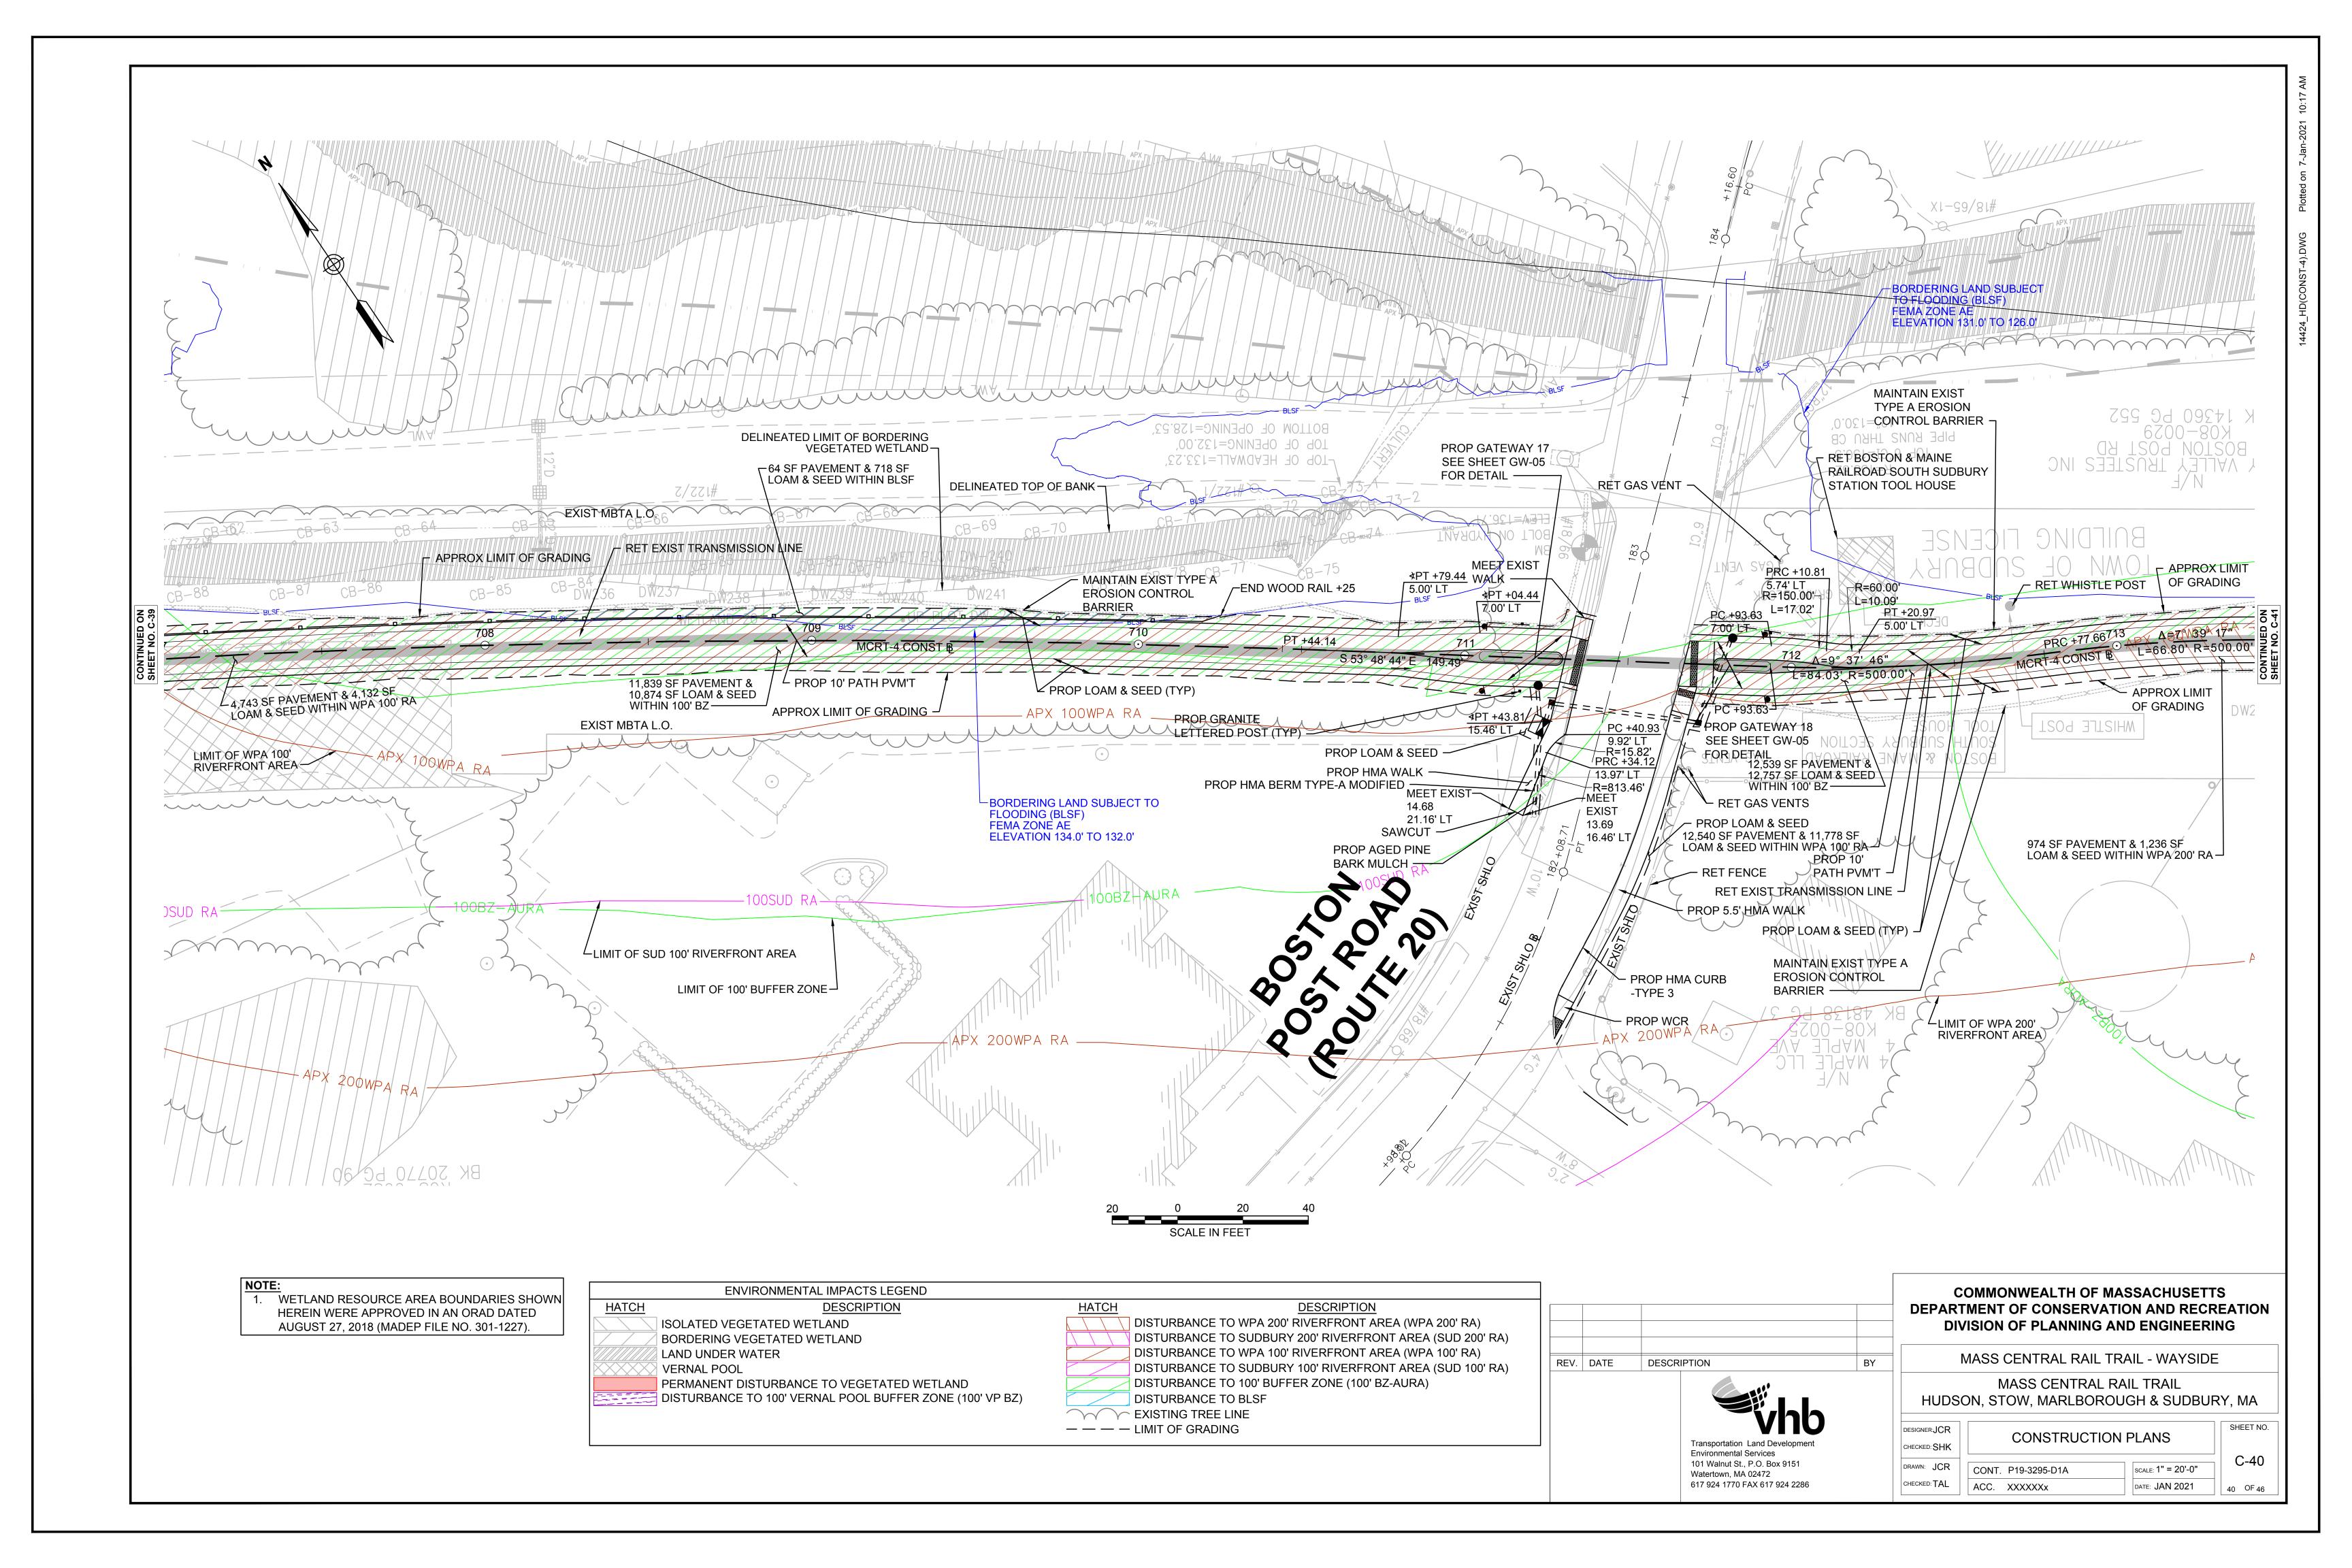


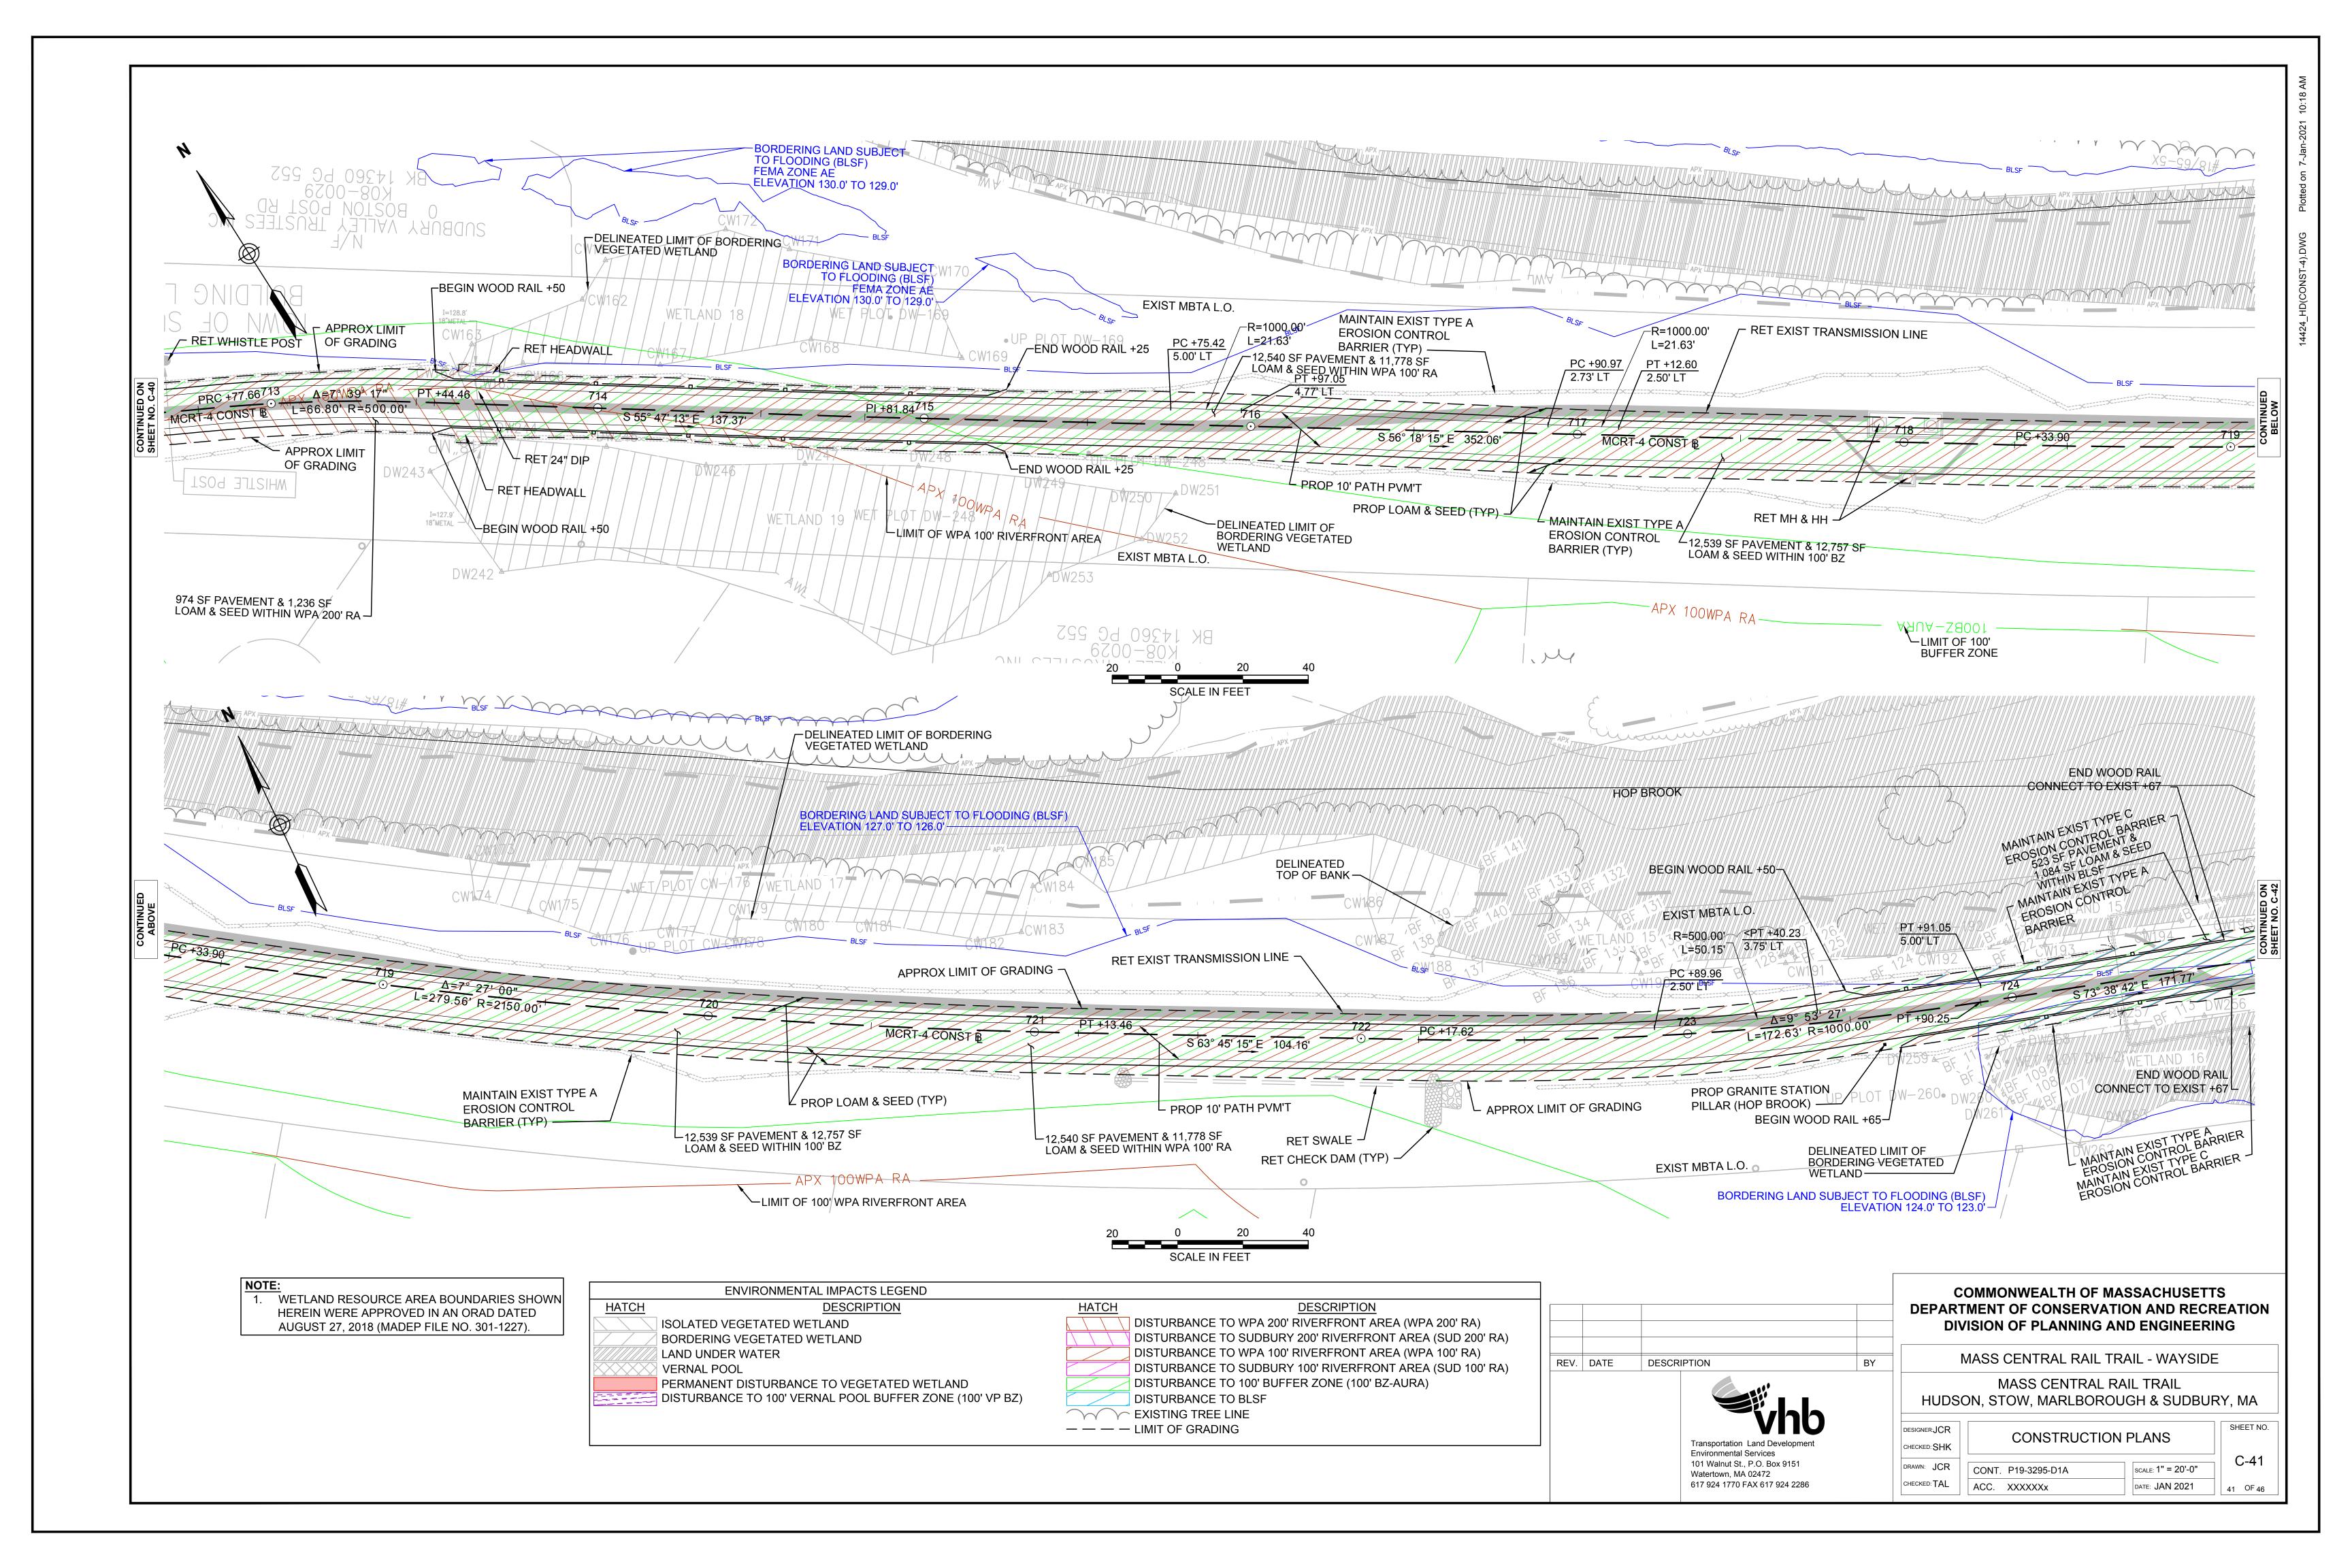


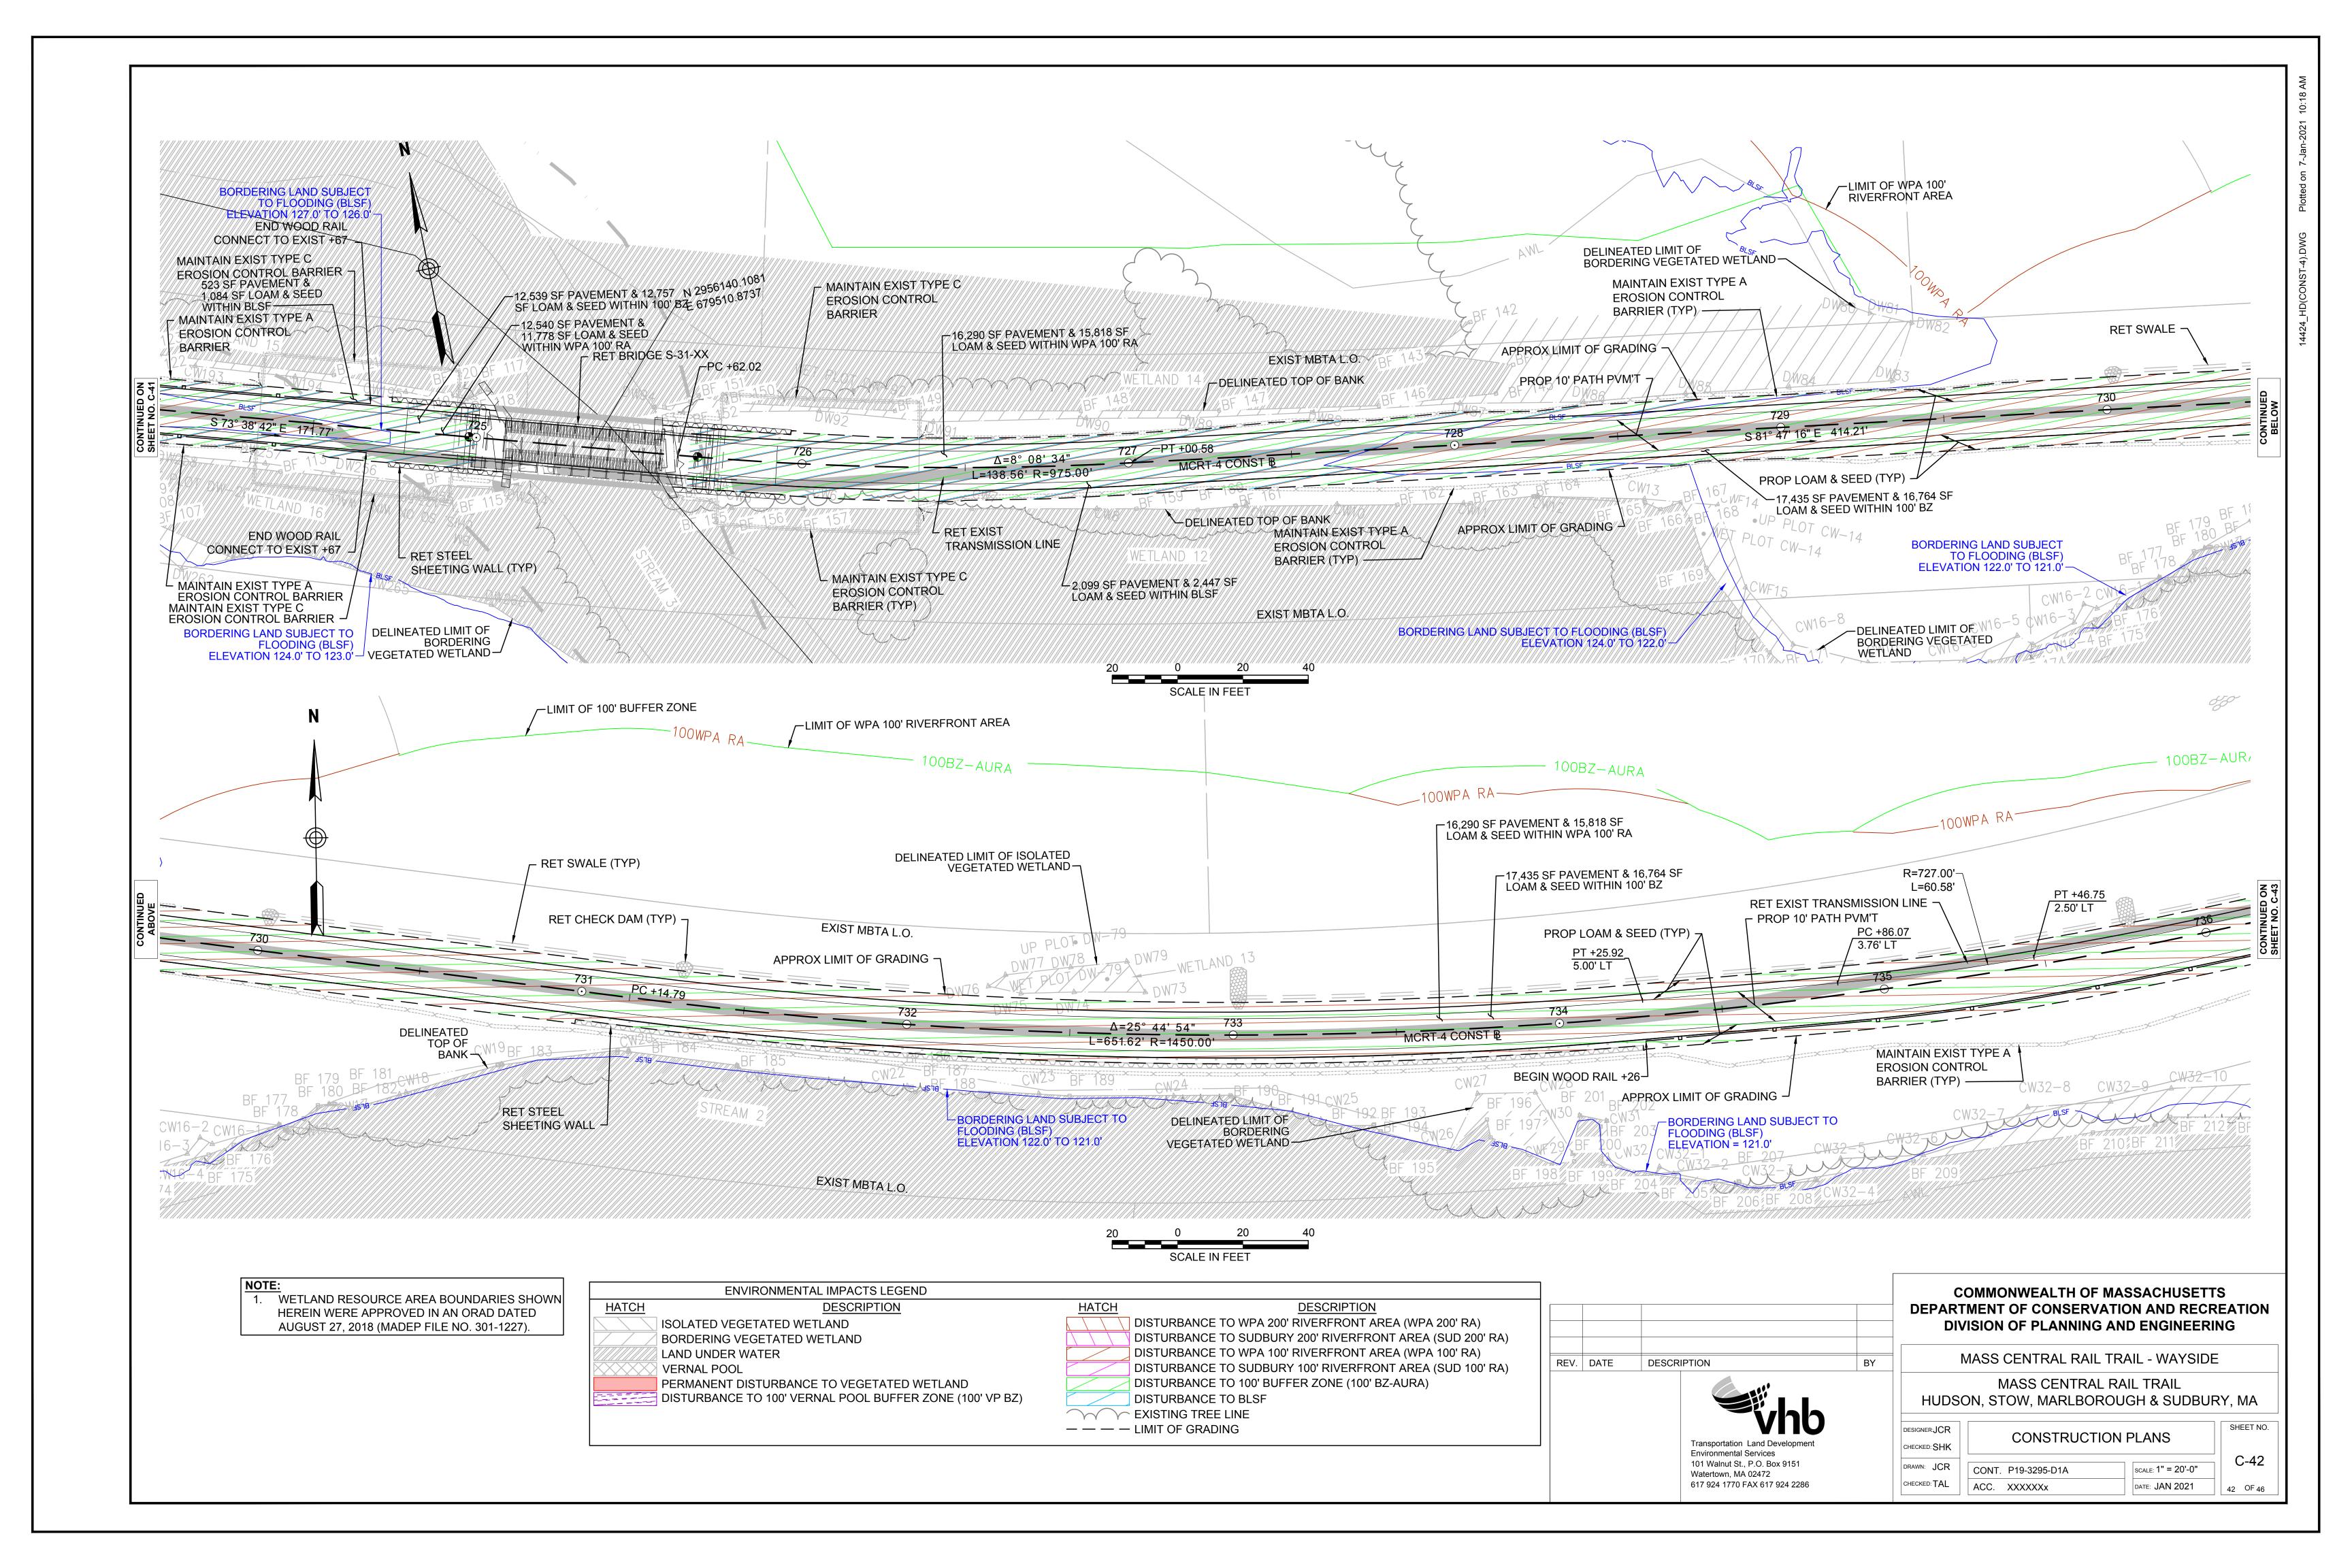


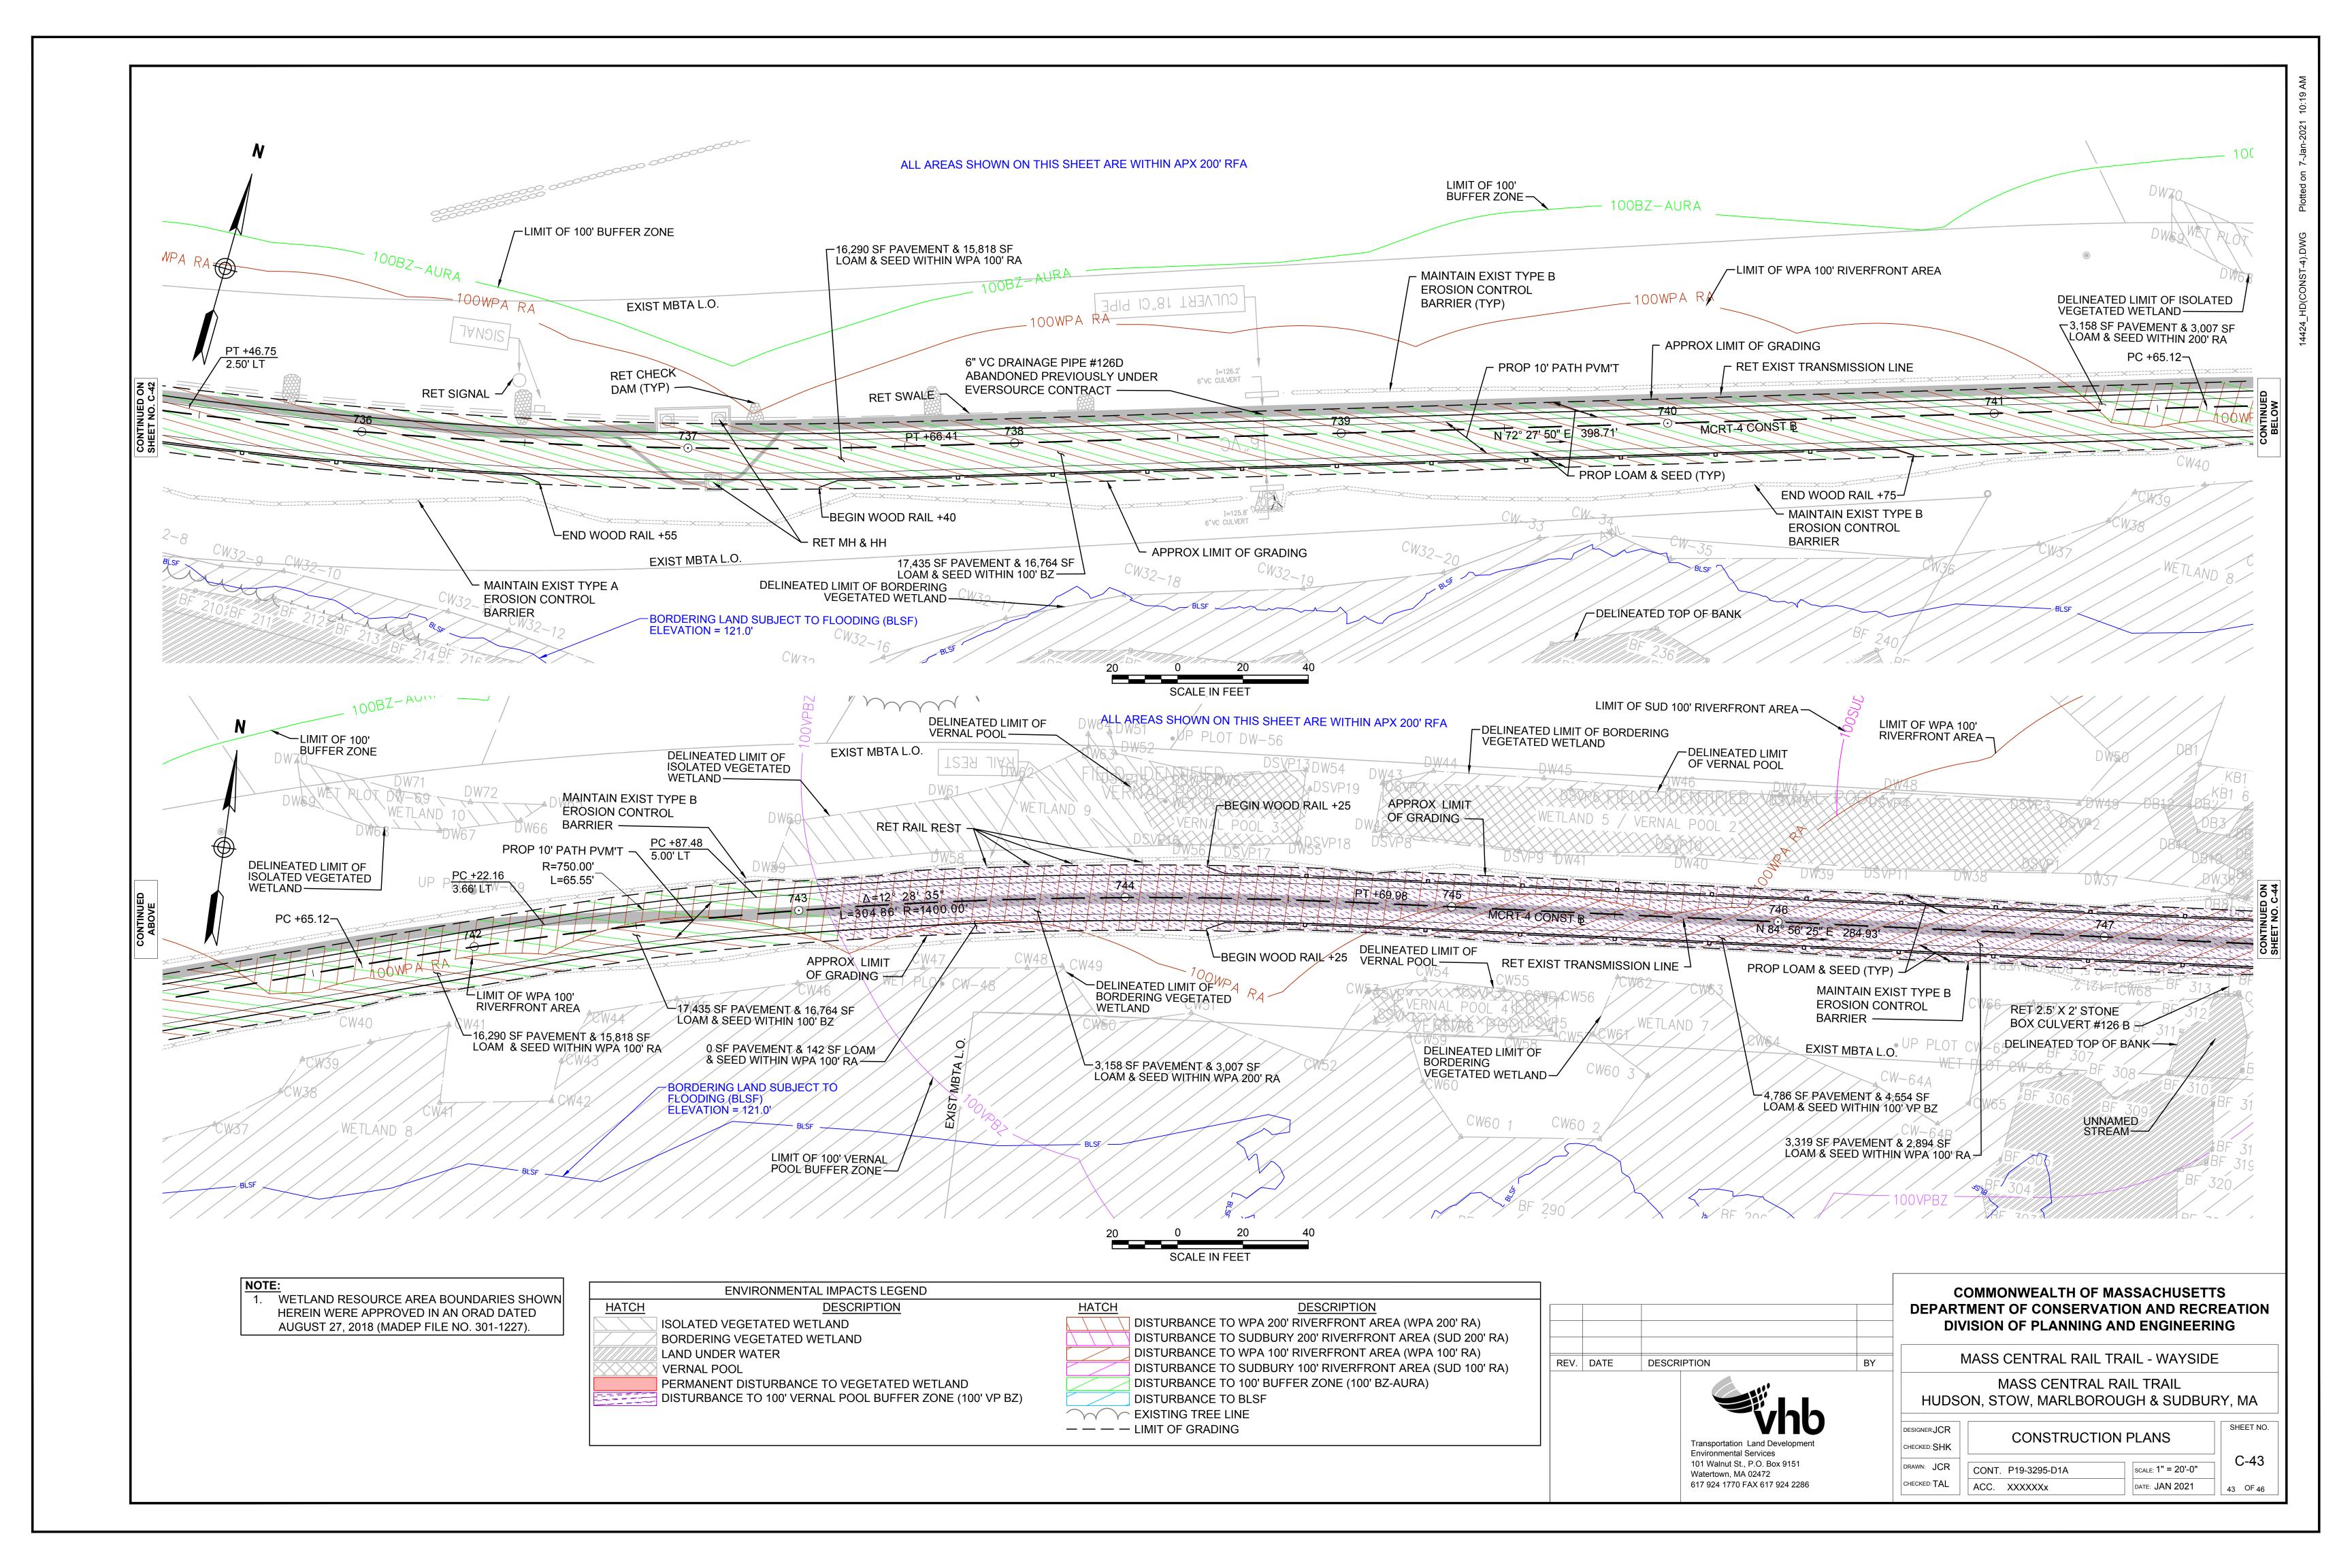


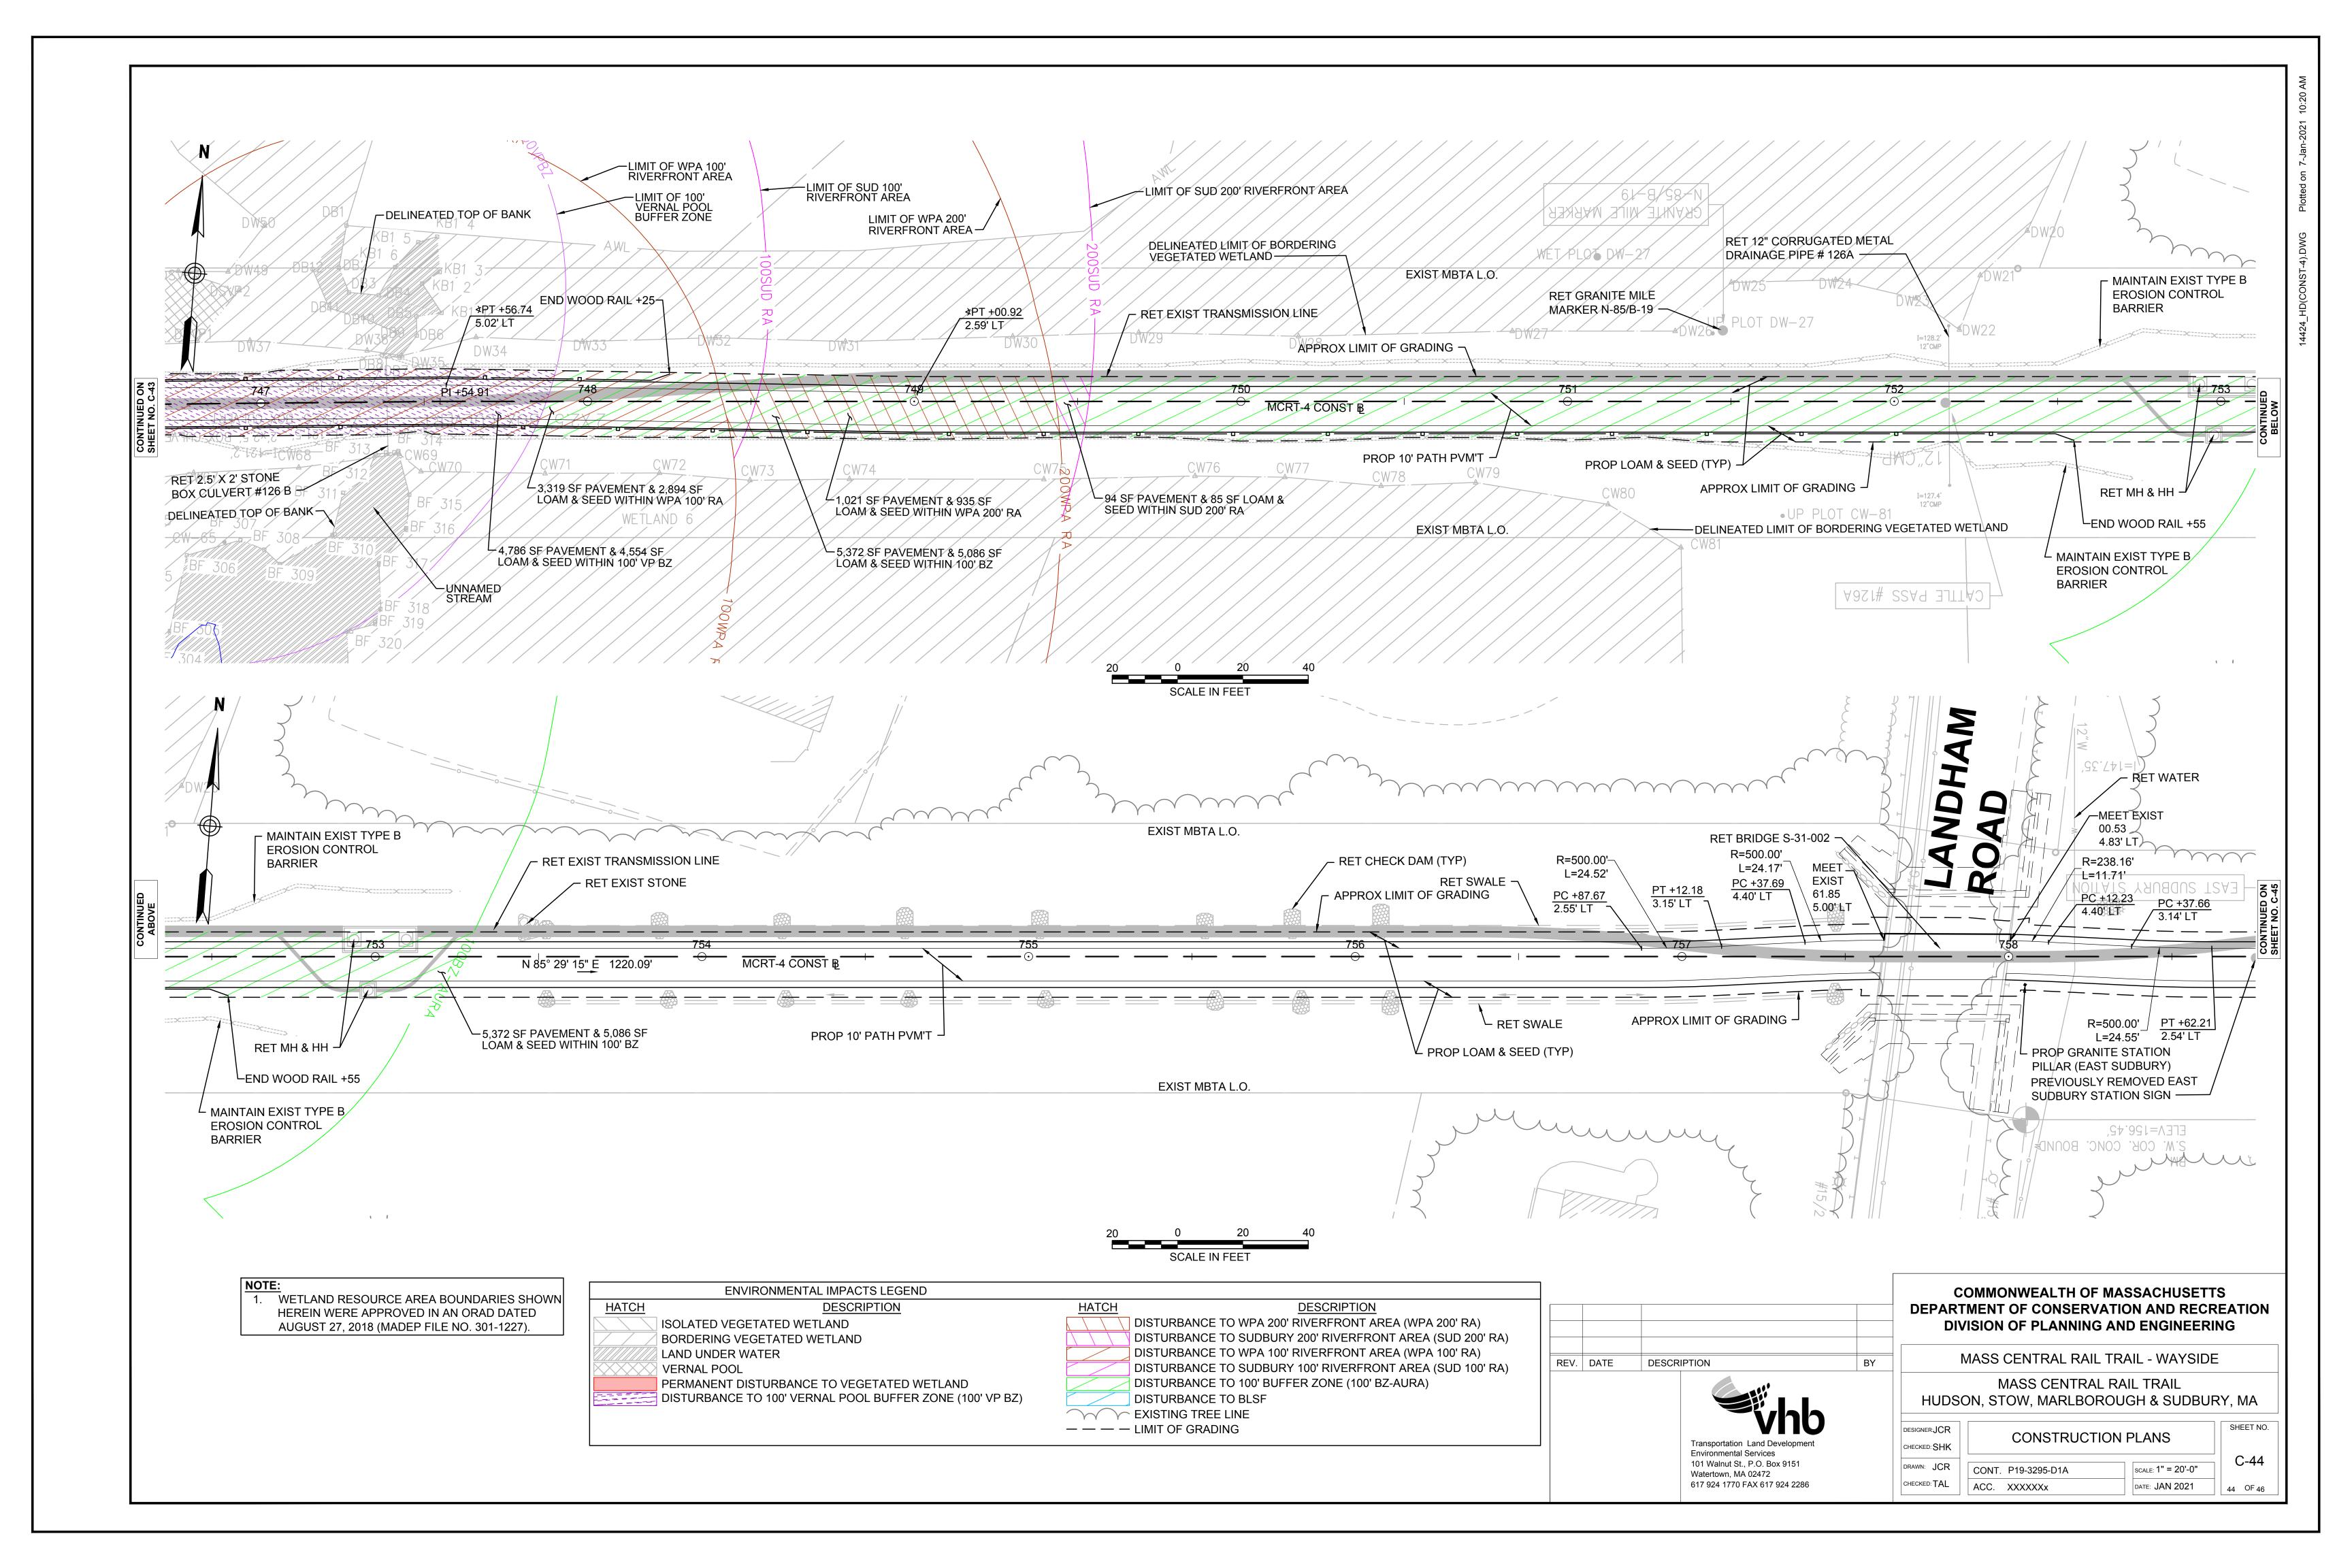


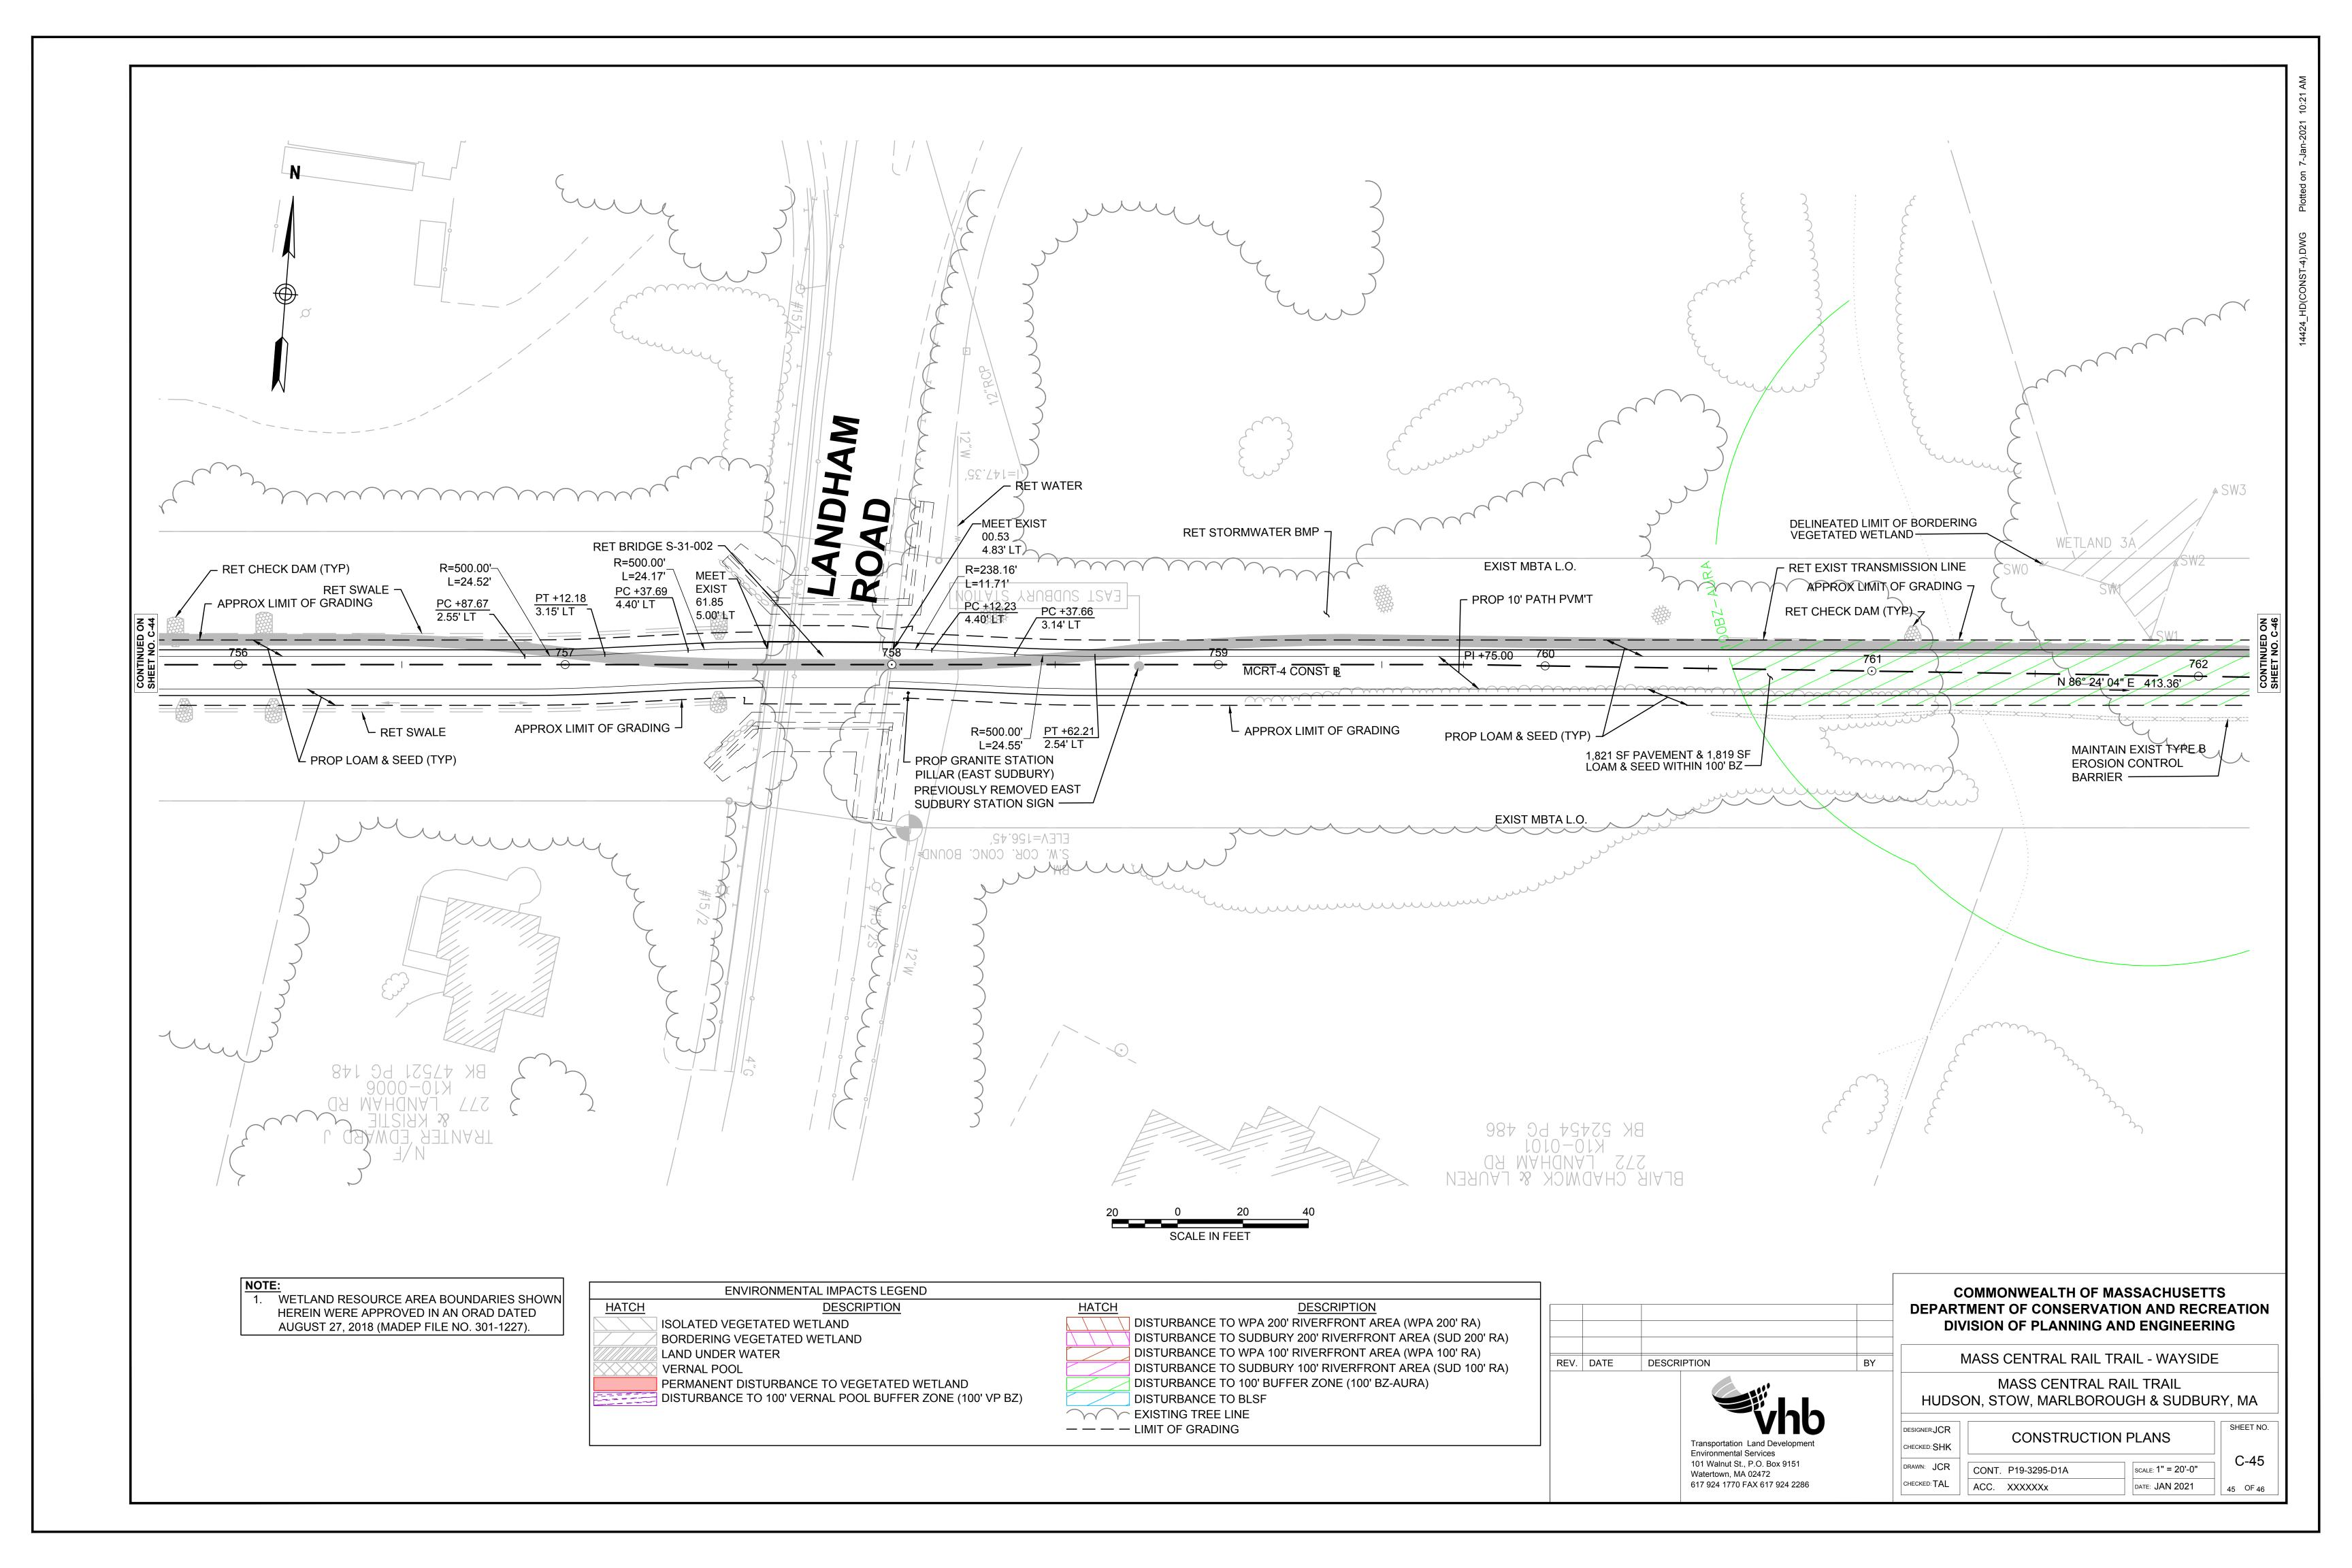


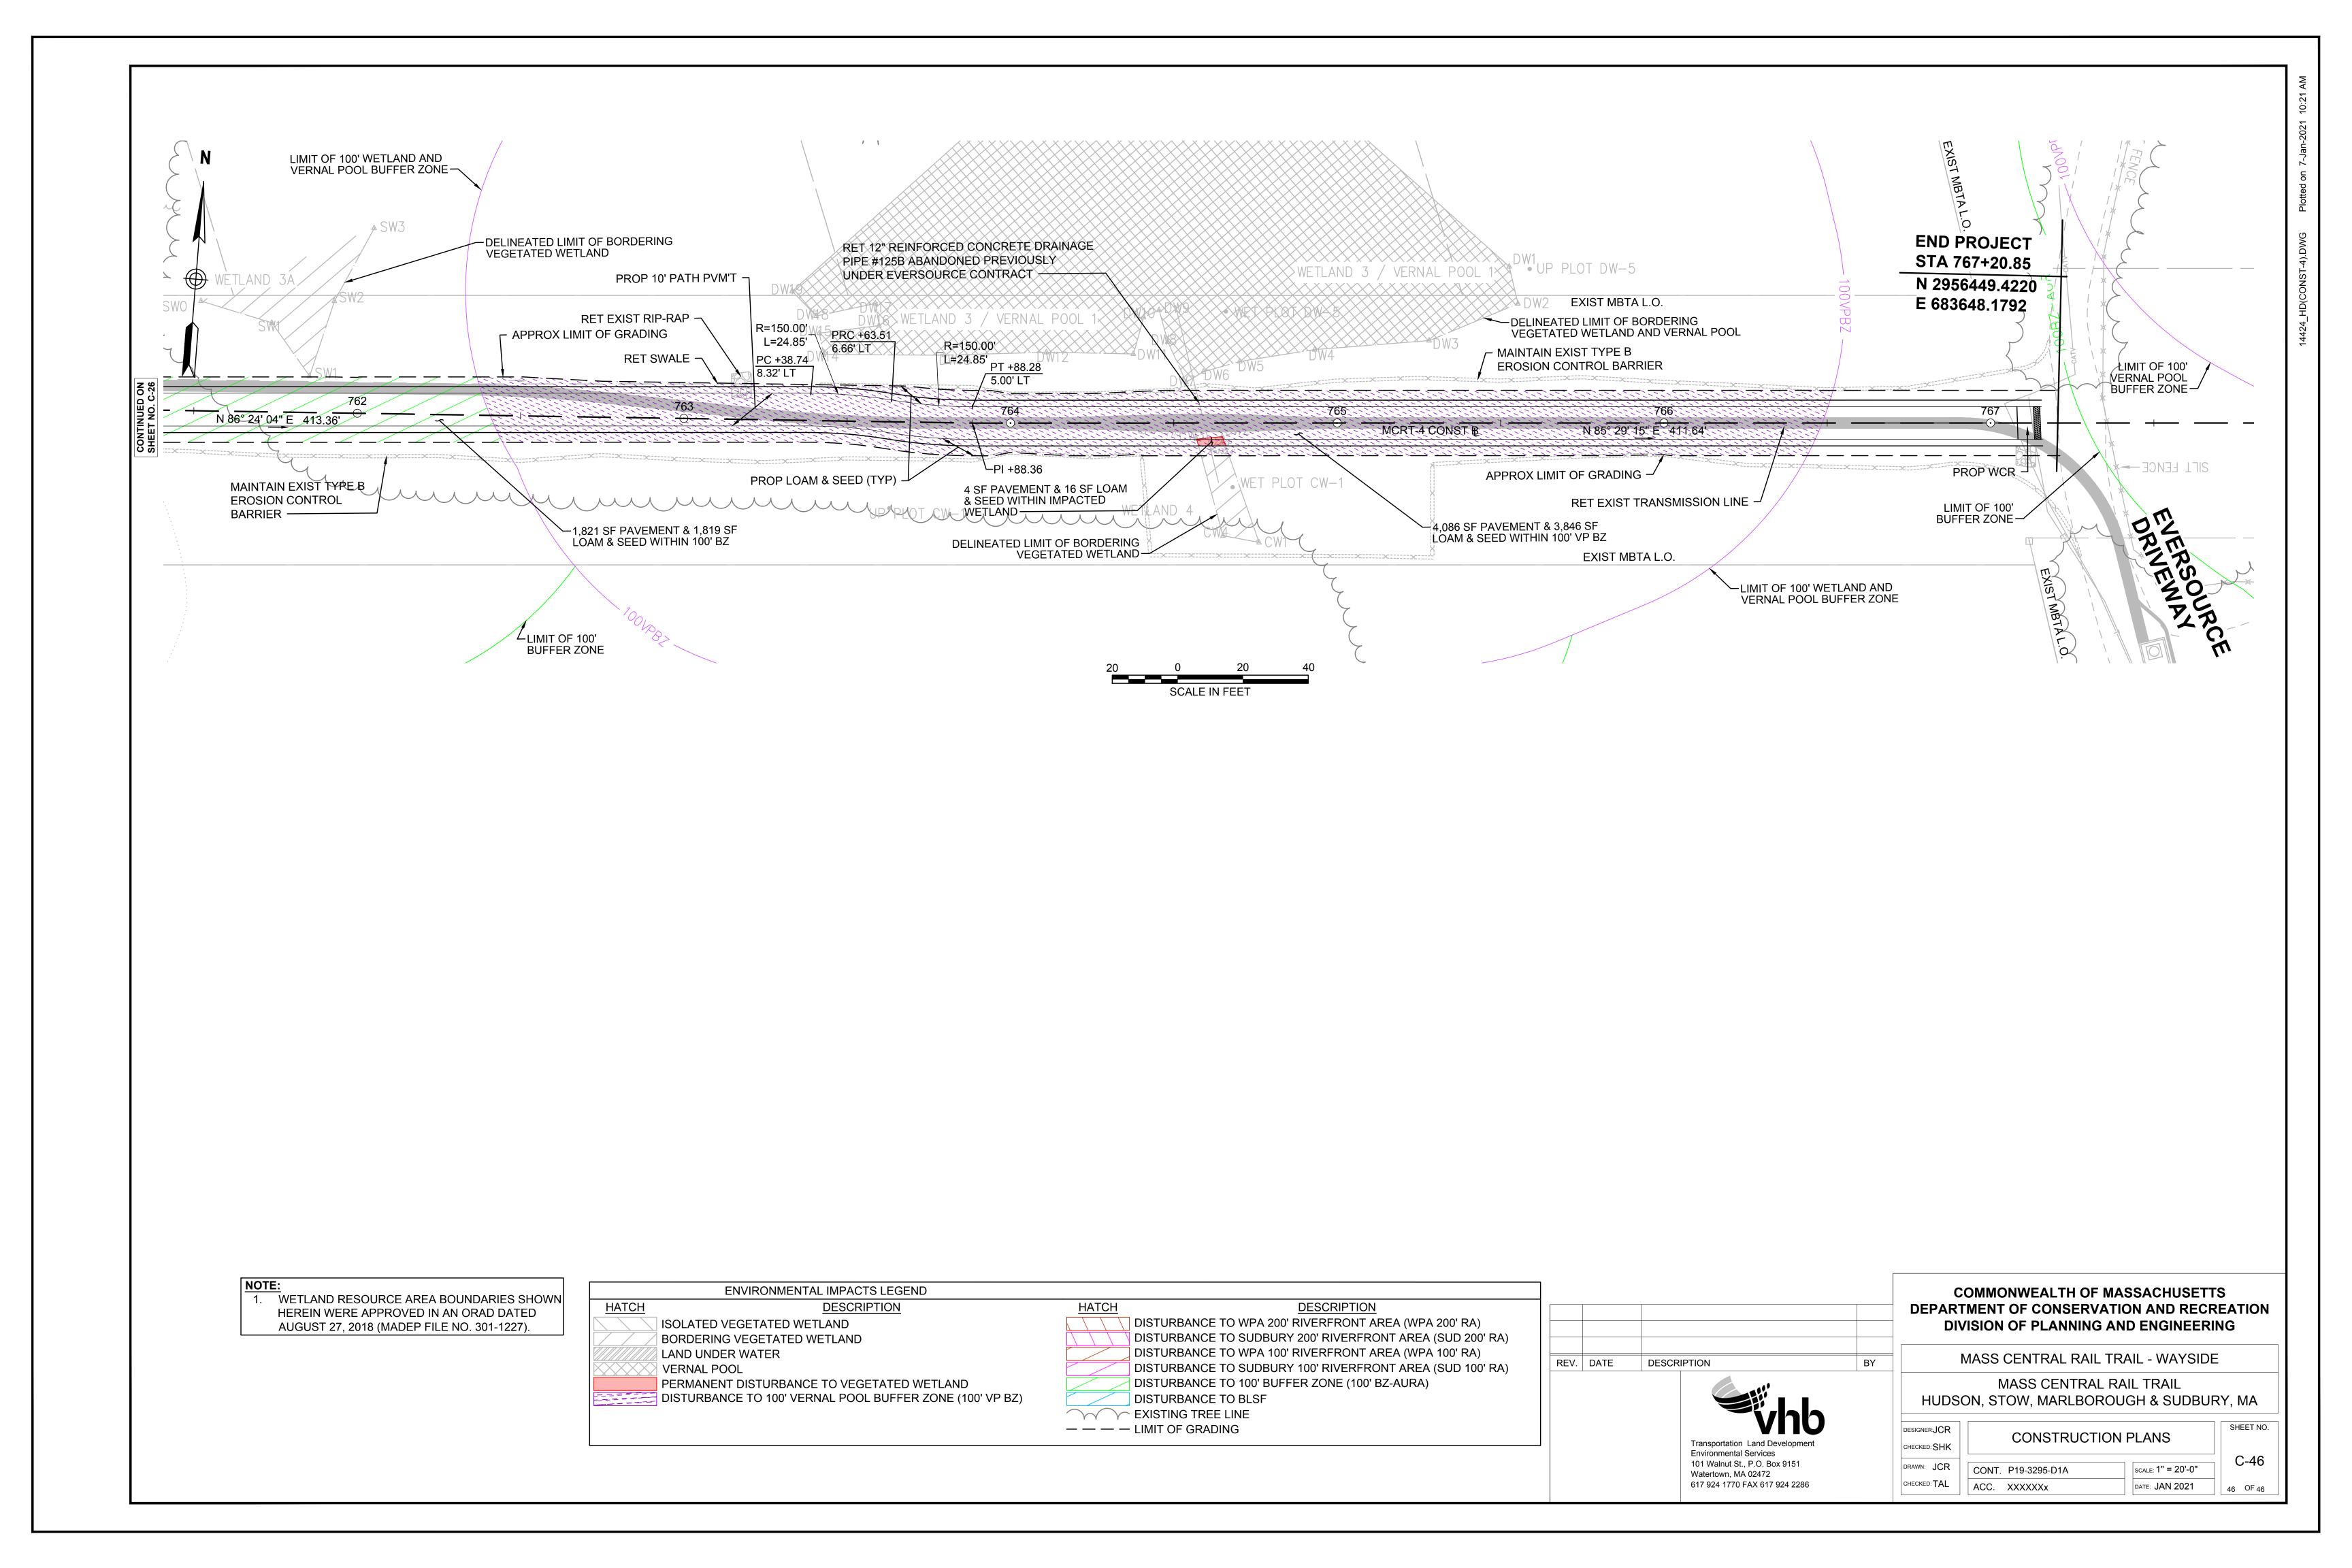


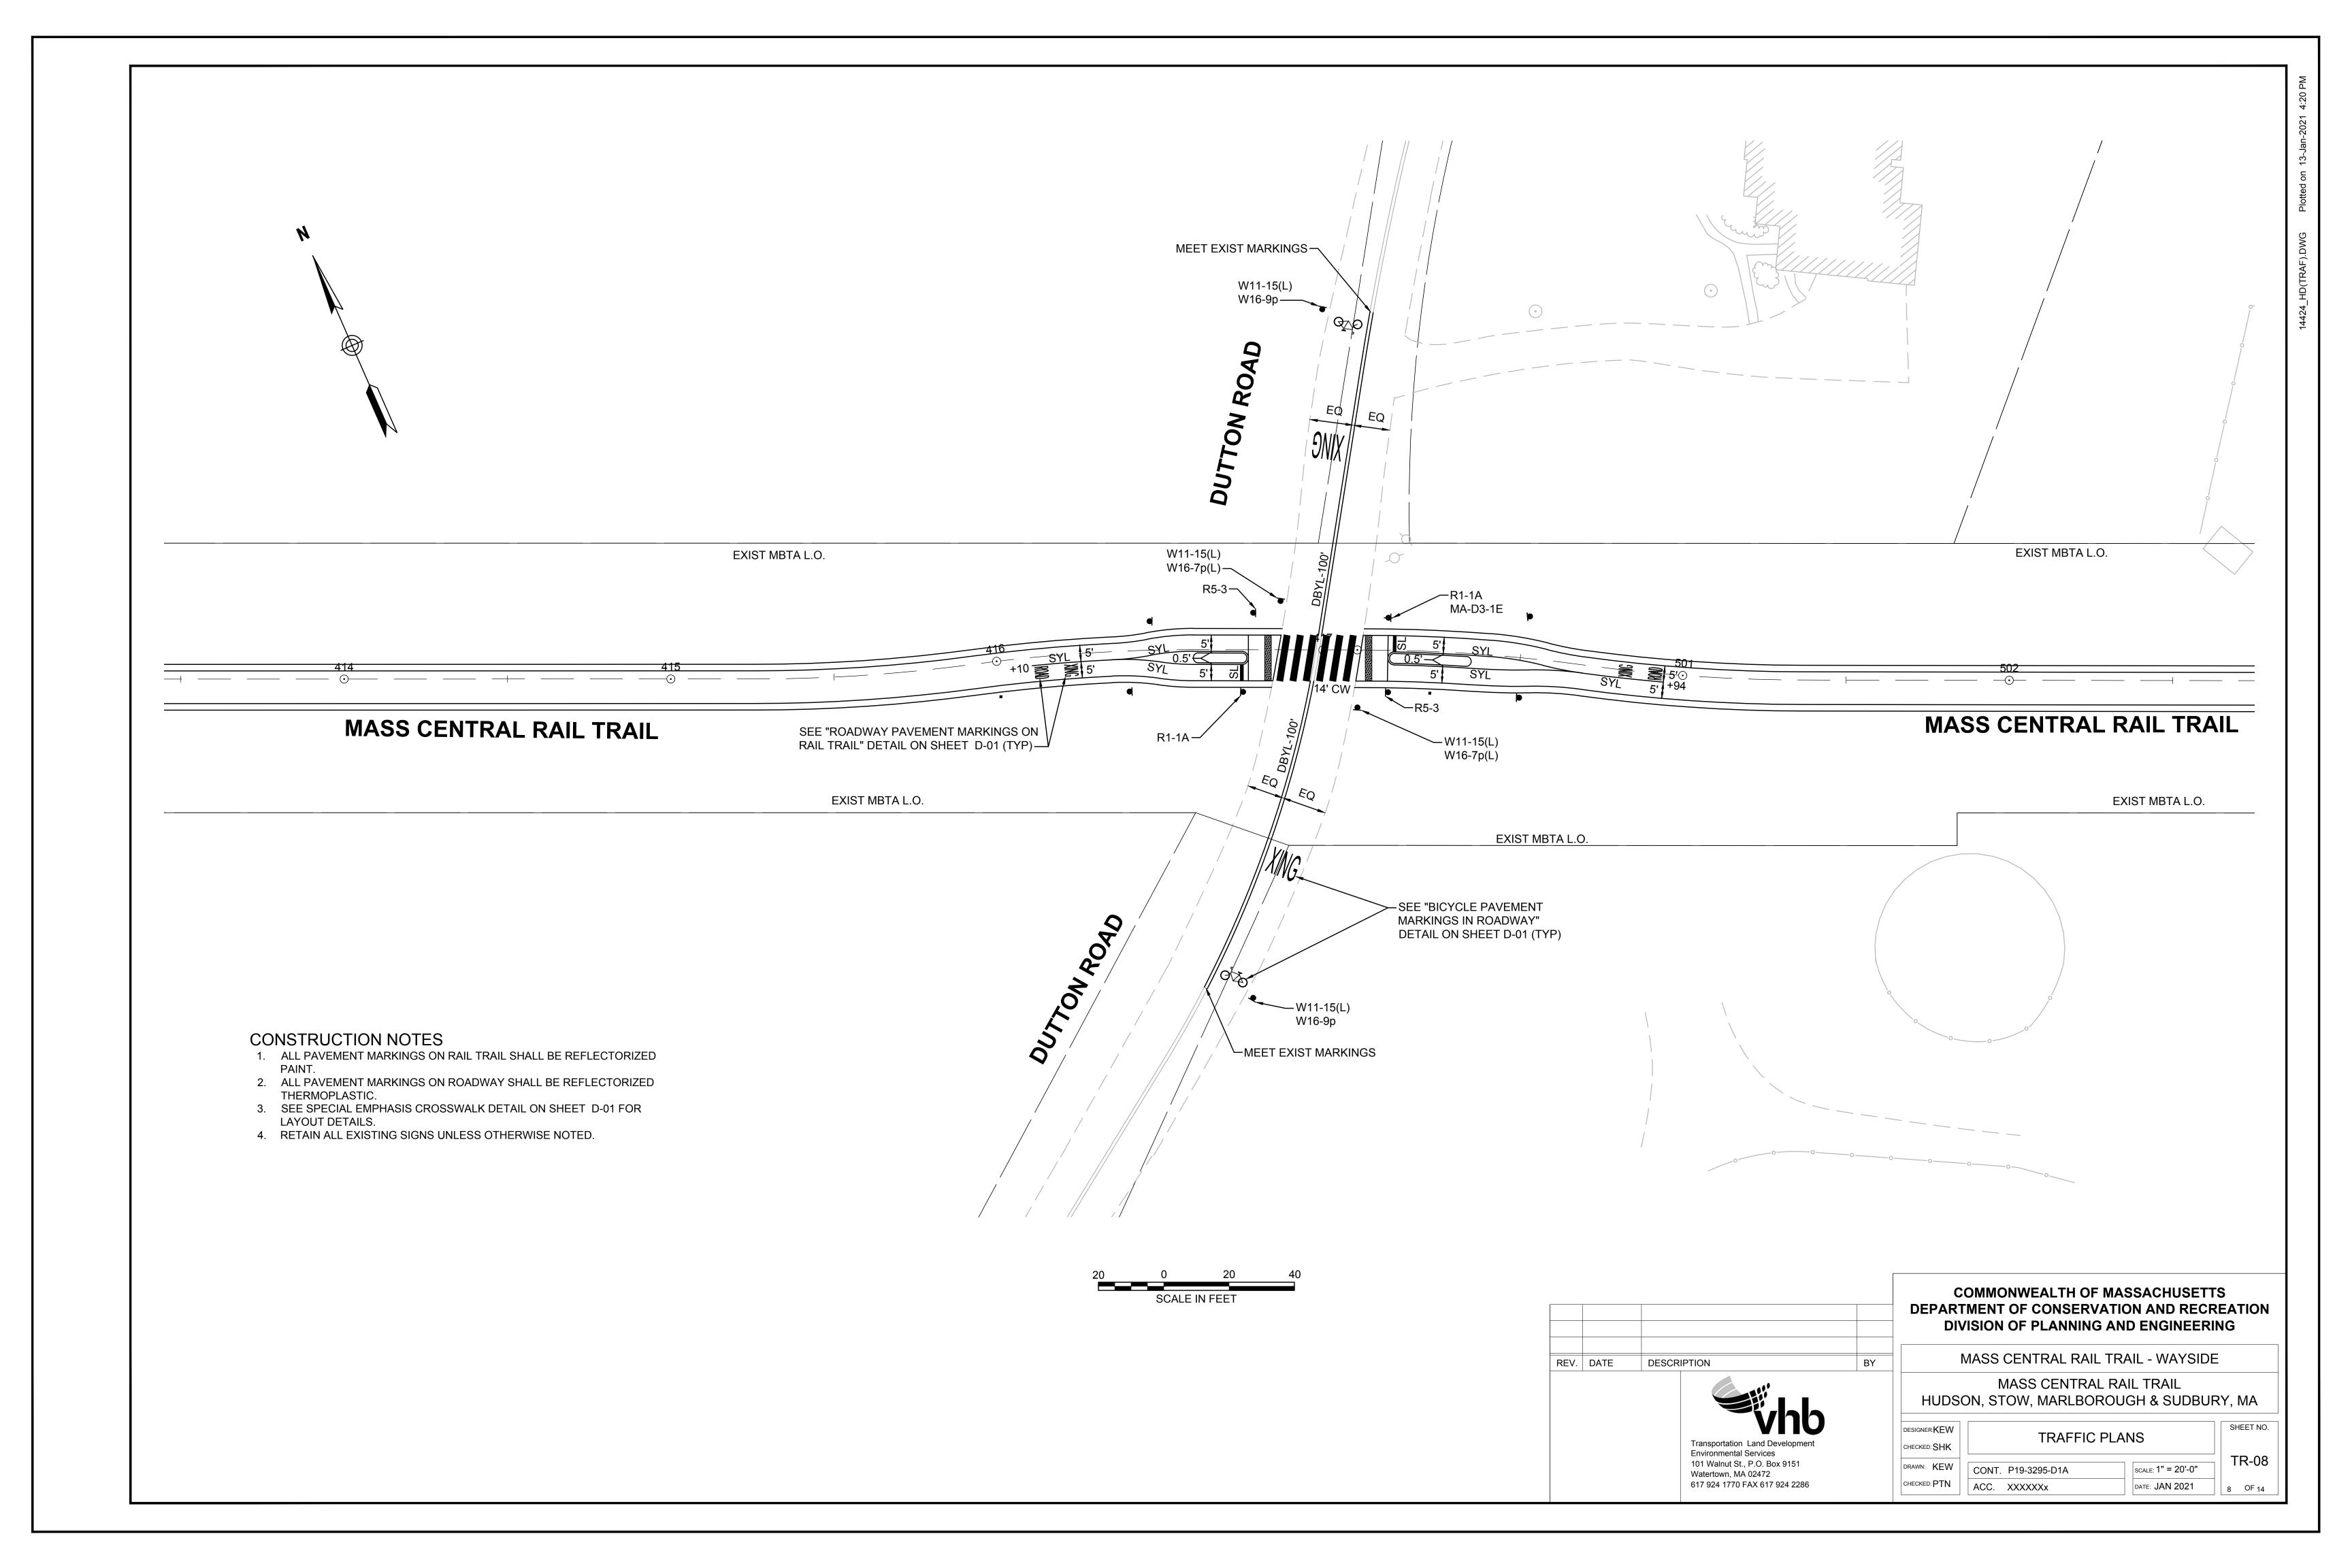

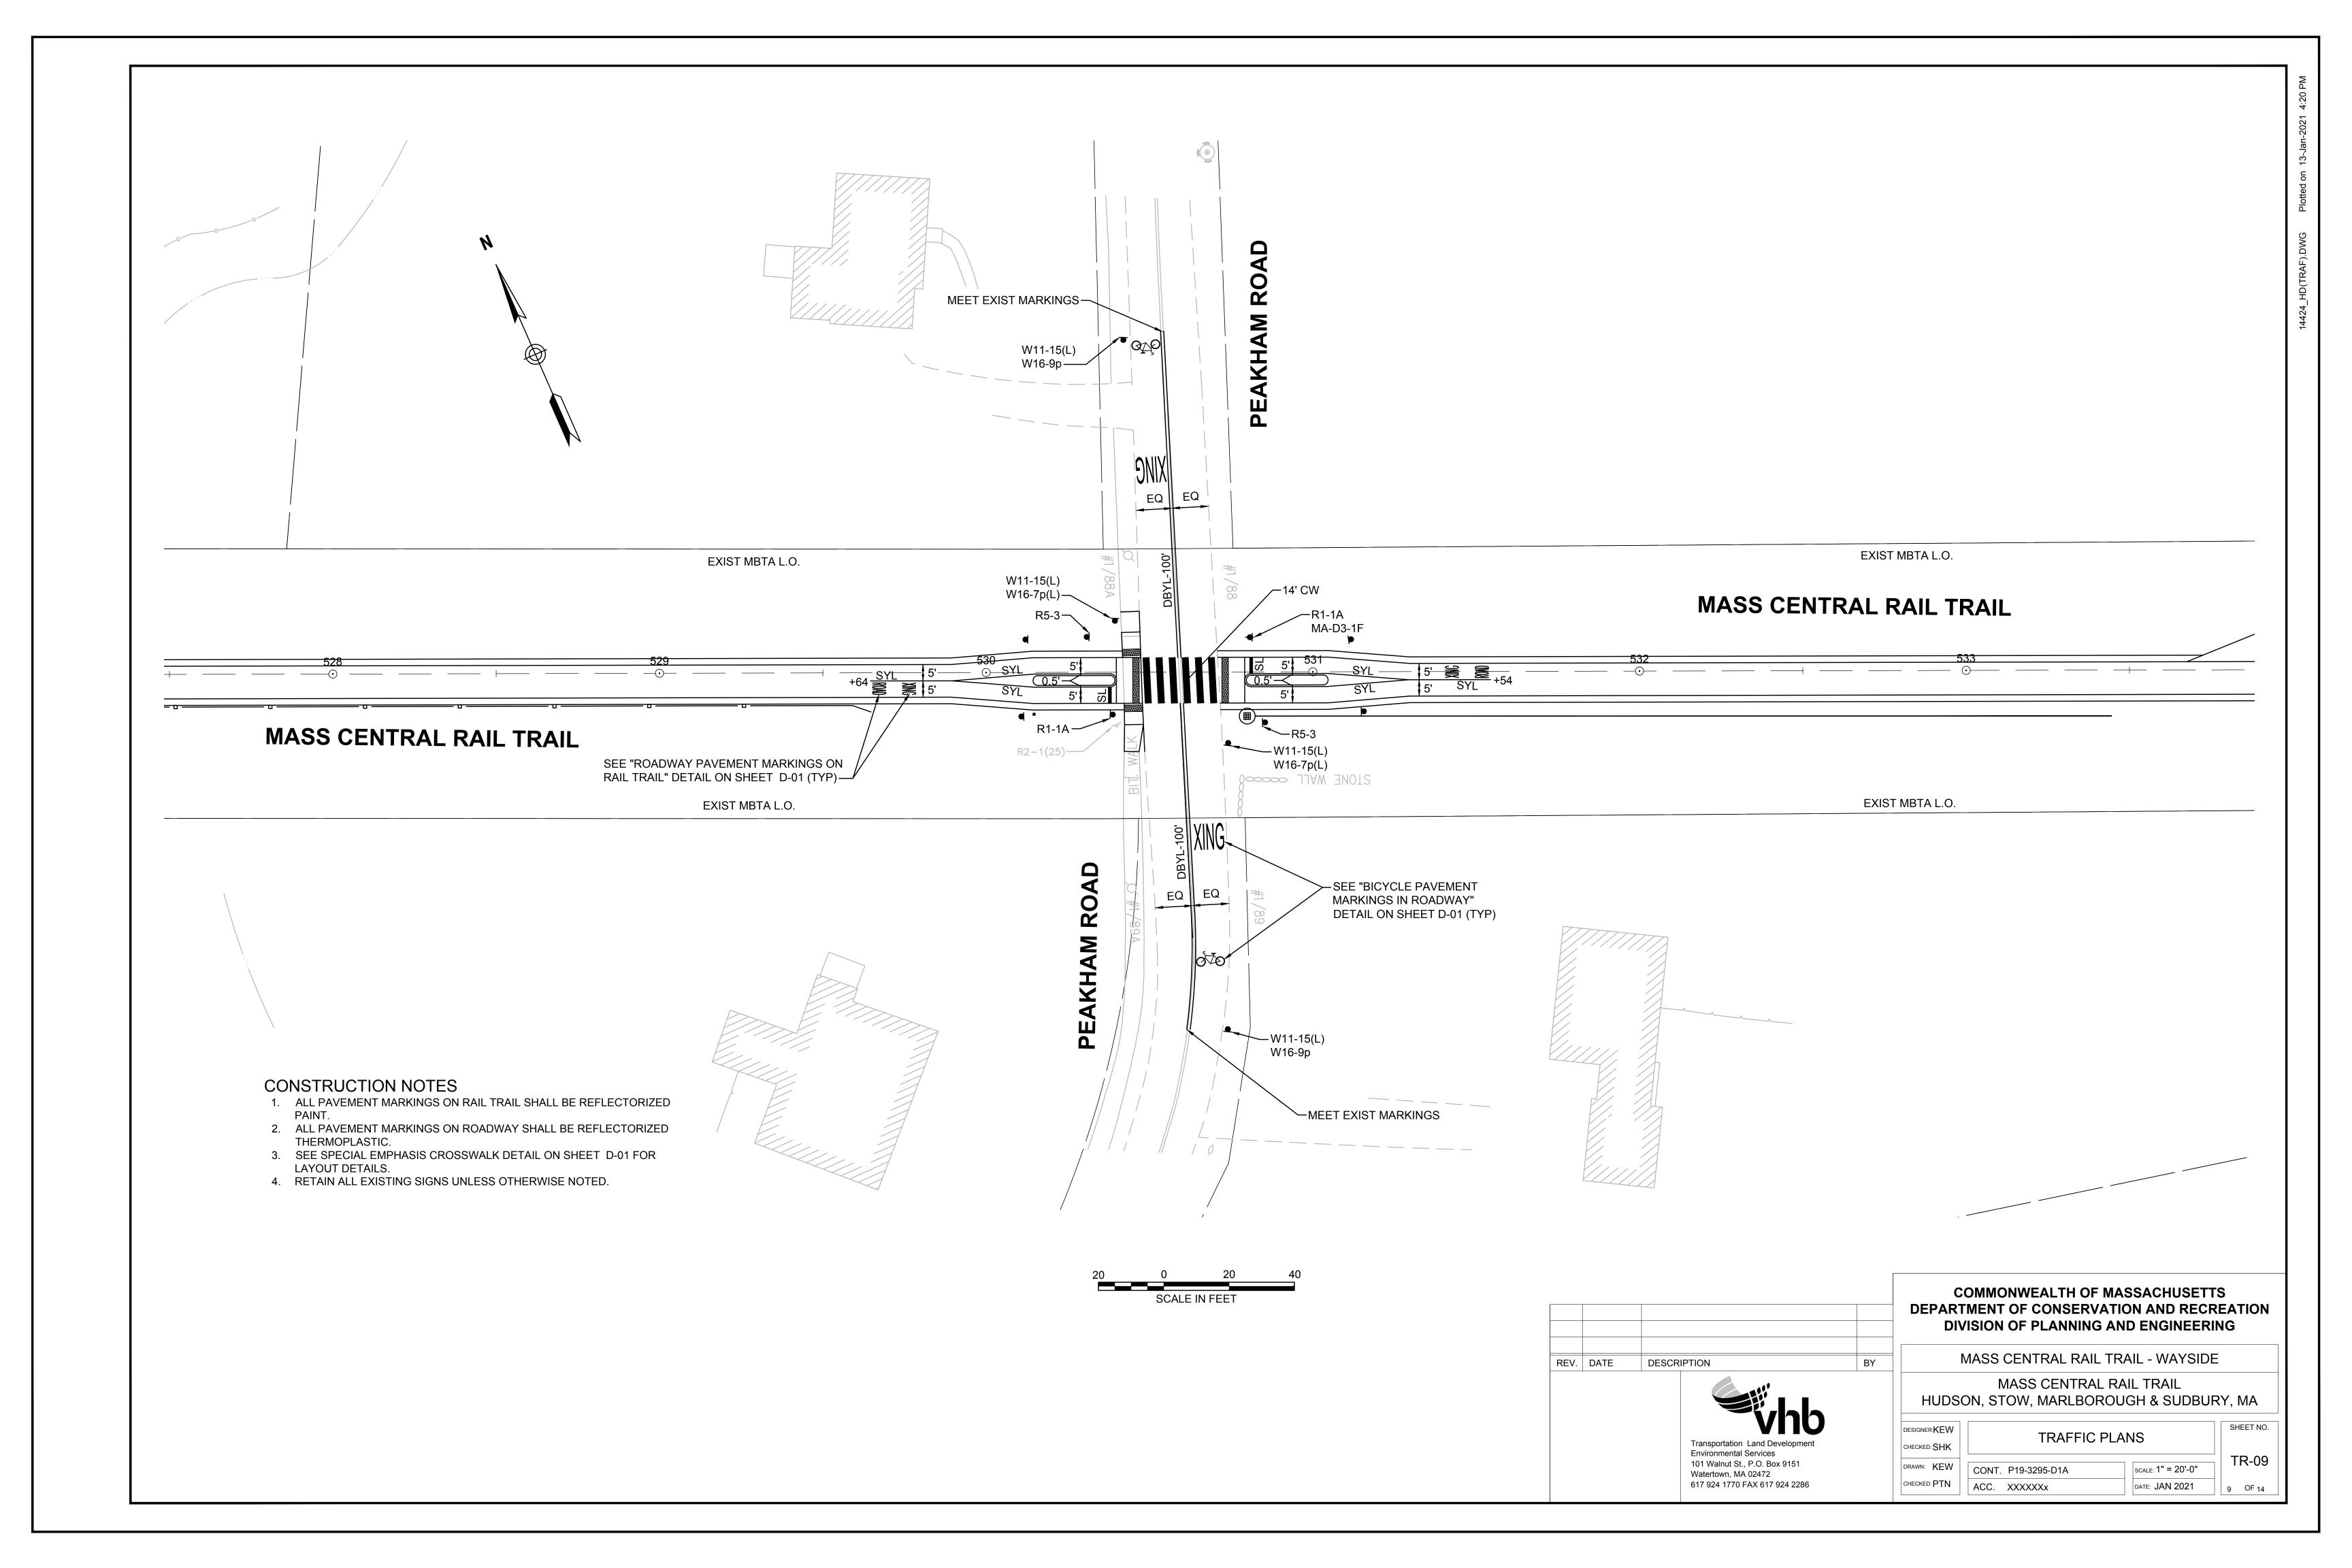

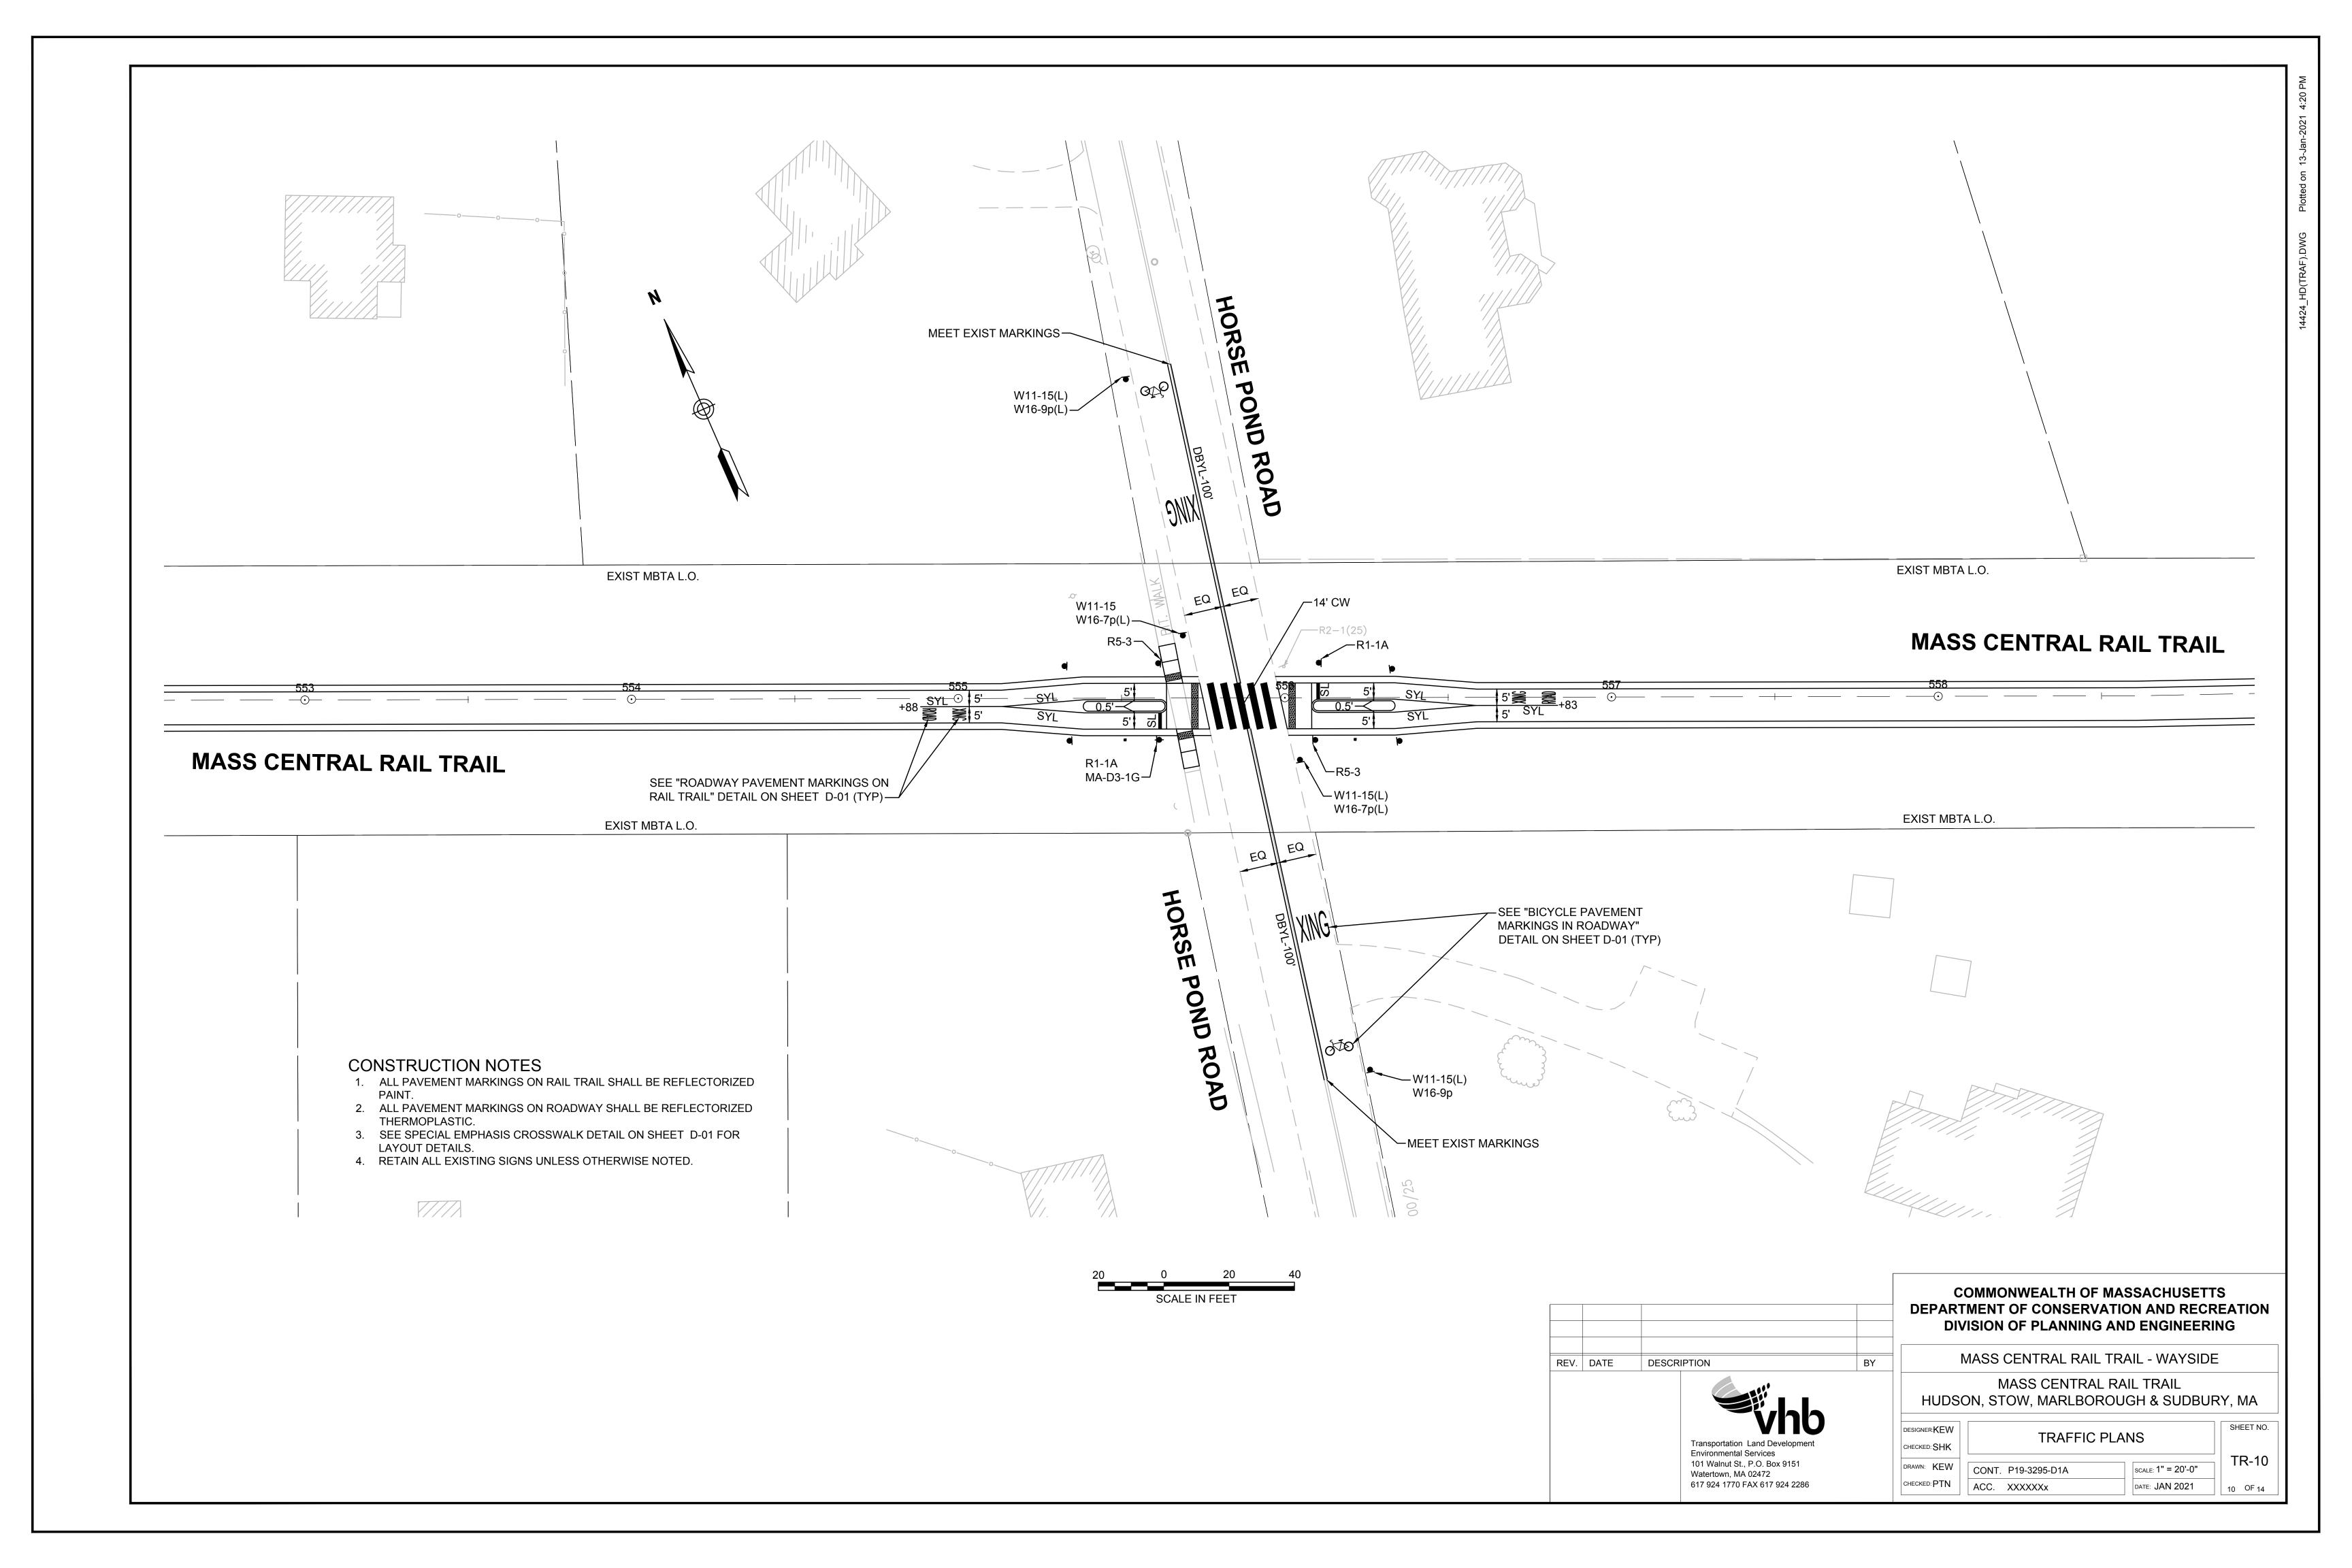

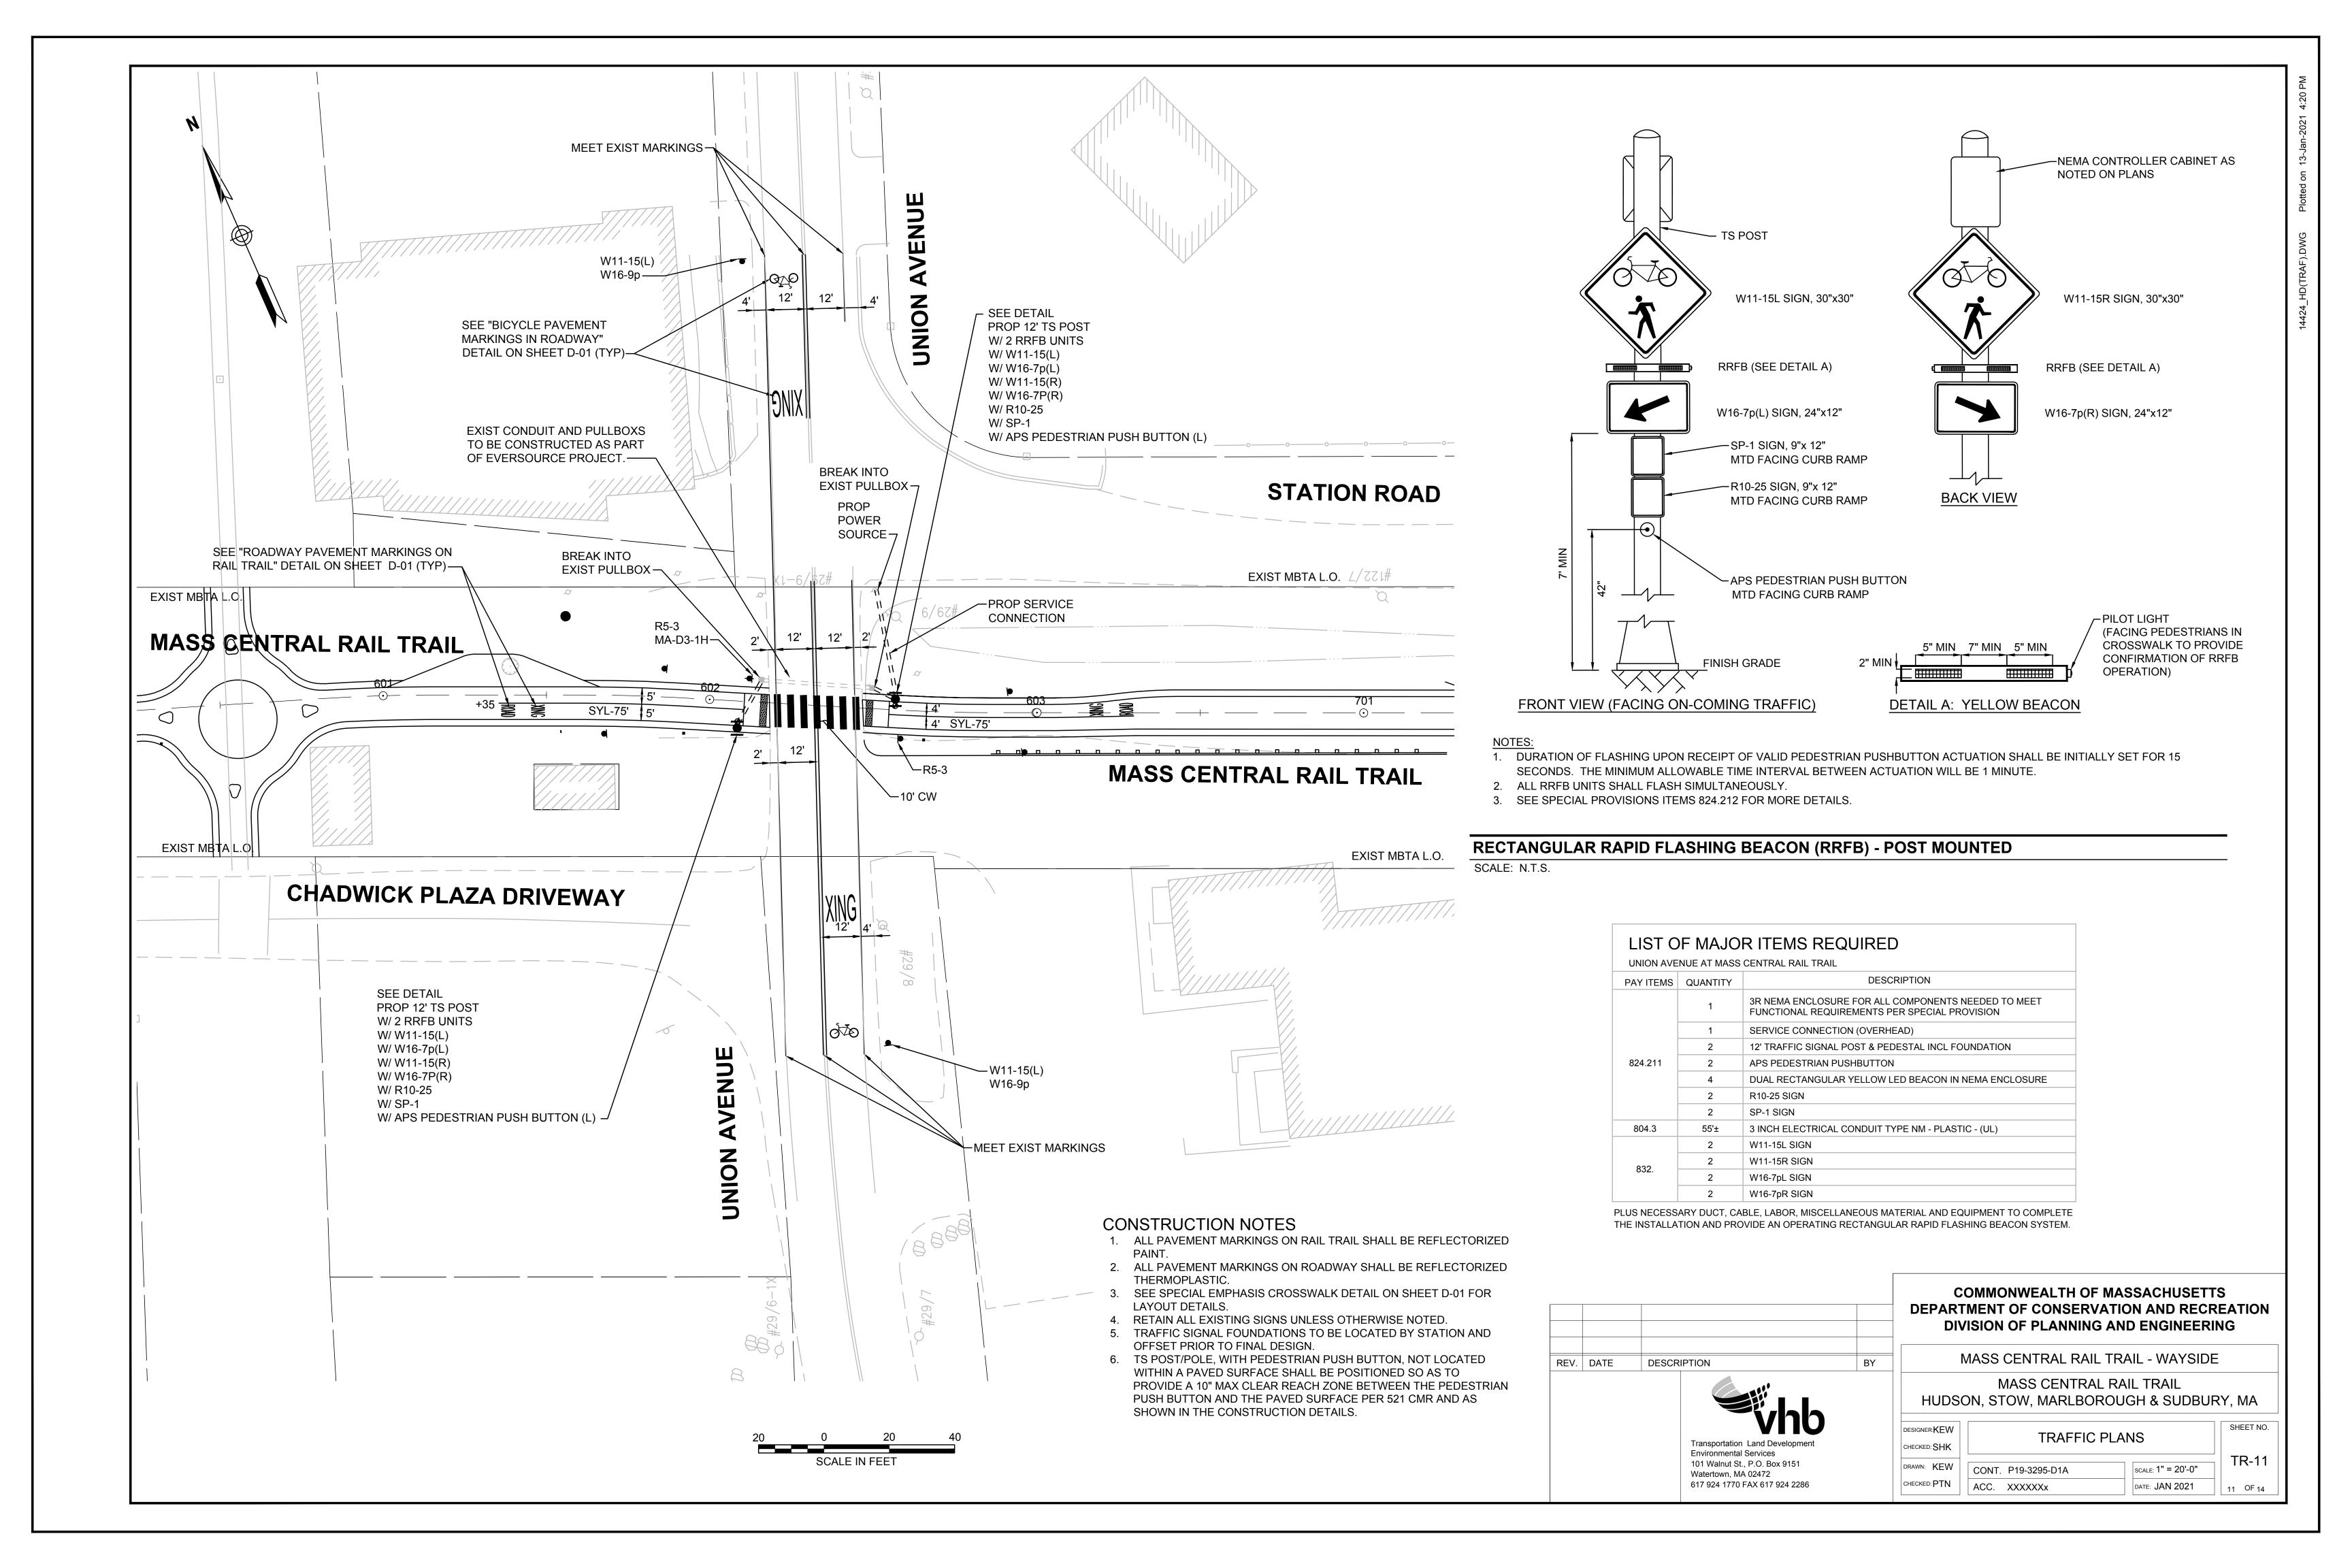

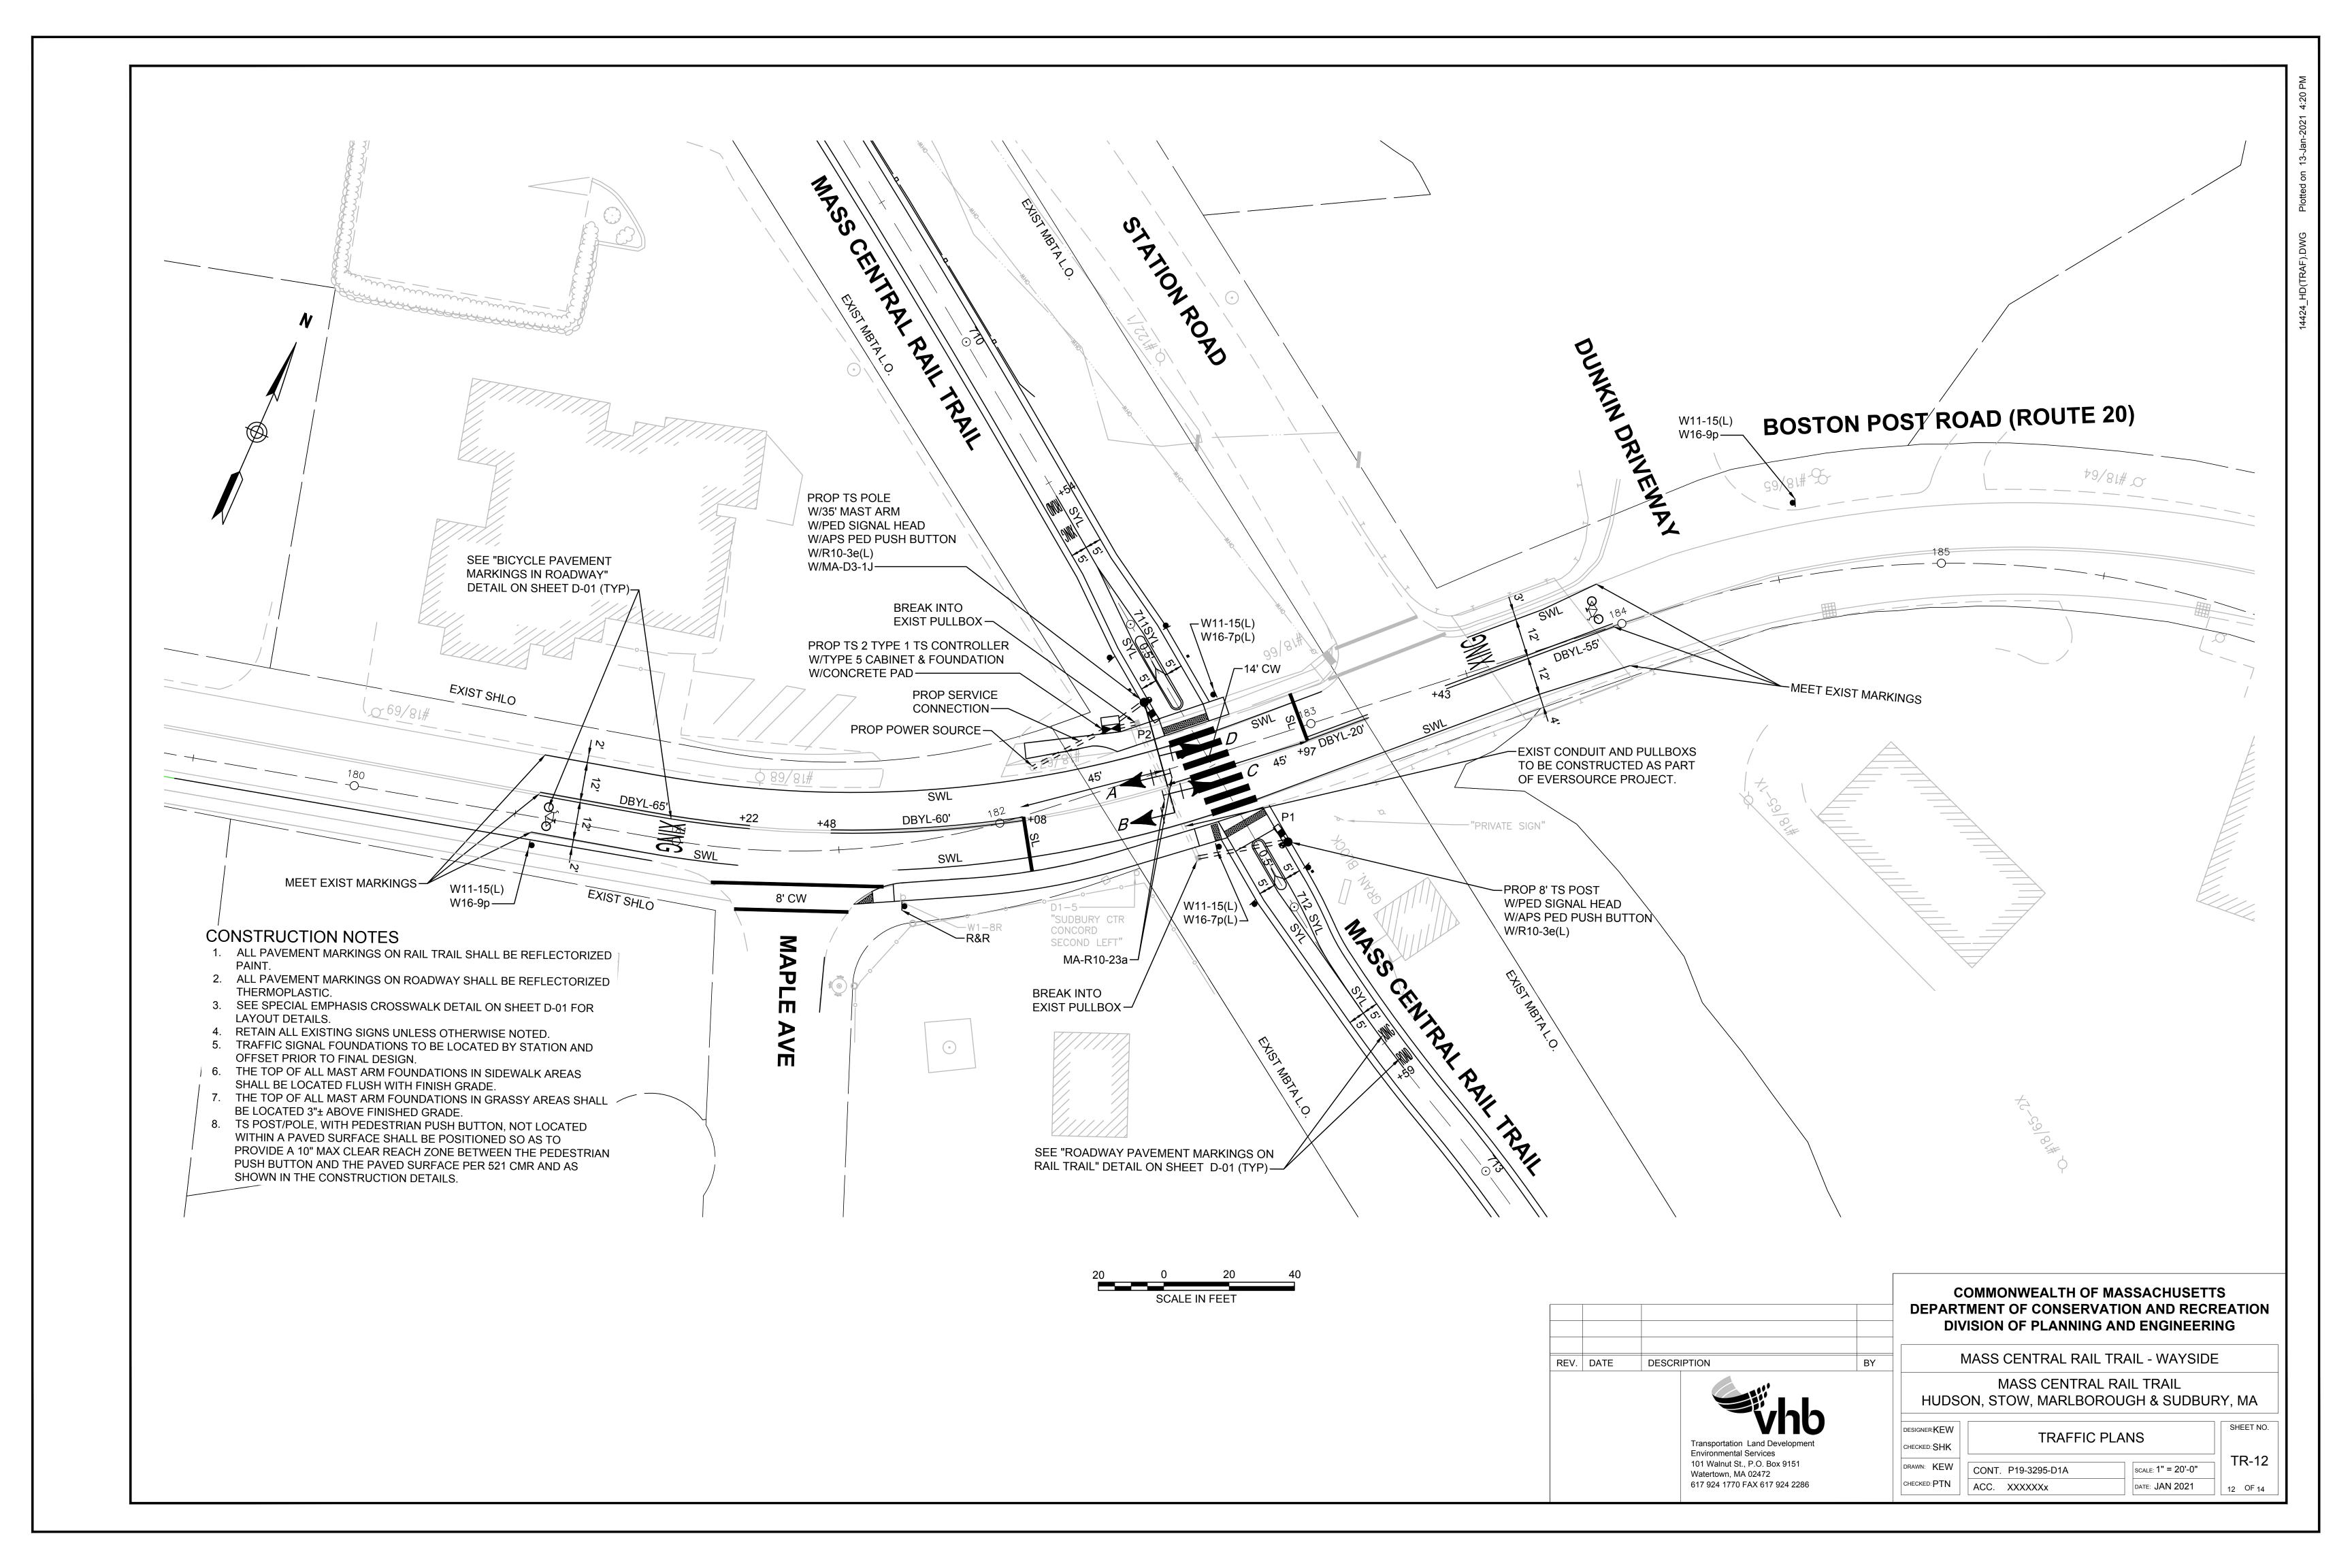

SEQUENCE AND TIMING FOR PRE-TIMED CONTROL (ISOLATED)

APPROACH	DIRECTION	HOUSING	1	2	3	4	5	FLASH
RTE 20 (BOSTON POST RD)	EB	A,B	DARK	FY	Y	R	FR	FY
RTE 20 (BOSTON POST RD)	WB	C,D	DARK	FY	Y	R	FR	FY
PEDESTRIAN X-ING	NB	P1-P2	DW	DW	DW	W	FDW	OUT
			TIM	ING IN S	SECOND	S		
MINIMUM GREEN (INITIAL)		40	5					
PASSAGE TIME (VEHICLE)			_	_				_ 、
MAXIMUM 1			40	5				FLASH I ONLY
MAXIMUM 2			40	5				50
STEADY YELLOW INTERVAL					4			CONFLICT
STEADY RED INTERVAL						7		NF. -RA:
PEDESTRIAN WALK INTERVAL					7		CO	
PEDESTRIAN CLEARANCE INTERVAL							15	
DETECTOR MEMORY			_		-	_		
RECALL	OFF		-	_				

- 1. AUTOMATIC FLASHING OPERATION PER 2009 M.U.T.C.D., AS AMENDED.
- 2. * UPON PEDESTRIAN PUSH BUTTON ACTUATION
- 3. FR = ALTERNATING FLASHING RED
 4. MAXIMUM 1 = NORMAL OPERATION
- 5. MAXIMUM 2 = NOT USED
- 6. STOP AND GO OPERATION FOR 24 HOURS PER DAY. FLASHING OPERATION FOR
- EMERGENCY ONLY.
- 7. DURING PEDESTRIAN INTERVAL, FDW THROUGH YELLOW OPERATION SHALL NOT BE IN


SEQUENCE & TIMING NOTES:

- 1. IF THE ASSIGNED RIGHT OF WAY FOR ANY TRAFFIC MOVEMENT IS TO REMAIN IN EFFECT DURING THE NEXT CALLED PHASE, THE SIGNAL INDICATIONS FOR THAT TRAFFIC MOVEMENT WILL NOT CHANGE DURING THE CLEARANCE INTERVAL.
- 2. THE RIGHT OF WAY MAY BE ASSIGNED TO ANY PHASE OR ANY COMBINATION OF NON-CONFLICTING PHASES.
- 3. IF CALLS EXIST ON ALL PHASES, THE ASSIGNMENT OF RIGHT OF WAY SHALL BE IN ACCORDANCE WITH THE PREFERENTIAL PHASE SEQUENCE.
- 4. IF THE ASSIGNED RIGHT-OF-WAY FOR ANY TRAFFIC MOVEMENT IS TO CHANGE DURING THE NEXT CALLED PHASE, THE SIGNAL INDICATION FOR THAT MOVEMENT WILL DISPLAY THE APPROPRIATE CLEARANCE INTERVALS.
- 5. THE HYBRID BEACON SHALL OPERATE THROUGH NORMAL SEQUENCE WHEN ACTIVATED BY INFRARED CAMERA. DURATION OF HYBRID BEACON OPERATION UPON RECEIPT OF VALID INFRARED CAMERA ACTUATION SHALL BE AS SHOWN IN THE SEQUENCE & TIMING CHART.

SIGNAL HEAD DATA A,B,C,DP1-P2 W/COUNTDOWN TIMER ALL 12" LENS

- 1. ALL SIGNAL HEADS SHALL BE RIGID MOUNTED.
- 2. ALL SIGNAL HEADS SHALL BE EQUIPPED WITH 5"± NON-LOUVERED BACKPLATES. ALL
- BACKPLATES SHALL CONTAIN A 3" WIDE YELLOW REFLECTIVE BORDER. 3. ALL SIGNAL HEADS SHALL BE EQUIPPED WITH TUNNEL VISORS.
- 4. ALL SIGNAL DISPLAYS SHALL BE EQUIPPED WITH L.E.D. MODULES.

HAWK (PEDESTRIAN) PHASE SEQUENCE

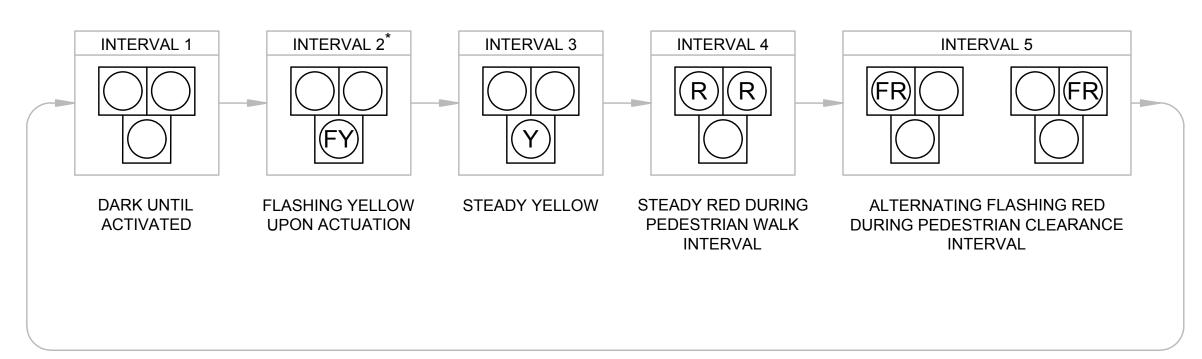

* UPON PEDESTRIAN PUSH BUTTON ACTUATION R = STEADY RED FR = FLASHING RED Y = STEADY YELLOW FY = FLASHING YELLOW

LIST OF MAJOR ITEMS REQUIRED							
BOSTON P	OSTROAD (RC	DUTE 20) AT MASS CENTRAL RAIL TRAIL					
PAY ITEM QUANTITY DESCRIPTION							
	1	8Ø TS 2 TYPE 1 CONTROLLER IN A TYPE 5 BASE MOUNTED CABINET INCLUDING FOUNDATION AND CONCRETE PAD					
	1	TS 35' MAST ARM TYPE 2, STEEL, INCL. FOUNDATION					
004.00	1	TS POST 8' STANDARD INCL. FOUNDATION					
824.02	4	SIGNAL HEAD, 3-SECTION, 12" LENSES (HAWK DISPLAY)					
	2	PEDESTRIAN SIGNAL HEAD (L.E.D.)					
	2	PEDESTRIAN PUSH BUTTON W/R10-3e(L) AND SIGN SADDLE					
	1	SERVICE CONNECTION (OVERHEAD)					
804.3	65'±	3 INCH ELECTRICAL CONDUIT TYPE NM - PLASTIC - (UL)					

PLUS NECESSARY DUCT, CABLE, LABOR, MISCELLANEOUS MATERIAL AND EQUIPMENT TO COMPLETE THE INSTALLATION AND PROVIDE AN OPERATING PEDESTRIAN HYBRID BEACON.




Watertown, MA 02472

617 924 1770 FAX 617 924 2286

COMMONWEALTH OF MASSACHUSETTS DEPARTMENT OF CONSERVATION AND RECREATION **DIVISION OF PLANNING AND ENGINEERING**

3Y		MASS CENTRAL RAIL TRAIL - WAYSIDE	
	HUDS	MASS CENTRAL RAIL TRAIL ON, STOW, MARLBOROUGH & SUDBUR	Y, MA
	DESIGNER:KEW CHECKED: SHK	TRAFFIC PLANS	SHEET NO.

DESIGNER:KEW	TRAFFIC	DI ANG	SHEET NO.
снескед: SHK	TRAFFIC		
			│ TR-13
DRAWN: KEW	CONT. P19-3295-D1A	SCALE: 1" = 20'-0"	111110
CHECKED: PTN	ACC. XXXXXXX	DATE: JAN 2021	13 OF 14

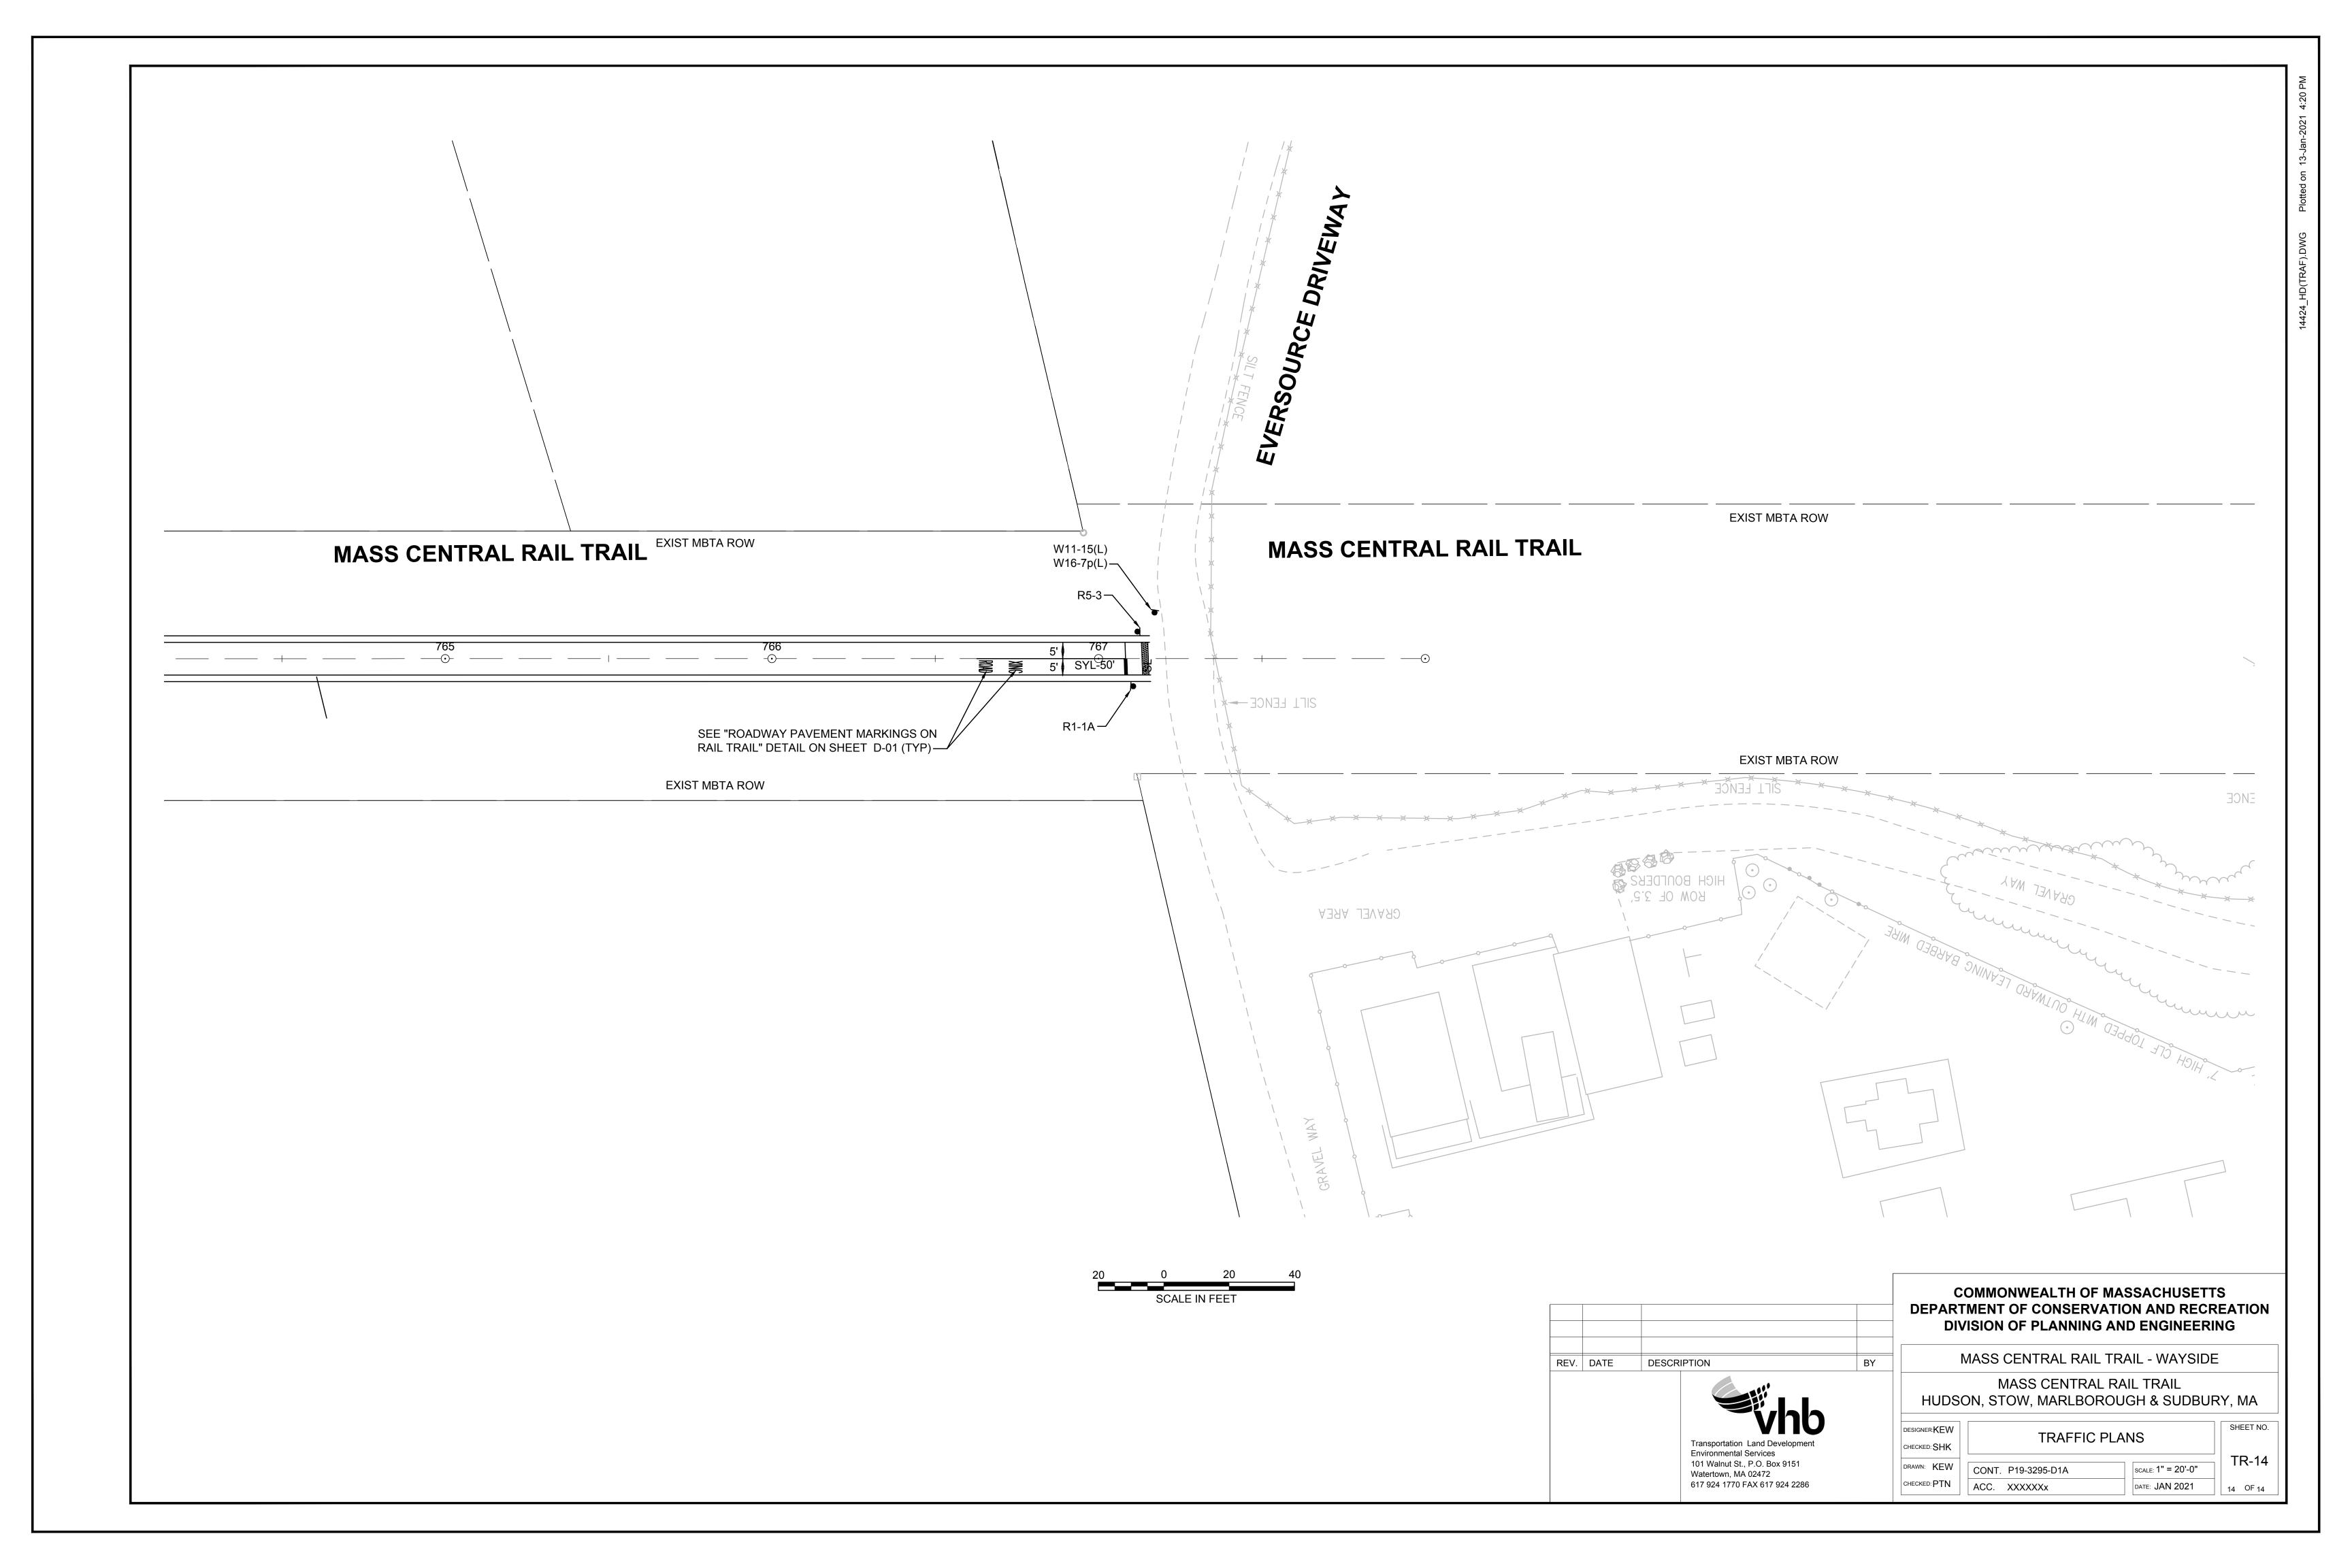

IDENTIFI— CATION	SIZE OF SIGN			F SIGN TEXT DIMENSIONS (INCHES)		(INCHES)	NUMBER OF		COLOR		POST SIZE AND	UNIT AREA	AREA IN
NUMBER	WIDTH	HEIGHT	TEXT	LETTER HEIGHT	VERTICAL SPACING		SIGNS REQUIRED	BACK- GROUND	LEGEND	BORDER	NUMBER REQUIRED	(S.F.)	FEET
R1-1A	18"	18"	STOP	HIG	HWA "STAN HWAY SIG FION"; AS A	SNS,	15	RED	WHITE	WHITE	P5-15	1.86	27.90
R1-1	30"	30"	STOP				2	RED	WHITE	WHITE	P5-2	5.18	10.36
R5-3	24"	24"	NO MOTOR VEHICLES				23	WHITE	BLACK	BLACK	P5-23	4.00	92.00
R10-3e(L)	9"	15"	START CROSSING Wotch For Vehicles DON'T START Finish Crossing If. Storted TIME REMAINING To Finish Crossing DON'T CROSS PUSH BUTTON TO CROSS				4	WHITE	WHITE/ BLACK/ ORANGE	BLACK	4 MTD ON TS POST	UNI	UDED DER 824.01 24.02
A-R10-23a	30"	36"	CROSSWALK STOP ON RED PROCEED ON FLASHING RED WHEN CLEAR		PER MASS STANDARI		4	YELLOW/ WHITE	BLACK	BLACK	4 MTD ON MAST ARM	7.50	30.0
R10-25	12"	9"	PUSH BUTTON TO TURN ON WARNING LIGHTS	HIG	HWA "STAN HWAY SIG FION"; AS A	SNS,	4	WHITE	BLACK	BLACK	4 MTD ON TS POLE	UNI ITEMS	UDED DER 824.111 4.112
W11-15(L)	30"	30"	To To				41	YELLOW	BLACK	BLACK	4 MTD ON TS POST P5-37	6.25	256.25
W11-15(R)	30"	30"	T.				4	YELLOW	BLACK	BLACK	4 MTD ON TS POST	6.25	25.00
W16-7p(L)	24"	12"					21	YELLOW	BLACK	BLACK	4 MTD ON TS MOST 17 MTD WITH OTHERS	2.00	42.0
W16-7p(R)	24"	12"					4	YELLOW	BLACK	BLACK	4 MTD ON TS POST	2.00	8.00
W16-9p	24"	12"	AHEAD		V		18	YELLOW	BLACK	BLACK	18 MTD WITH OTHERS	2.00	36.00
SP-1	9"	12"	WAIT FOR VEHICLES TO STOP BEFORE CROSSING	1"C 1"C 1"C 1"C	1.5" 1" 1" 1" 1"	N/A	4	YELLOW	BLACK	BLACK	4 MTD ON TS POST	UNI ITEMS	UDED DER 824.111 4.112

1.5"

TRAFFIC SIGN SUMMARY													
IDENTIFI—	SIZE O	F SIGN		TEXT DI	MENSIONS	(INCHES)	NUMBER OF		COLOR		POST SIZE AND	UNIT	AREA IN
CATION NUMBER	WIDTH	HEIGHT	TEXT	LETTER HEIGHT	VERTICAL SPACING	ARROW RTE. MKR.	SIGNS REQUIRED	BACK- GROUND	LEGEND	BORDER	NUMBER REQUIRED	AREA (S.F.)	SQUARE FEET
MA-D3-1A	VARIES	12"	Wilkins St 6" HUDSON TOWN SEAL	6"D/4.5"D	3" 3"	N/A	1	GREEN	WHITE	WHITE	1 MTD WITH OTHERS		D UNDER 1 874
MA-D3-1B	VARIES	12"	Main st - 6" HUDSON TOWN SEAL	6"D/4.5"D	5" 5"	N/A	1	GREEN	WHITE	WHITE	1 MTD ON TS POLE		D UNDER 1 874
MA-D3-1C	VARIES	12"	Parmenter Rd - 6" HUDSON TOWN SEAL	6"D/4.5"D	3" 3"	N/A	1	GREEN	WHITE	WHITE	1 MTD WITH OTHERS		D UNDER 1874
MA-D3-1D	VARIES	12"	White Pond Rd - 6" HUDSON TOWN SEAL	6"D/4.5"D	3" 3"	N/A	1	GREEN	WHITE	WHITE	1 MTD WITH OTHERS		D UNDER 1 874
MA-D3-1E	VARIES	12"	Dutton Rd - 6" SUDBURY TOWN SEAL	6"D/4.5"D	3" 3"	N/A	1	GREEN	WHITE	WHITE	1 MTD WITH OTHERS		D UNDER 1 874
MA-D3-1F	VARIES	12"	Peakham Rd - 6" SUDBURY TOWN SEAL	6"D/4.5"D	3" 3"	N/A	1	GREEN	WHITE	WHITE	1 MTD WITH OTHERS		D UNDER 1 874
MA-D3-1G	VARIES	12"	Horse Pond Rd - 6" SUDBURY TOWN SEAL	6"D/4.5"D	3" 3"	N/A	1	GREEN	WHITE	WHITE	1 MTD WITH OTHERS		D UNDER 1874
MA-D3-1H	VARIES	12"	Union Ave 6" SUDBURY TOWN SEAL	6"D/4.5"D	3" 3"	N/A	1	GREEN	WHITE	WHITE	1 MTD WITH OTHERS		D UNDER 1874
MA-D3-1J	VARIES	12"	Boston Post Rd - 6" SUDBURY TOWN SEAL	6"D/4.5"D	5" 5"	N/A	1	GREEN	WHITE	WHITE	1 MTD ON TS POLE		D UNDER 1874


NOTES: 1. HIGH INTENSITY REFLECTIVE SHEETING SHALL BE USED FOR ALL SIGNS. SEE FHWA "STANDARD HIGHWAY SIGNS, 2004 EDITION" FOR TEXT DIMENSIONS, AS AMENDED; THE 1977 MASSHIGHWAY DEPARTMENT CONSTRUCTION AND TRAFFIC STANDARD DETAILS, AS AMENDED, FOR SIGNS AND SUPPORTS; AND THE MASSHIGHWAY DEPARTMENT SIGN LISTINGS 1993 EDITION, AS AMENDED.


REV. DATE DESCRIPTION BY Transportation Land Development Environmental Services
101 Walnut St., P.O. Box 9151 Watertown, MA 02472 617 924 1770 FAX 617 924 2286


COMMONWEALTH OF MASSACHUSETTS DEPARTMENT OF CONSERVATION AND RECREATION DIVISION OF PLANNING AND ENGINEERING

MASS CENTRAL RAIL TRAIL - WAYSIDE MASS CENTRAL RAIL TRAIL HUDSON, STOW, MARLBOROUGH & SUDBURY, MA

DESIGNER:JCR	TRAFFIC SIGN	SHEET NO.	
			SS-01
DRAWN: JCR	CONT. P19-3295-D1A	SCALE: NTS	
CHECKED: TAL	ACC. XXXXXXX	DATE: JAN 2021	1 OF 1

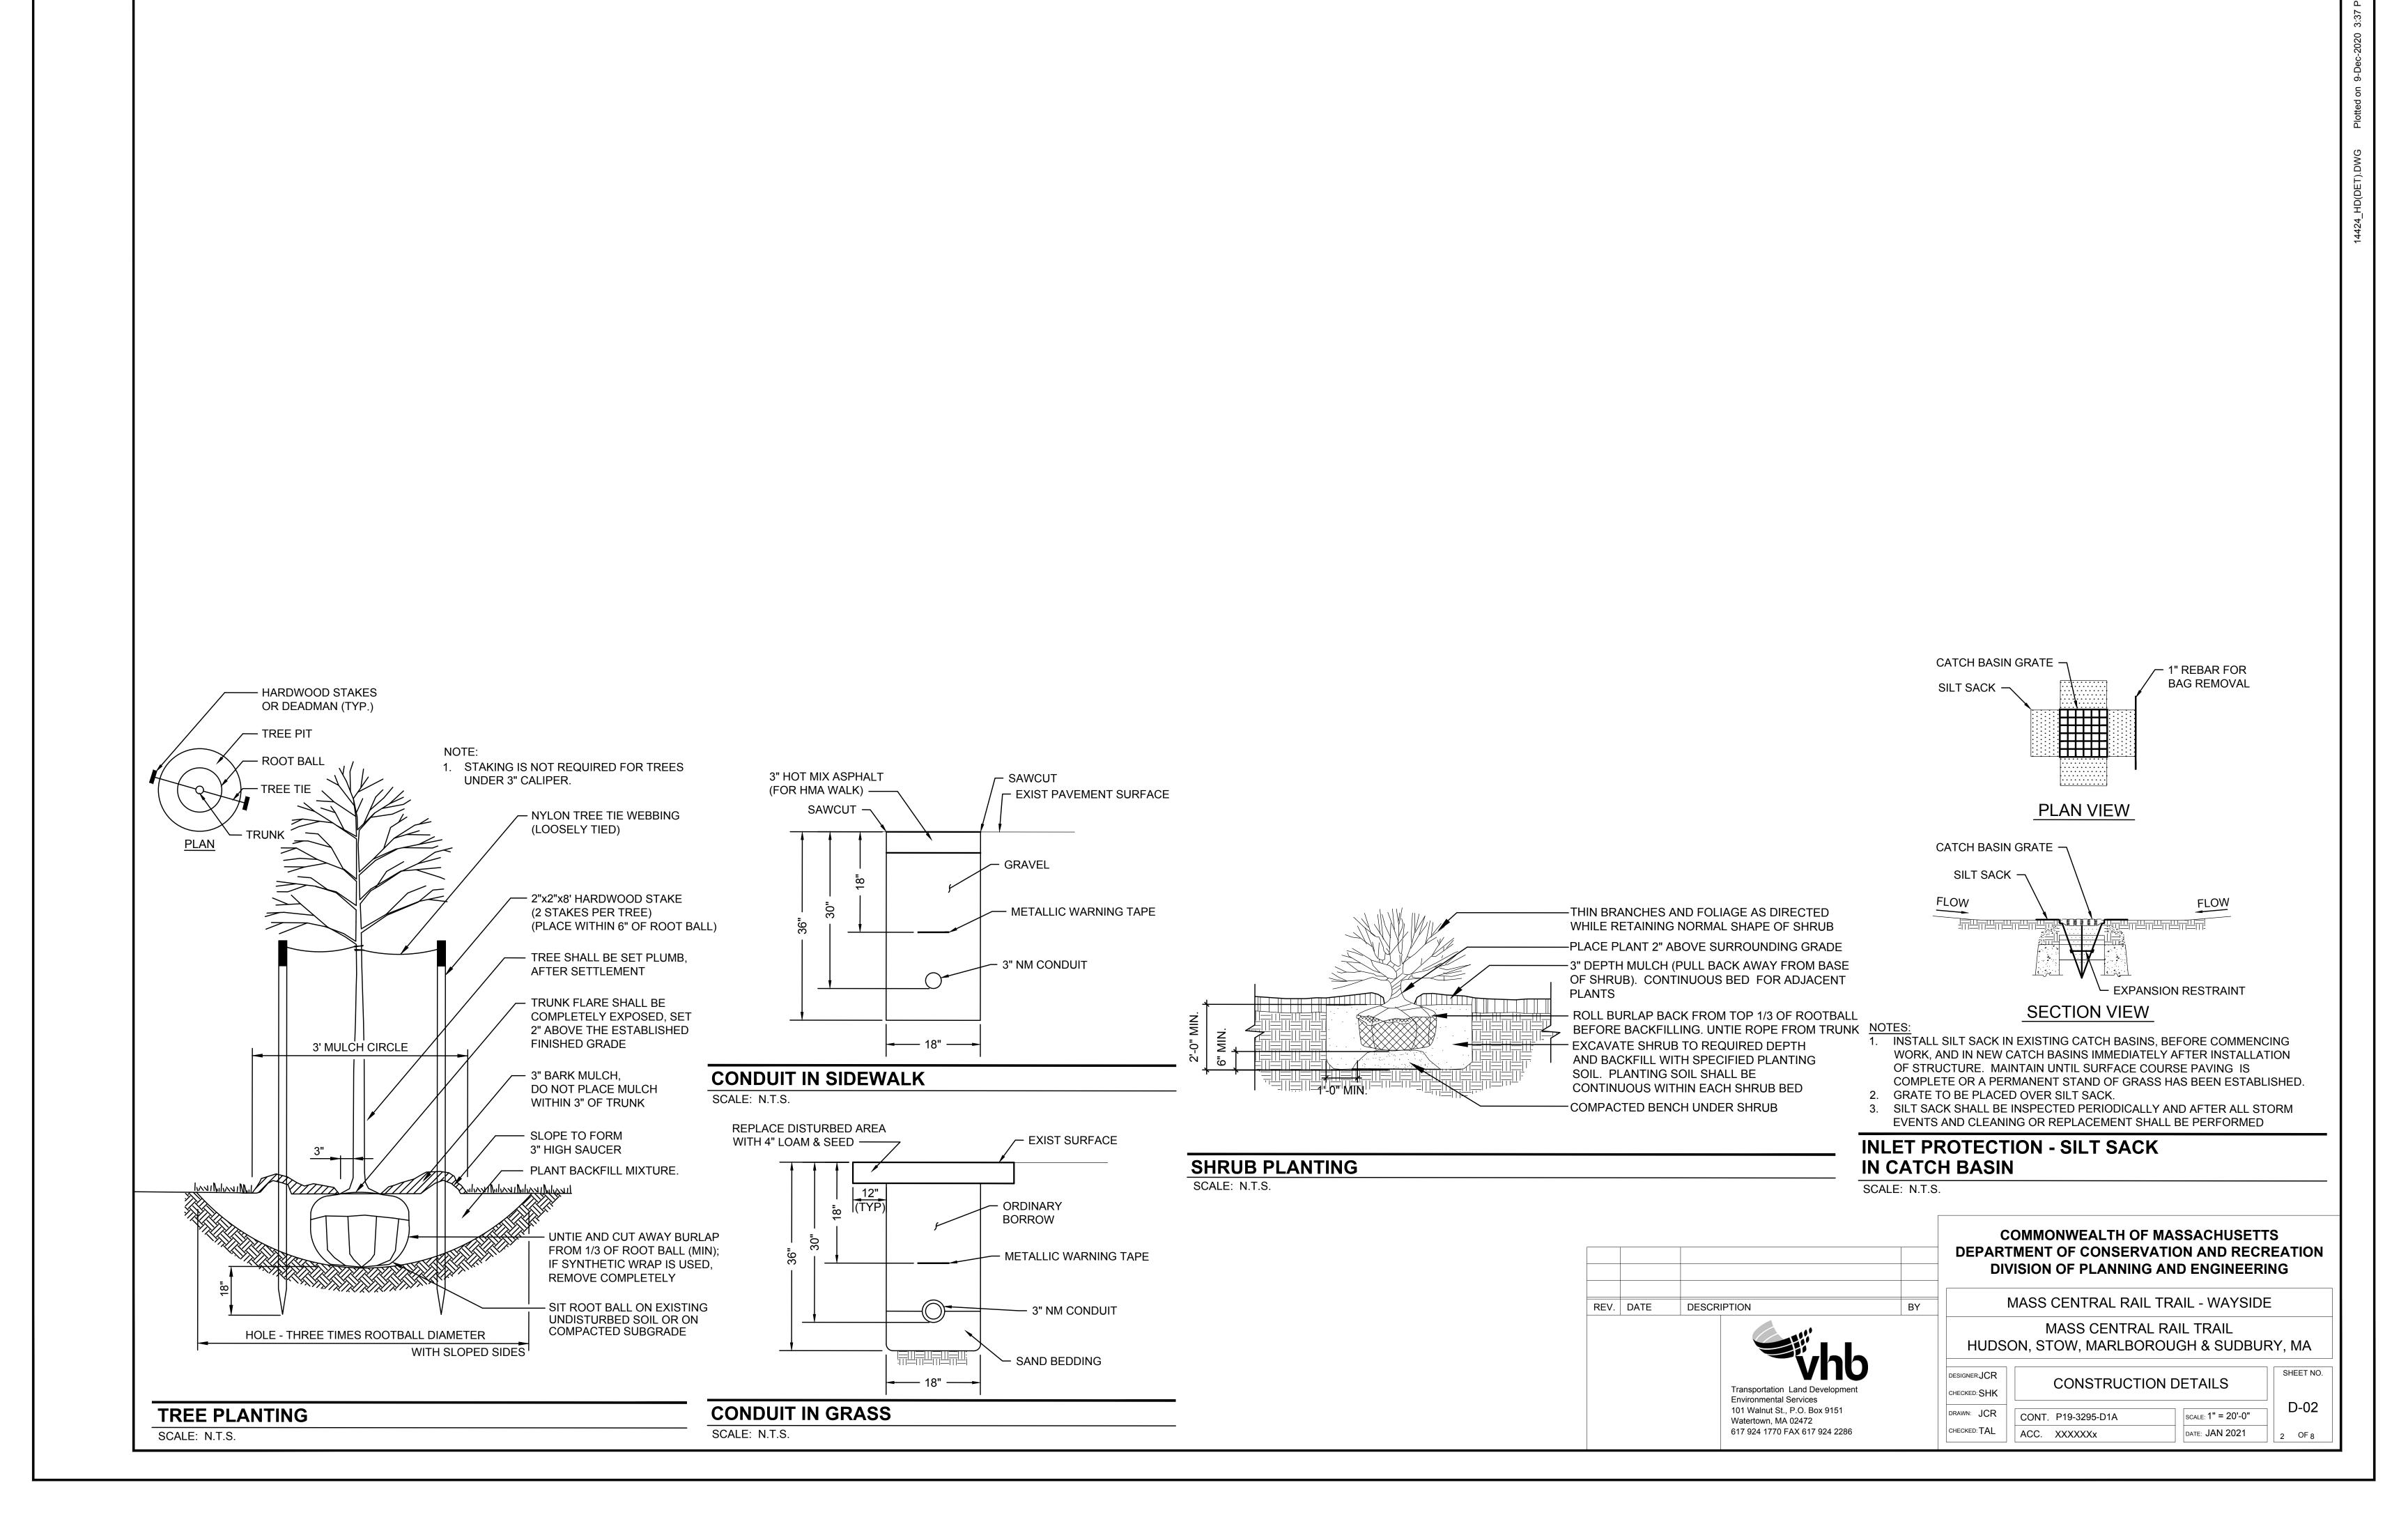


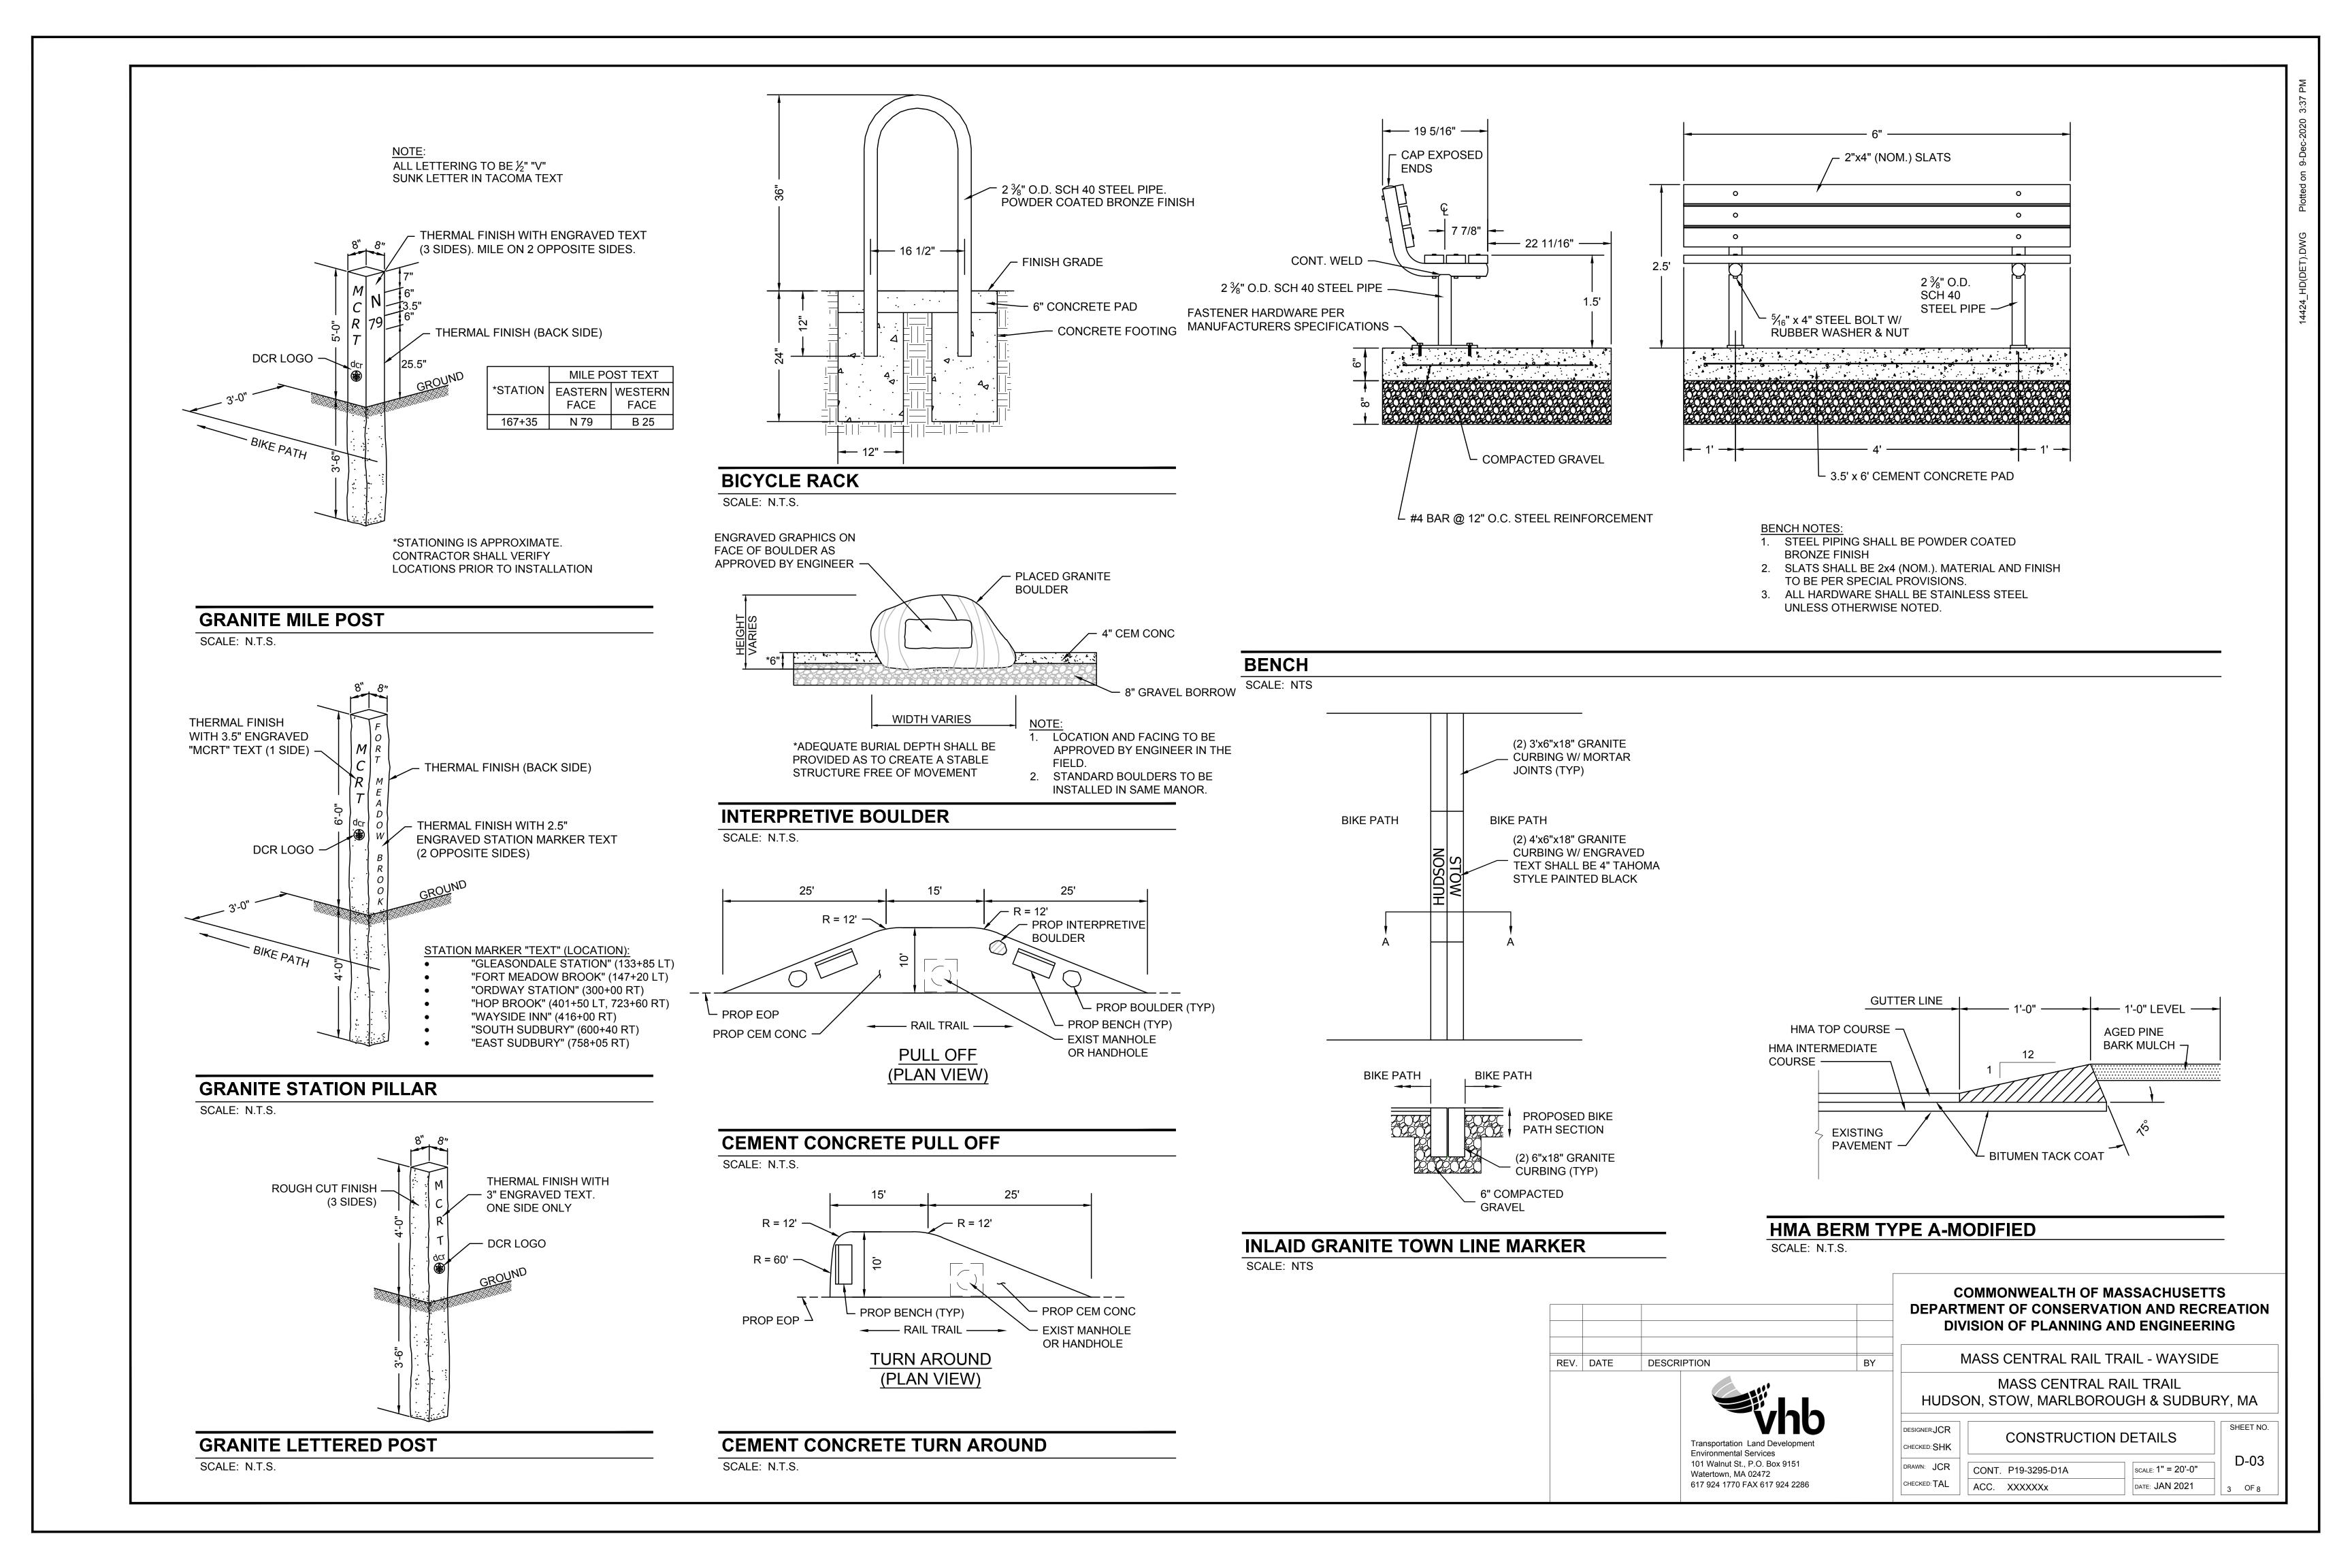

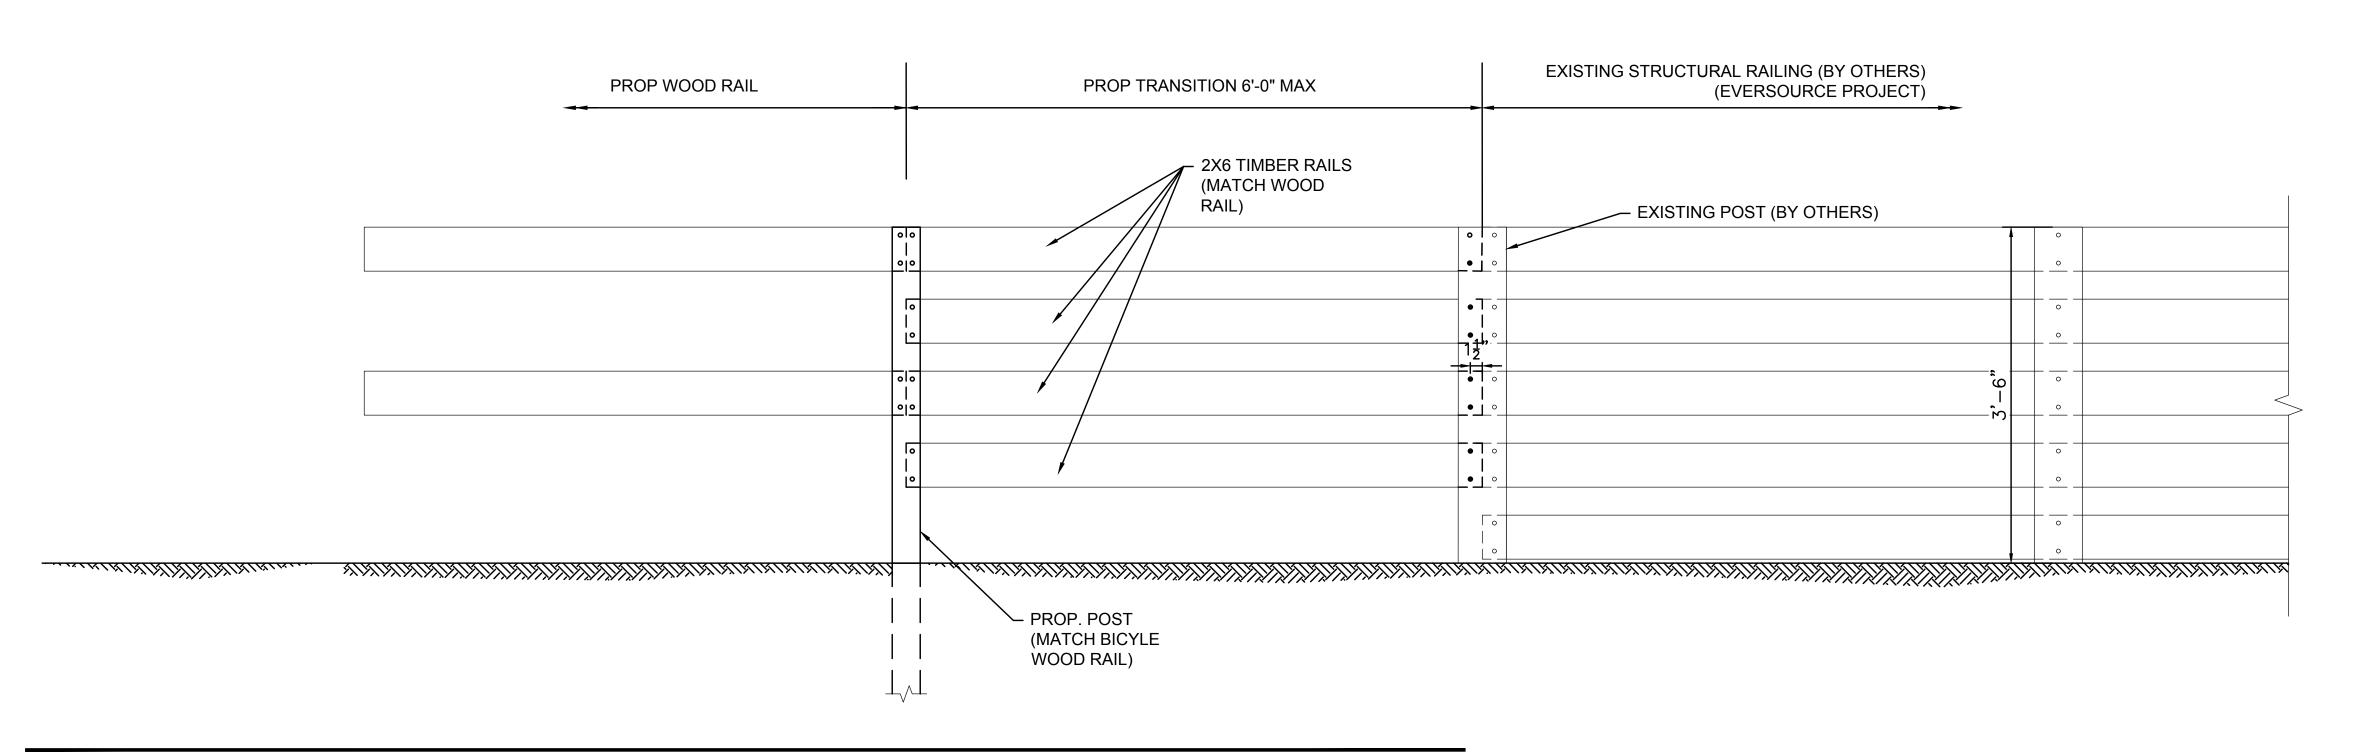

WOOD RAIL TRANSITION DETAIL AT EXISTING STRUCTURAL RAILING

SCALE: NTS

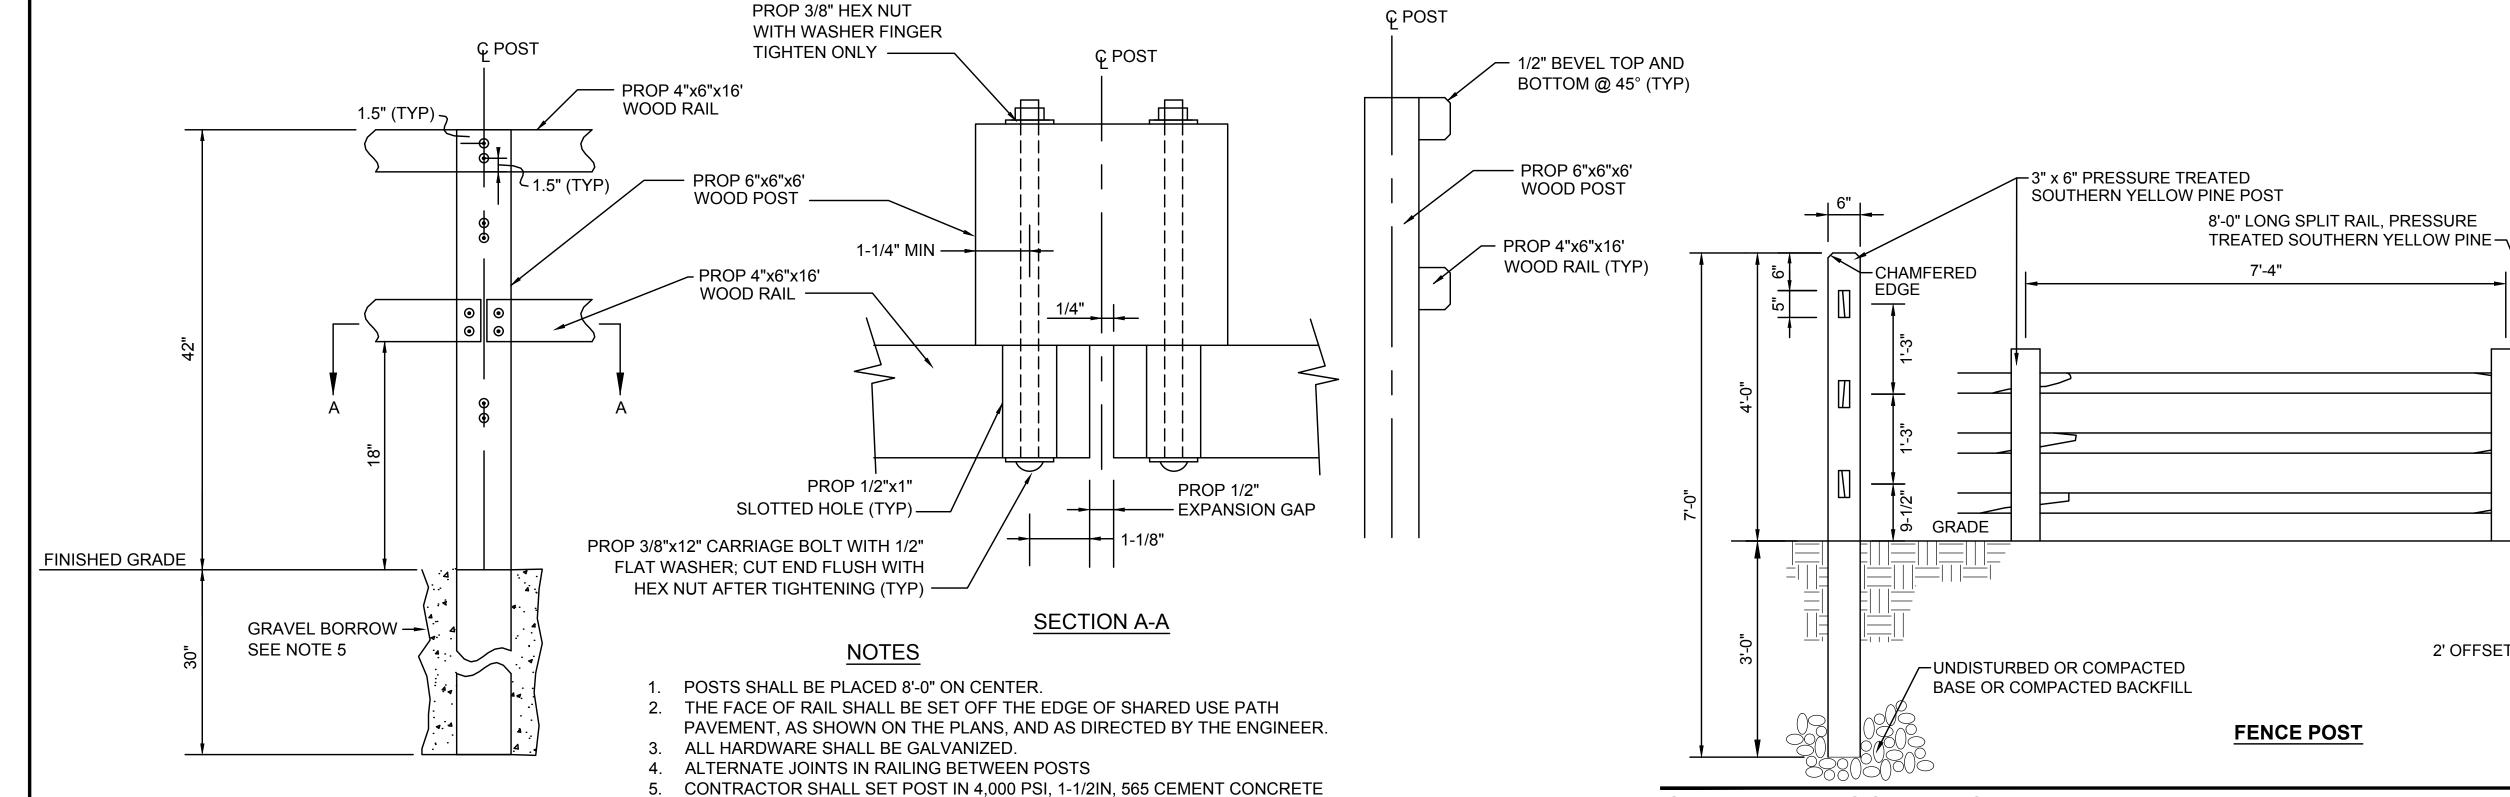

FIRST AND LAST SECTION OF A LINE OF SPLIT RAIL FENCE SHALL BEGIN/END WITH A 2' OFFSET TAPER, EXCEPT WHERE FENCE CONNECTS TO OTHER FENCING.

PATH ——


PLAN

SPLIT RAIL WOOD FENCE

SCALE: NTS

WOOD RAIL - ELEVATION AND SECTION VIEWS

SCALE: NTS

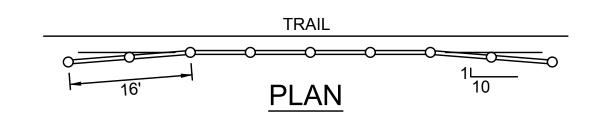

FOR ALL POSTS UNABLE TO BE SET AT REQUIRED DEPTH.

6. BOLTS SHALL BE SIZED AND INSTALLED SO THAT THEY EXTEND NO MORE

THAN ONE ADDITIONAL NUT LENGTH BEYOND THE SECURED SURFACE.

WOOD RAIL TERMINAL END - PLAN VIEW


SCALE: NTS



COMMONWEALTH OF MASSACHUSETTS DEPARTMENT OF CONSERVATION AND RECREATION **DIVISION OF PLANNING AND ENGINEERING**

,	N	MASS CENTRAL RAIL TRAIL - WAYSIDE	<u> </u>
	HUDSO	MASS CENTRAL RAIL TRAIL ON, STOW, MARLBOROUGH & SUDBUF	RY, MA
	DESIGNER:JCR	CONSTRUCTION DETAILS	SHEET NO.

SIGNER:JCR	CONSTRUCTION	SHEET NO.	
HECKED: SHK	CONSTRUCTION		
RAWN: JCR	CONT. P19-3295-D1A	SCALE: 1" = 20'-0"	D-04
HECKED: TAL	ACC. XXXXXXX	DATE: JAN 2021	4 OF 8

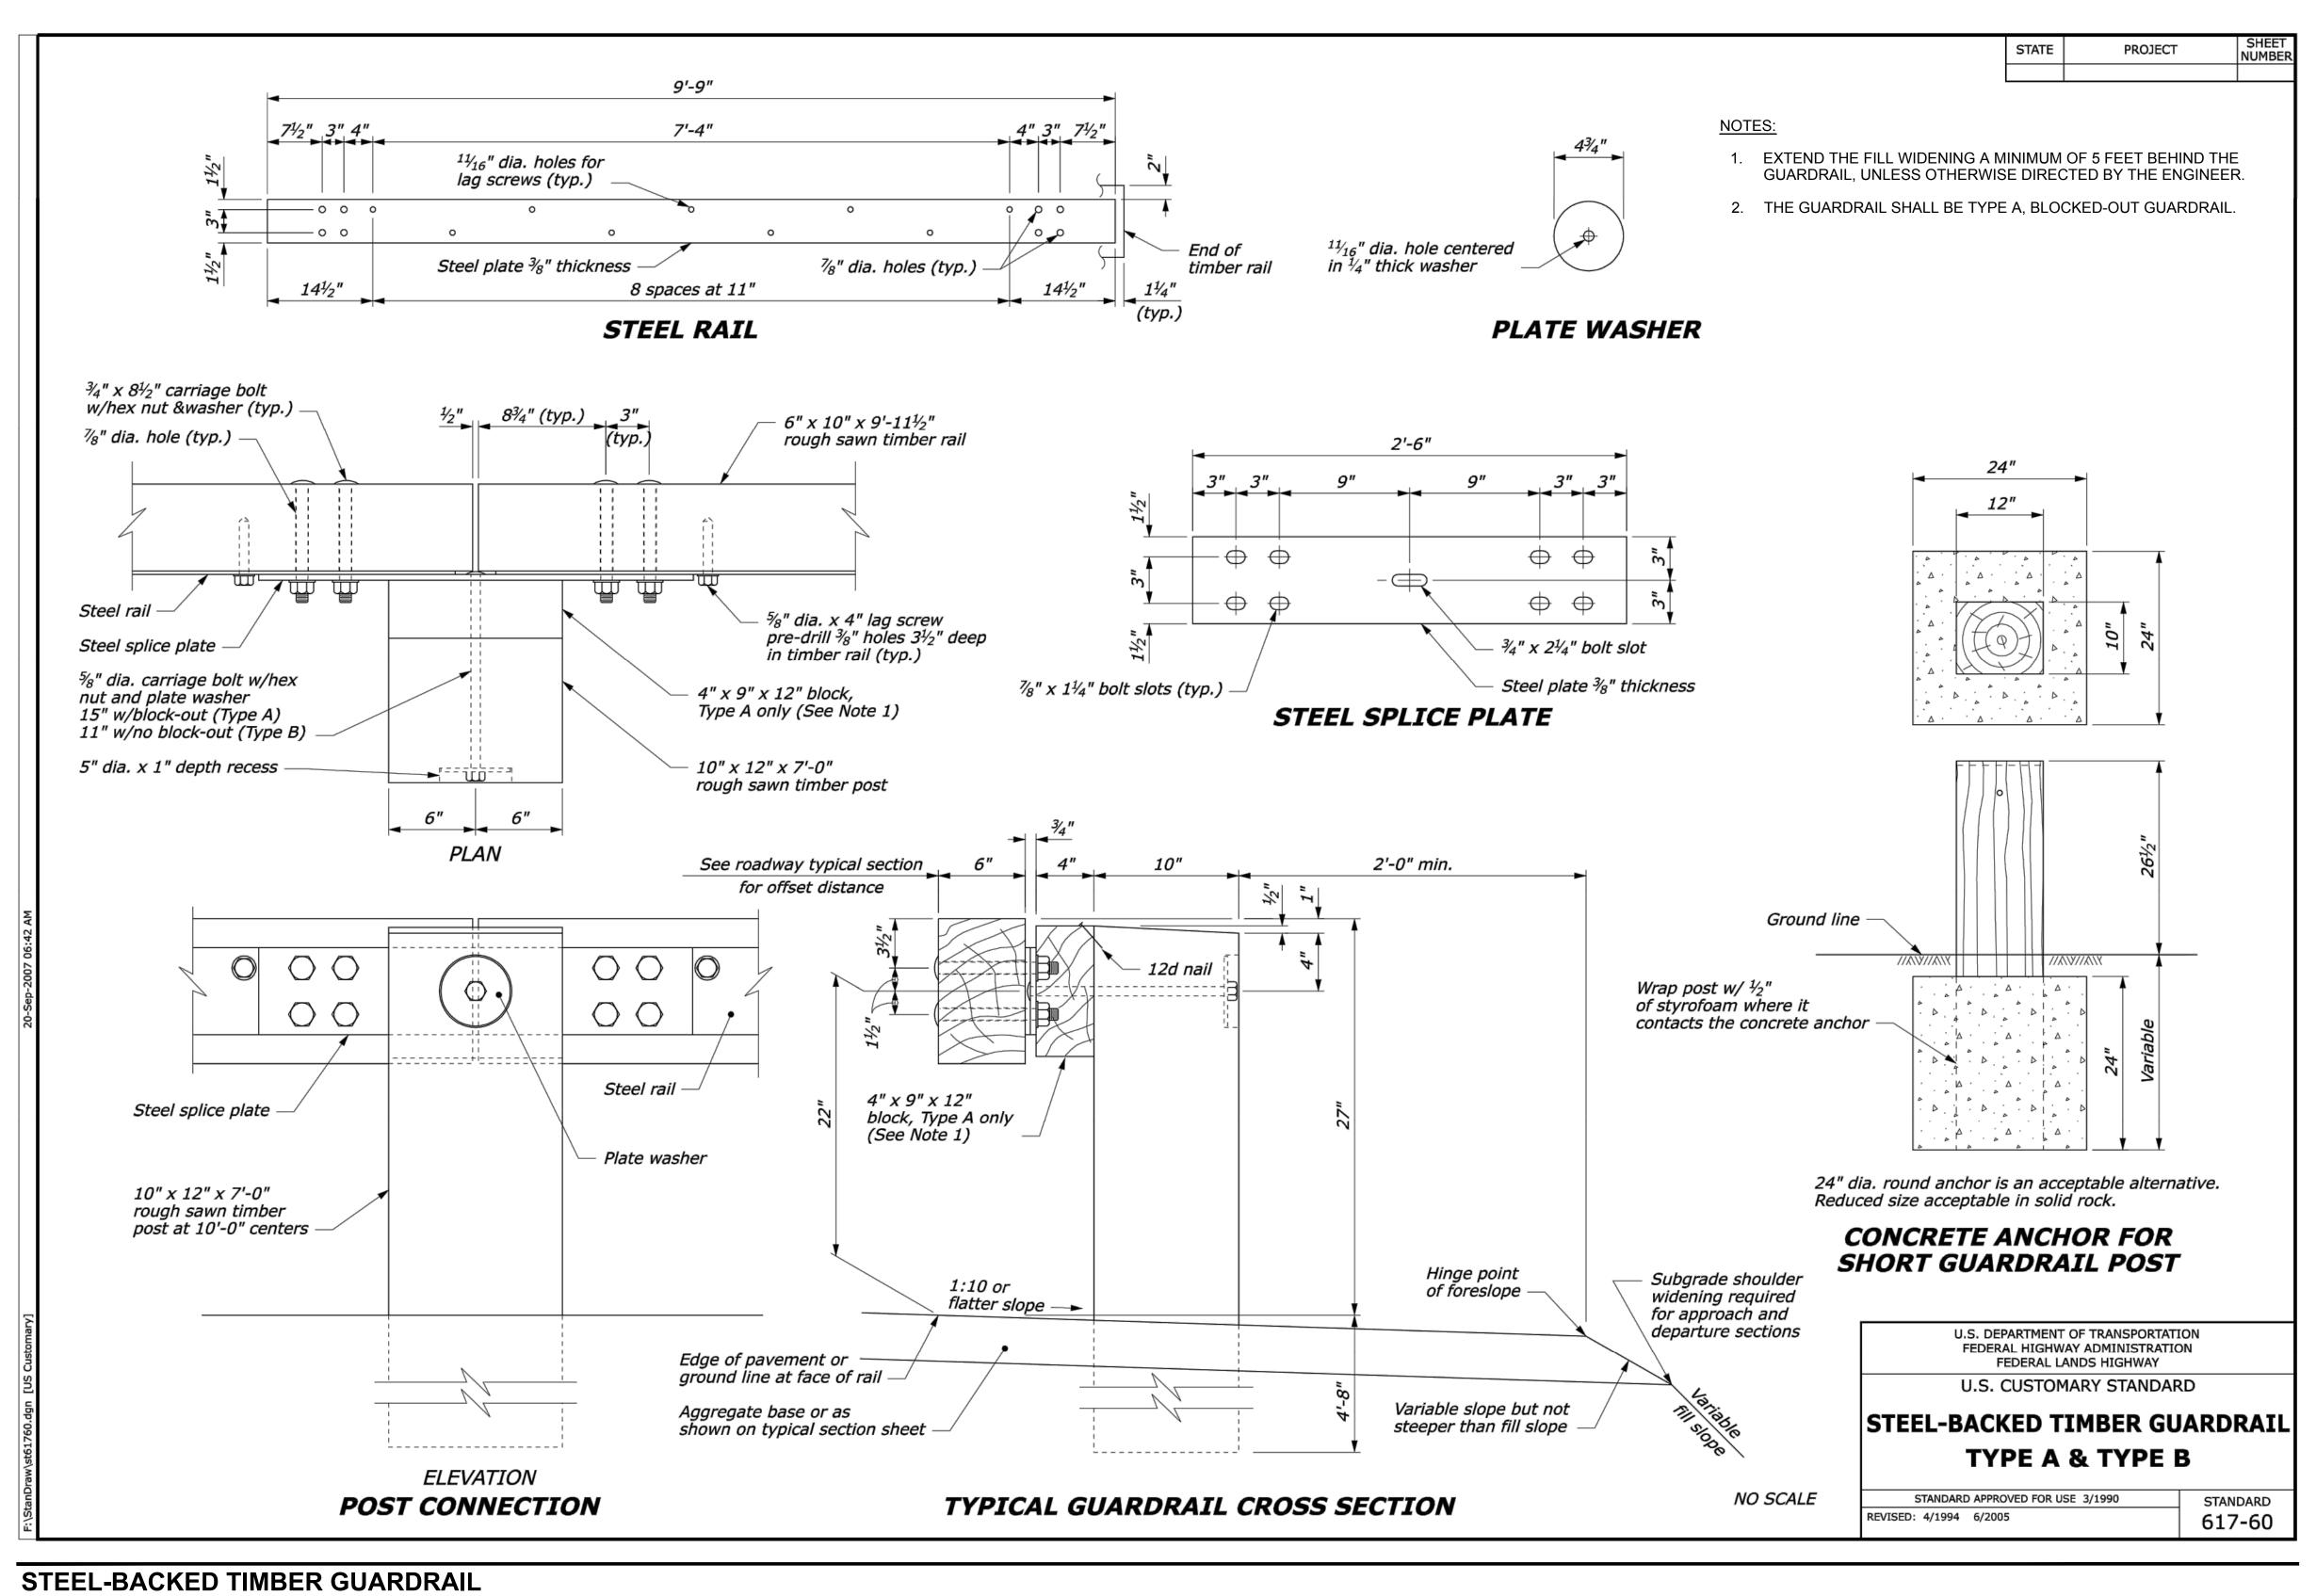

SCALE: NTS




COMMONWEALTH OF MASSACHUSETTS
DEPARTMENT OF CONSERVATION AND RECREATION
DIVISION OF PLANNING AND ENGINEERING

MASS CENTRAL RAIL TRAIL - WAYSIDE

MASS CENTRAL RAIL TRAIL
HUDSON, STOW, MARLBOROUGH & SUDBURY, MA

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CHECKED: TAL	ACC. XXXXXXX	DATE: JAN 2021	5 OF 8

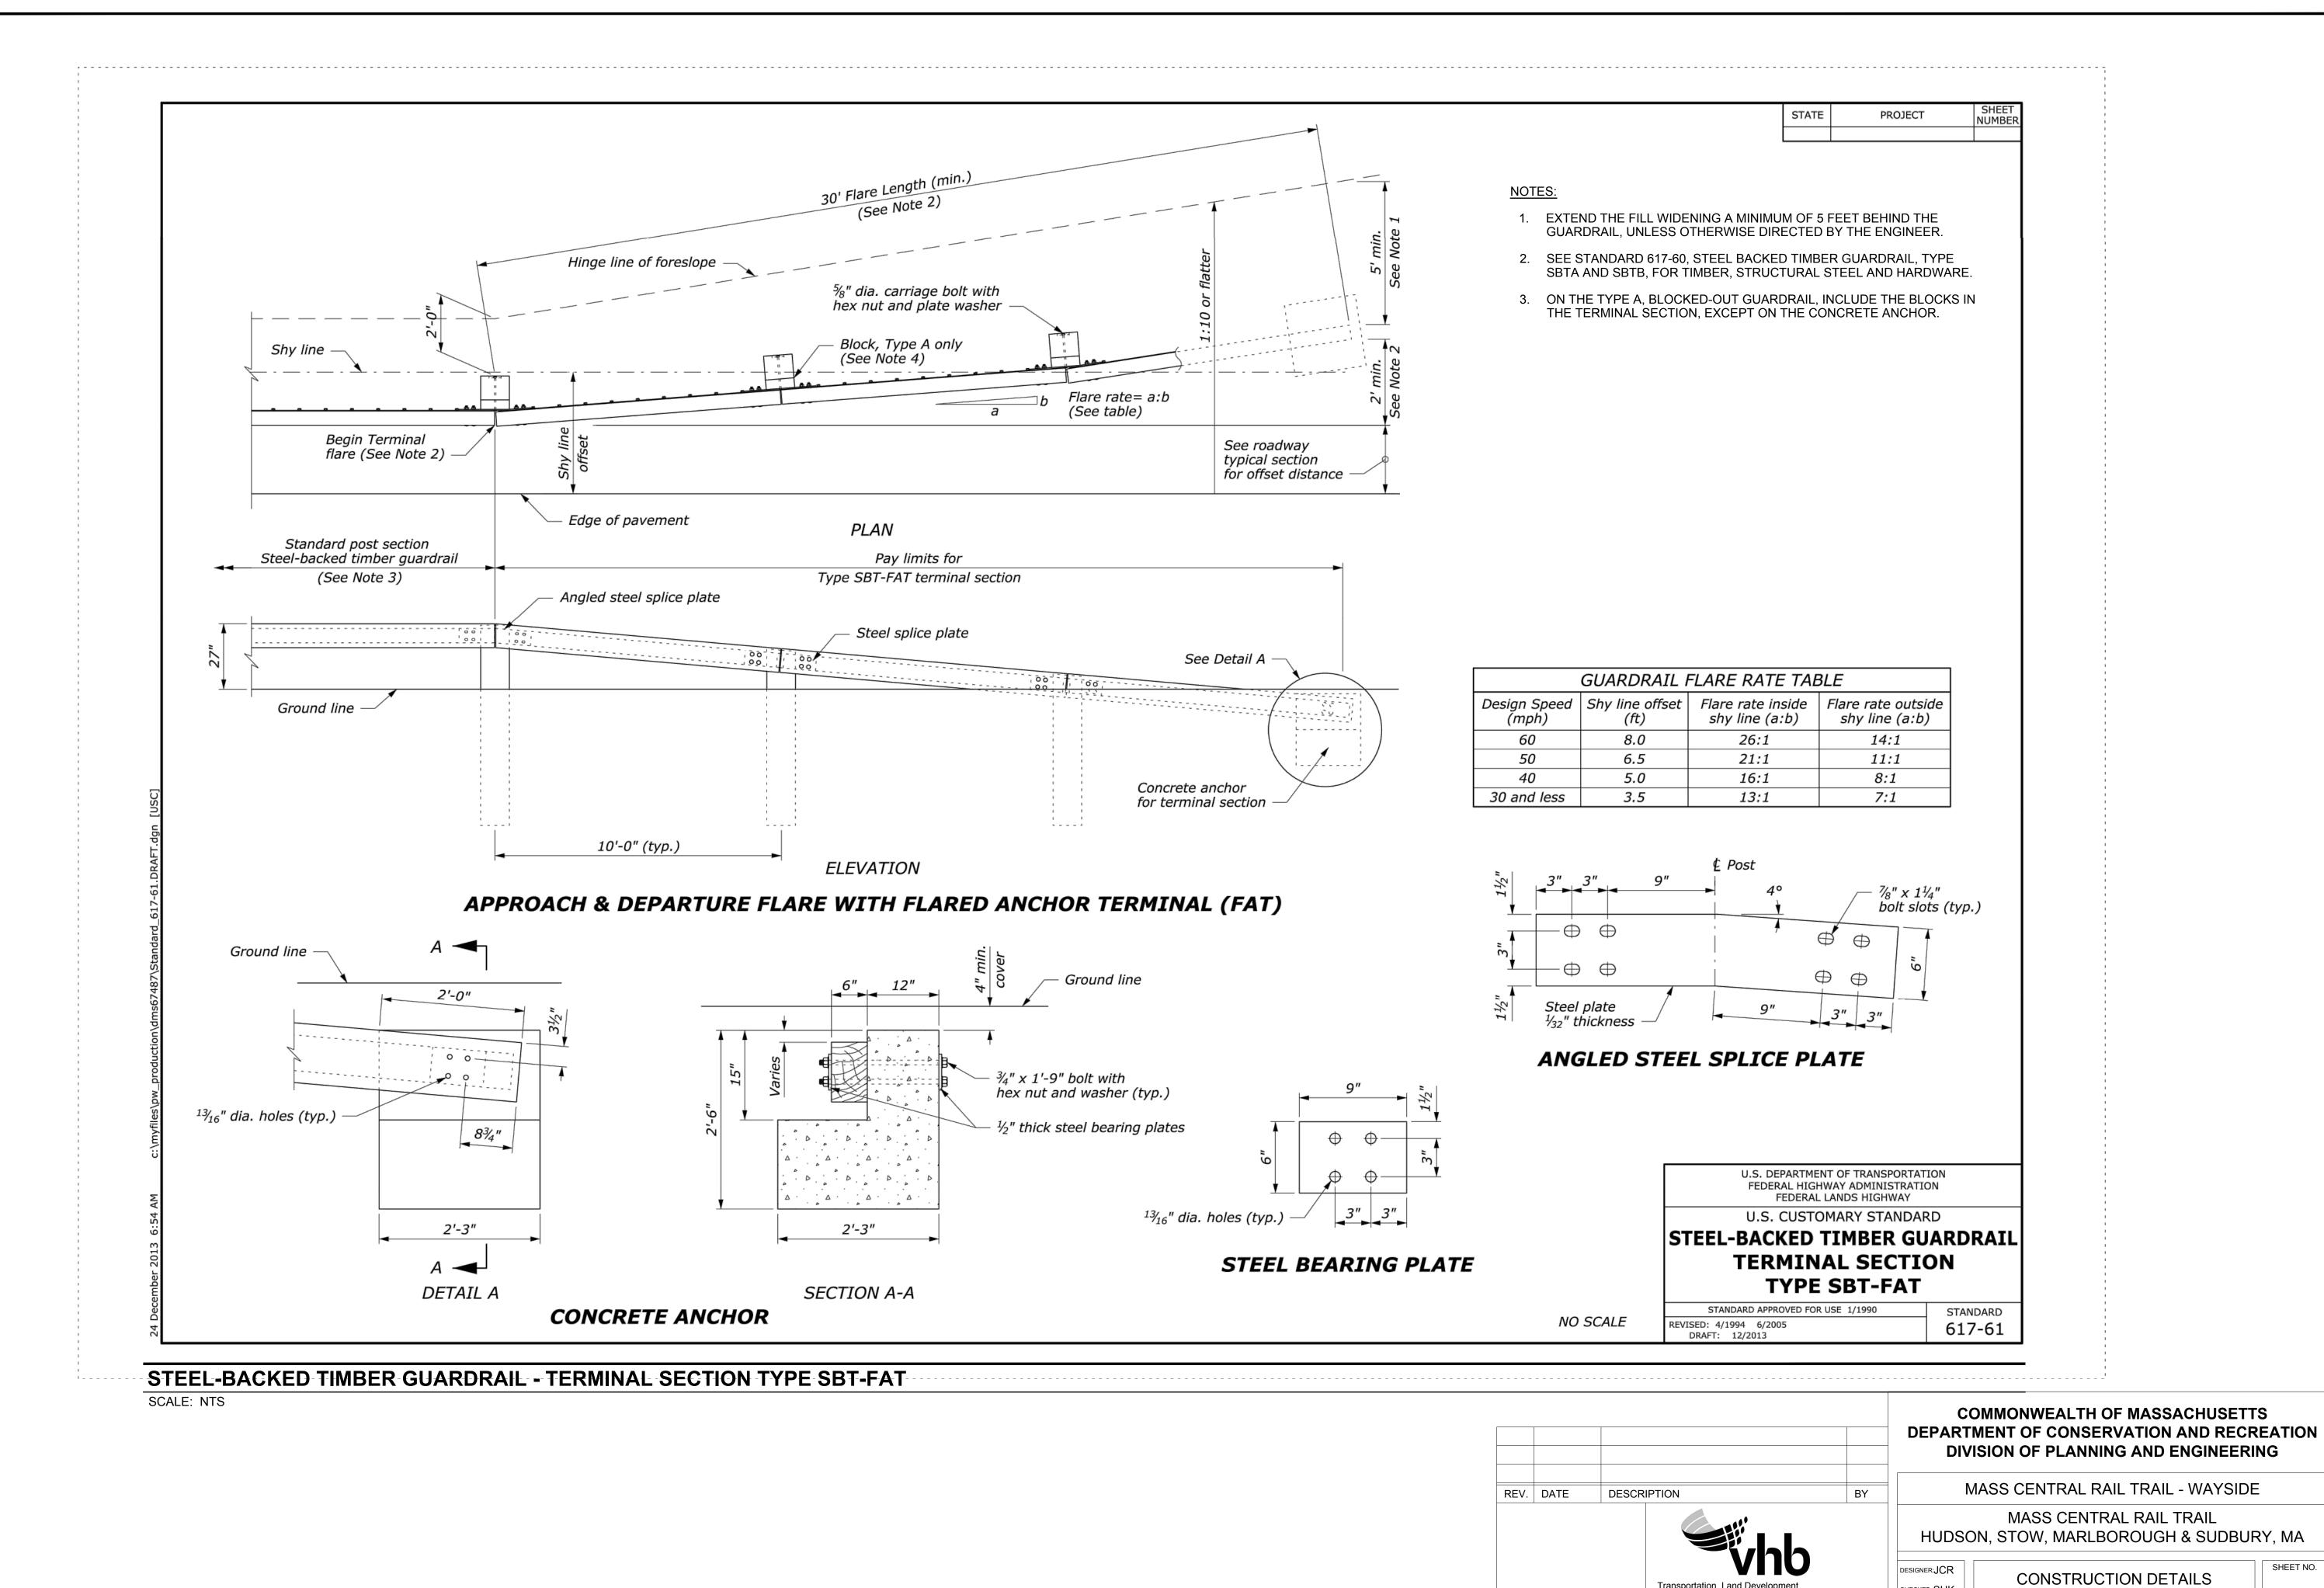

SHEET NO.

6 OF 8

SCALE: 1" = 20'-0"

DATE: **JAN 2021**

Transportation Land Development

617 924 1770 FAX 617 924 2286

Environmental Services 101 Walnut St., P.O. Box 9151


Watertown, MA 02472

CHECKED: SHK

DRAWN: JCR


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ACC. XXXXXXX

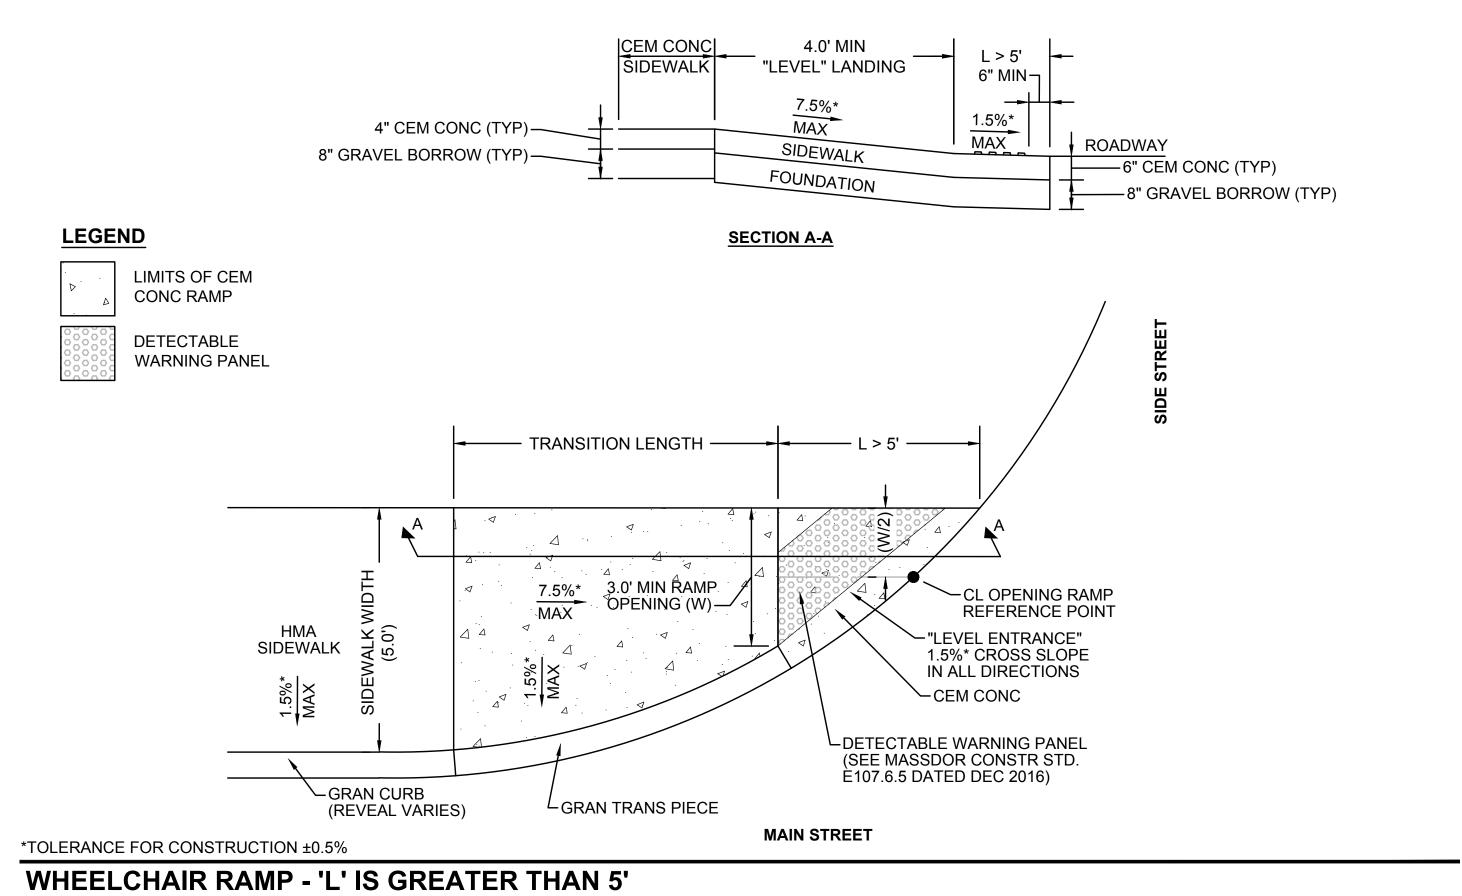

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SCALE: NTS




REV. DATE DESCRIPTION BY Transportation Land Development Environmental Services 101 Walnut St., P.O. Box 9151 Watertown, MA 02472 617 924 1770 FAX 617 924 2286

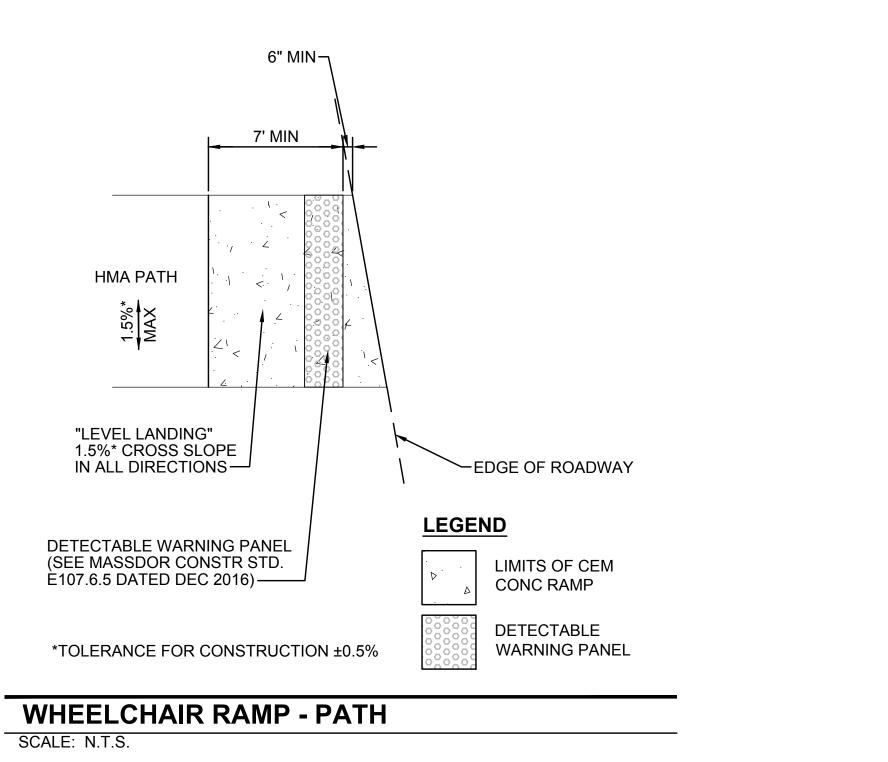COMMONWEALTH OF MASSACHUSETTS
DEPARTMENT OF CONSERVATION AND RECREATION
DIVISION OF PLANNING AND ENGINEERING


BY	ľ	MASS CENTRAL RAIL TRAIL - WAYSIDE	•
	HUDSO	MASS CENTRAL RAIL TRAIL ON, STOW, MARLBOROUGH & SUDBUR	RY, MA
	DESIGNER:JCR CHECKED:SHK	CONSTRUCTION DETAILS	SHEET NO.

DESIGNER:JCR	CONSTRUCTION	N DETAILS	SHEET NO.
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	,		D-07
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CHECKED: TAL	ACC. XXXXXXX	DATE: JAN 2021	7 OF 8

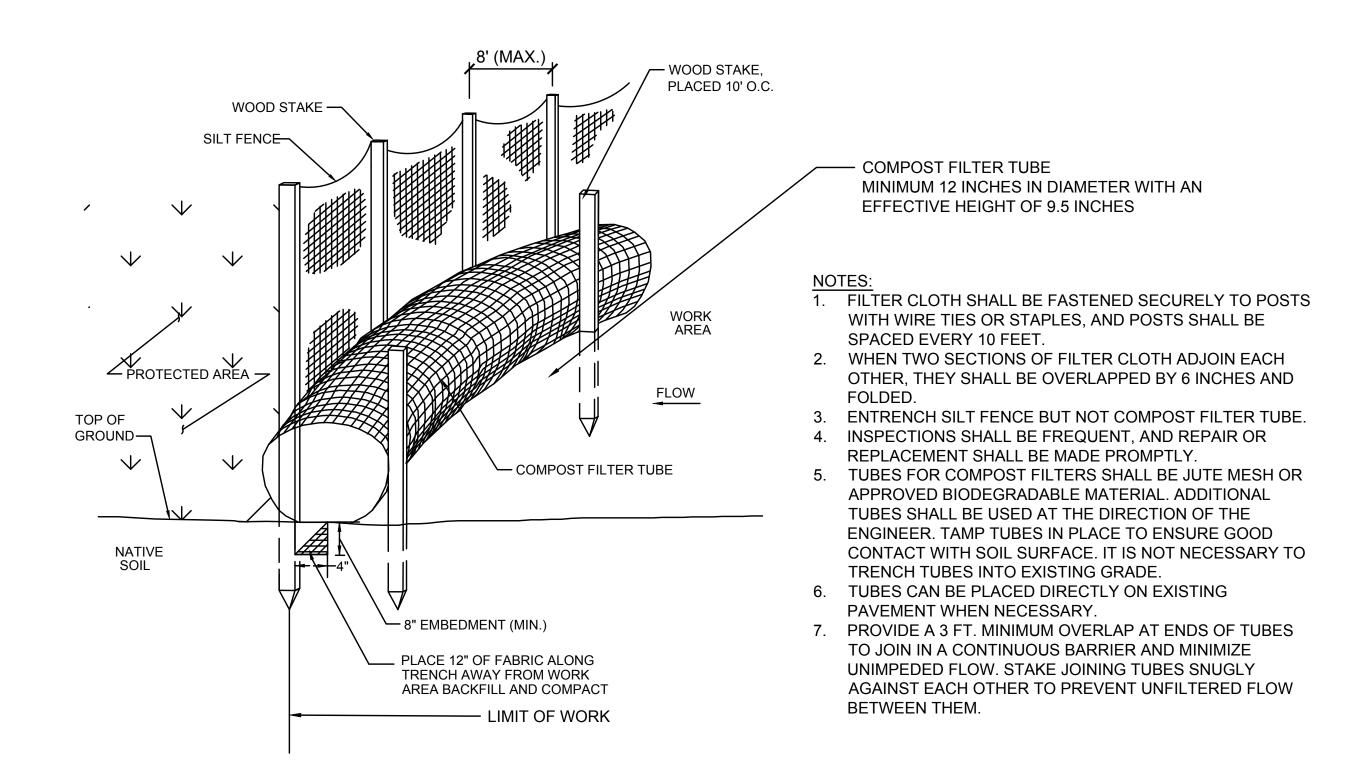

COMPOST FILTER TUBE AND SILT FENCE DETAIL - TYPE A EROSION CONTROL BARRIER

SCALE: NTS

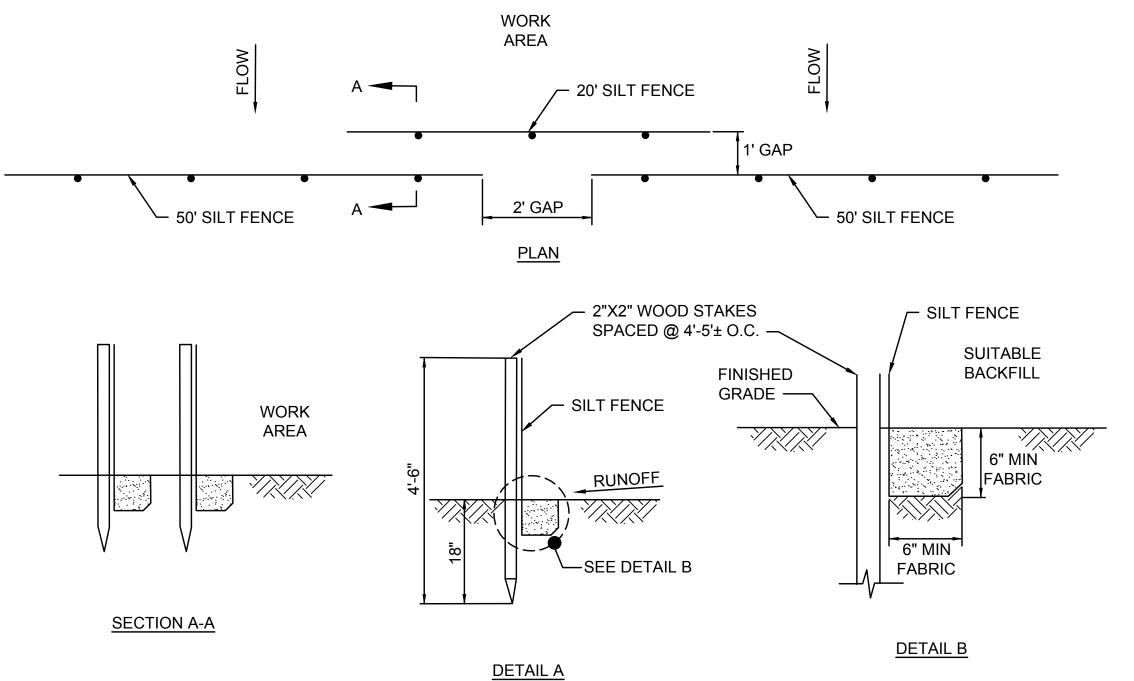


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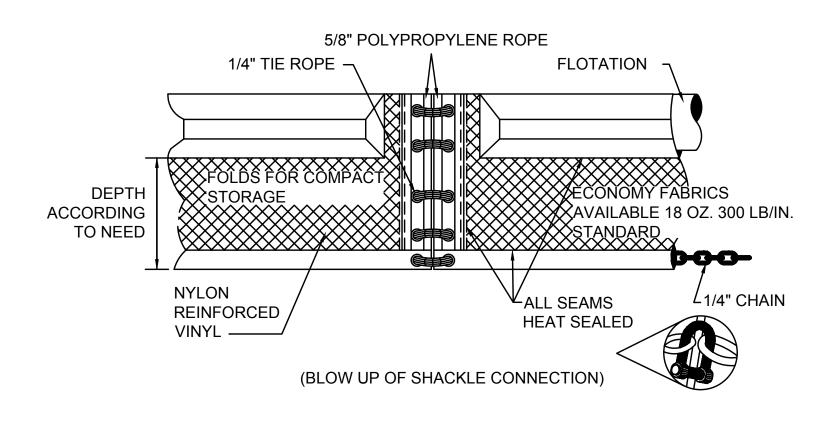
- . SYNCOPATED SILT FENCE SHALL BE USED WITHIN ALL PRIORITY HABITAT AREAS AND WITHIN 450' OF VERNAL POOLS.
- 2. INSTALL GAP AFTER EVERY 50' OF EROSION CONTROL BARRIER.

SYNCOPATED SILT FENCE DETAIL - TYPE B EROSION CONTROL BARRIER

SCALE: N.T.S.

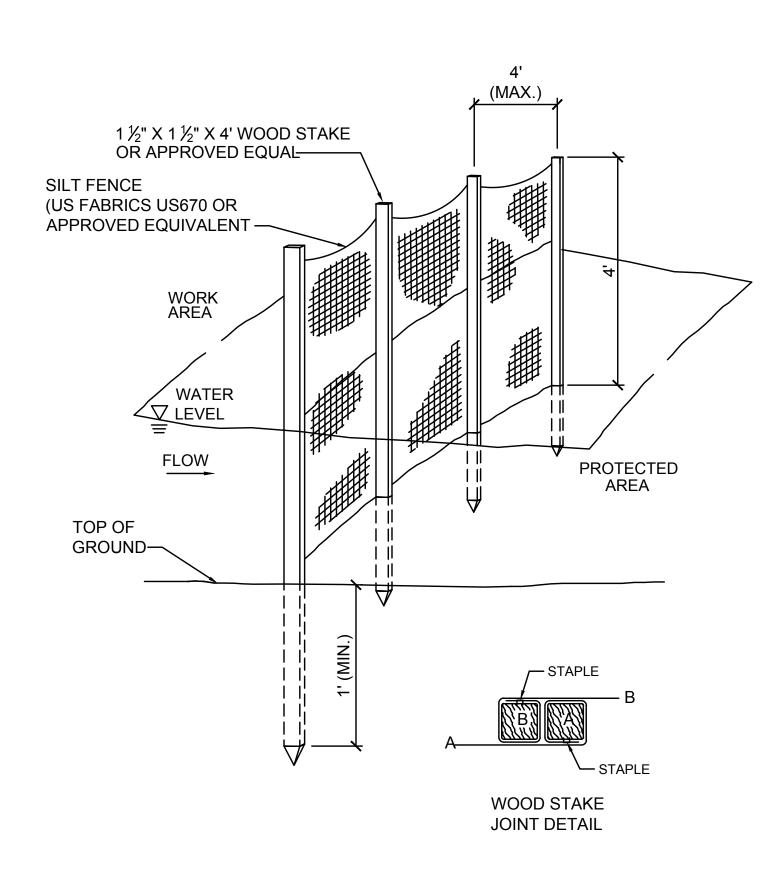

4' HIGH SILT FENCE BARRIER DETAIL - EROSION CONTROL BARRIER TYPE C (OPTION 1) SCALE: N.T.S.




TURBIDITY CURTAIN DETAIL - EROSION CONTROL BARRIER TYPE C (OPTION 2) SCALE: N.T.S.




COMMONWEALTH OF MASSACHUSETTS DEPARTMENT OF CONSERVATION AND RECREATION DIVISION OF PLANNING AND ENGINEERING

Y		MASS CENTRAL RAIL TRAIL - WAYSI	DE				
	MASS CENTRAL RAIL TRAIL HUDSON, STOW, MARLBOROUGH & SUDBURY, MA						
	DESIGNER:JCR CHECKED: SHK	CONSTRUCTION DETAILS SHEET NO.					
	DRAWN: JCR	CONT. P19-3295-D1A scale: 1" = 20'-0"	D-08				
	CHECKED: TAL	ACC XXXXXXX DATE: JAN 2021	l e OF e				

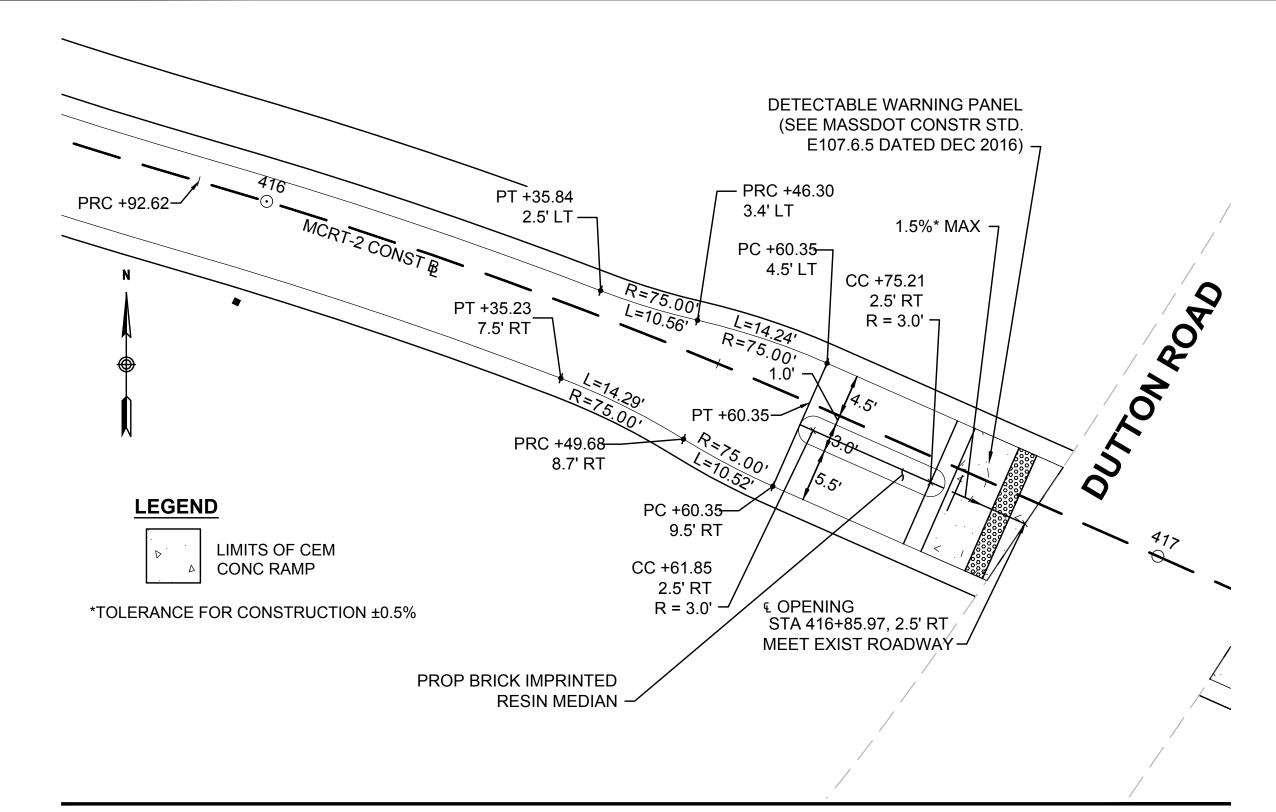


GATEWAY 9 - DUTTON ROAD (WEST)

SCALE: 1" = 10'

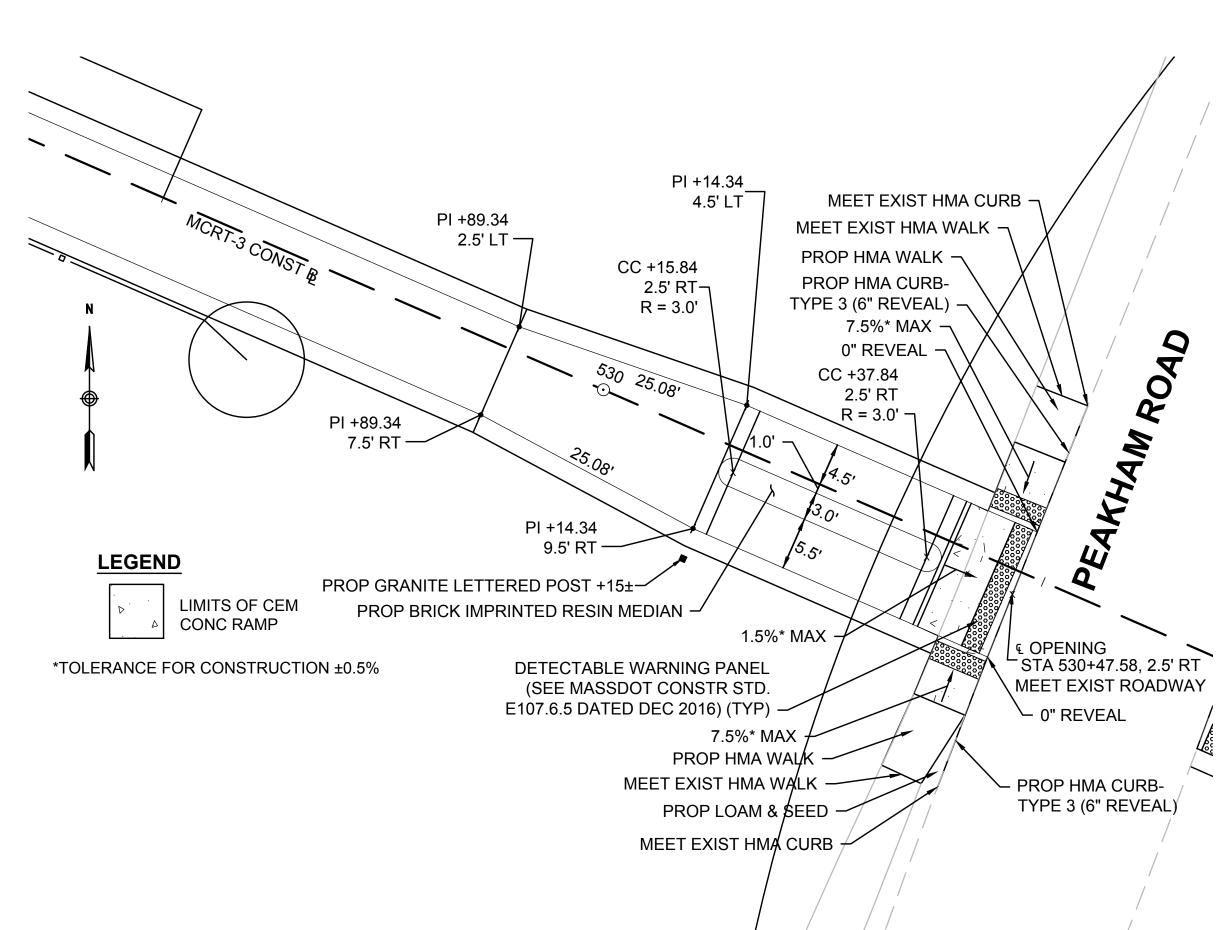


GATEWAY 11 - PEAKHAM ROAD (WEST)

SCALE: 1" = 10'

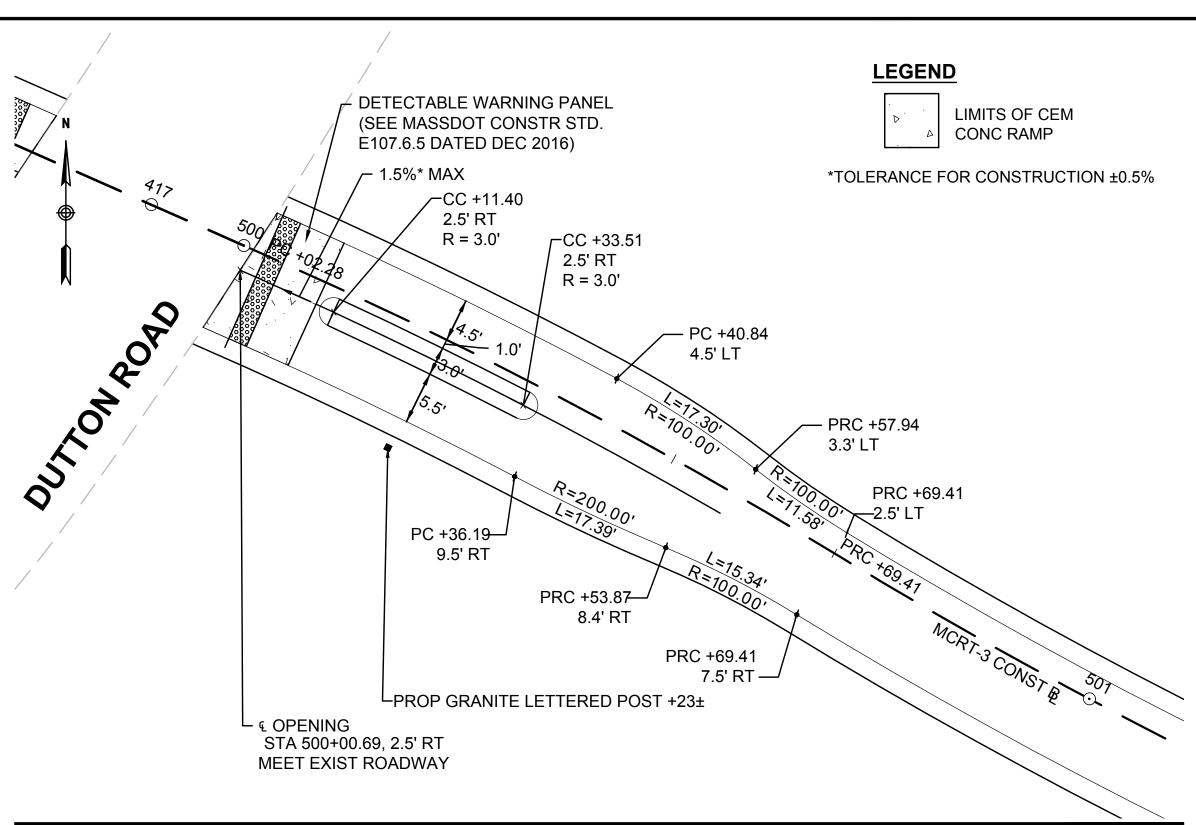


GATEWAY 10 - DUTTON ROAD (EAST)

SCALE: 1" = 10'

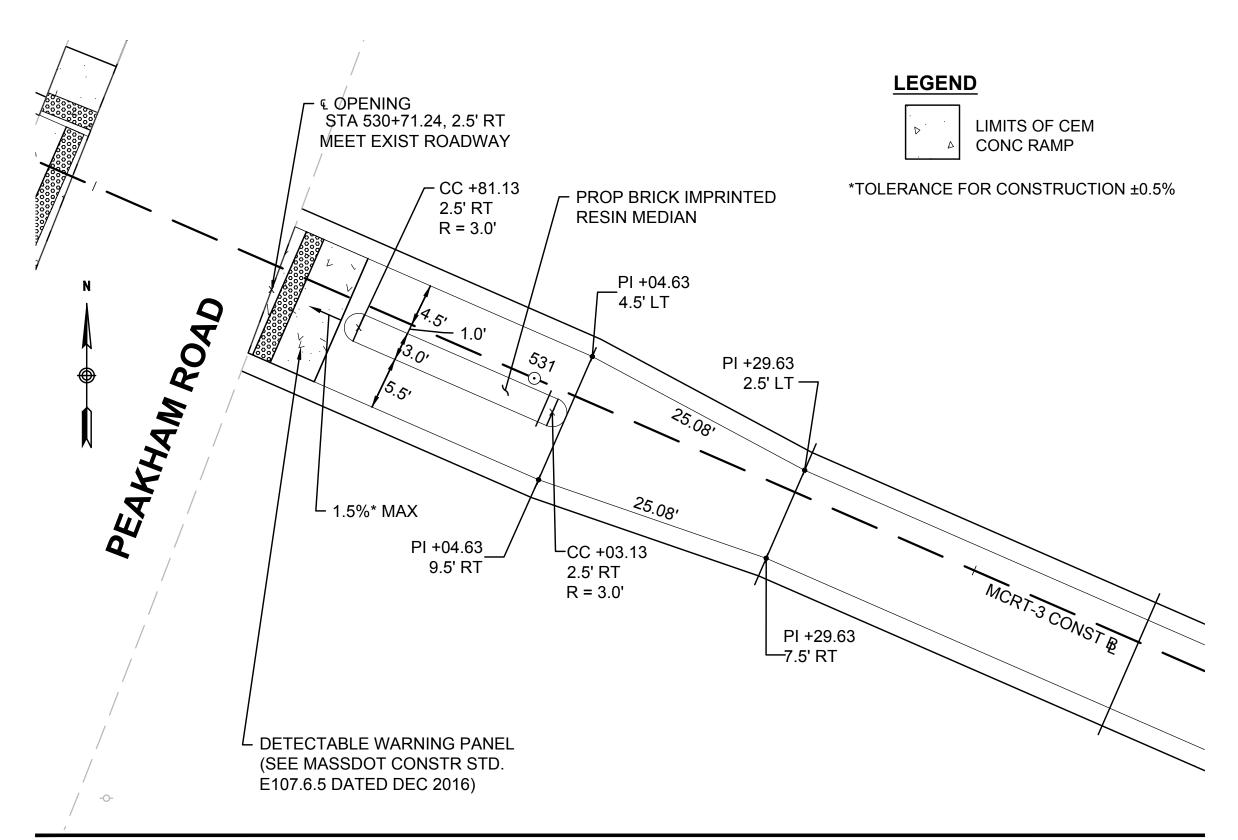

GATEWAY 12 - PEAKHAM ROAD (EAST)

SCALE: 1" = 10'

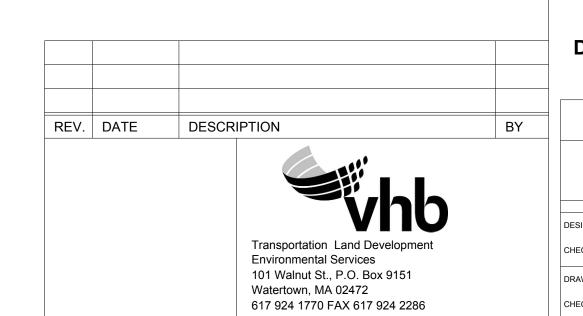

COMMONWEALTH OF MASSACHUSETTS DEPARTMENT OF CONSERVATION AND RECREATION DIVISION OF PLANNING AND ENGINEERING

MASS CENTRAL RAIL TRAIL - WAYSIDE

MASS CENTRAL RAIL TRAIL
HUDSON, STOW, MARLBOROUGH & SUDBURY, MA

DESIGNER:JCR CHECKED: SHK	GATEWAY DETAILS		SHEET NO
			GW-0
DRAWN: JCR	CONT. P19-3295-D1A	SCALE: 1" = 20'-0"	
CHECKED: TAL	ACC. XXXXXXX	DATE: JAN 2021	3 OF 5

